
LOCAL MAP - MYERSVILLE




MYERSVILLE COMMUNITY LIBRARY MYERSVILLE, MARYLAND

MYERSVILLE COMMUNITY LIBRARY

VICINITY MAP - FREDERICK COUNTY

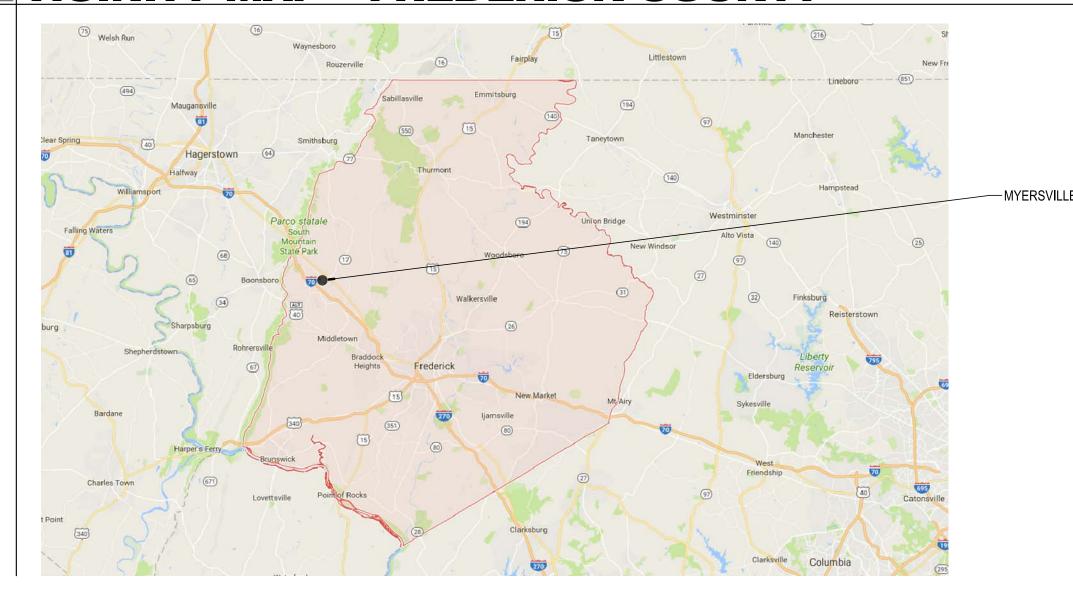

STATE MAP - MARYLAND

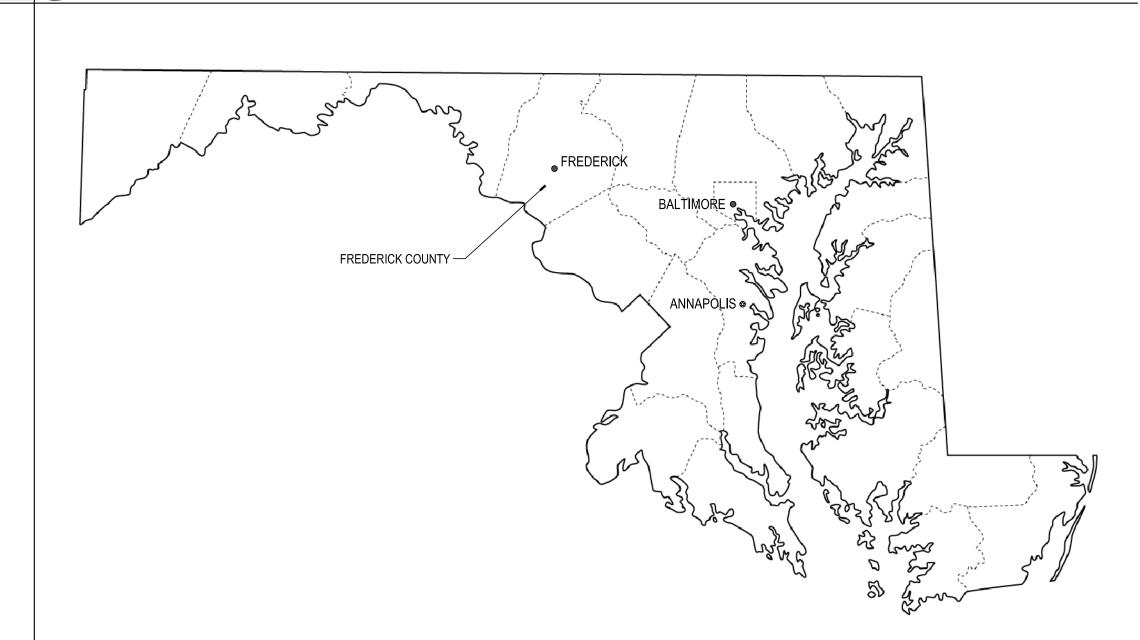

S	T OF DRAWINGS		
51 70	COVER SHEET	A200	REFLECTED CEILING PLAN, F AND DETAILS
<u>/IL</u>		A300	DOOR SCHEDULE, TYPES AN
1	COVER SHEET	A301	WINDOW TYPES AND DETAIL
2	TYPICAL SECTIONS, NOTES AND DETAILS	A400	EXTERIOR ELEVATIONS
3	DEMOLITION PLAN	A401	BUILDING SECTIONS
4	GRADING AND STORM DRAIN PLAN	A500	WALL SECTIONS
5	DIMENSION PAVING AND UTILITY PLAN	A501	WALL SECTIONS
3	ADD ALTERNATE PLANS	A502	WALL SECTIONS
7	WATER AND SEWER PROFILES	A503	WALL SECTIONS
3	STORM DRAIN PROFILES	A504	WALL SECTIONS
))	SEDIMENT AND EROSION CONTROL PLAN	A505	WALL SECTIONS
10	SEDIMENT AND EROSION CONTROL NOTES	A506	WALL SECTIONS
10	AND DETAILS	A507	WALL SECTIONS
11	STORM WATER MANAGEMENT PLAN	A600	DETAILS

- C-12 STORM WATER MANAGEMENT NOTES AND
- C-13 LANDSCAPE PLAN
- CA1 CODE ANALYSIS PLAN

A100 FLOOR PLAN AND LOFT PLAN

- AND DETAILS
- - A700 ENLARGED FLOOR PLANS INTERIOR ELEVATIONS AND CASEWORK
 - 1000 FINISH SCHEDULE AND FINISH PLANS STRUCTURAL

\$1.1 FOOTING AND FOUNDATION

- TYPICAL DETAILS S5.1 GENERAL NOTES

- M001 SYMBOLS, ABBREVIATIONS AND NOTES FIRST FLOOR PLAN-MECHANICAL
- PART PLAN LOFT-MECHANICAL FIRST FLOOR PLAN- MECHANICAL PIPING MECHANICAL DETAILS
- MECHANICAL SCHEDULES
- P001 PLUMBING SYMBOLS, ABBREVIATIONS
- P201 FLOOR PLANS PLUMBING P701 PLUMBING DETAILS AND SCHEDULES **ELECTRICAL**
- E001 SYMBOLS, ABBREVIATIONS AND NOTES E002 SITE PLAN- ELECTRICAL

- FIRST FLOOR PLAN-LIGHTING FIRST FLOOR PLAN-POWER AND SYSTEMS
- FIRST FLOOR PLAN- MECHANICAL POWER PART PLAN LOFT-ELECTRICAL
- FIRST FLOOR PLAN- FIRE ALARM
- LIGHTING SCHEDULE AND CONTROL
- E602 LIGHTING CONTROL DIAGRAMS
- SYMBOLS, ABBREVIATIONS AND NOTES

FREDERICK COUNTY DIVISION OF PUBLIC WORKS

REVIEWED:

Charles F. Nipe, Director

DATE

DATE

REVIEWED

Tyler Muntz, Project Manager

The above signatures are for the County's purposes of indicating the design complies with the program objectives and to authorize the project to proceed to the next stage in the construction procurement process. The review does not in any way relieve the Architect/Engineer of their responsibility for the professional quality, technical adequacy, and coordination of all designs, drawings, specifications, and other services furnished under this contract.

LIST OF ABBREVIATIONS

&	AND	CAB	C
L	ANGLE	CB	C
@	AT	CCT	C
q_	CENTERLINE	CEM	C
Ø	DIAMETER OR ROUND	CI	C
#	POUND OR NUMBER	CJ	C
		CLG	C
ACWW	ALUMINUM CLAD WOOD WINDOW	CLKG	C
ACOUS	ACOUSTICAL	CLO	C
AD	AREA DRAIN	CLR	C
ADJ	ADJUSTABLE	CMU	C
AFF	ABOVE FINISHED FLOOR	CNTR	C
ALUM	ALUMINUM	COL	C
APPROX	APPROXIMATE	CONC	C
ASB	ASBESTOS	CONN	C
ASP	ASPHALT	CONSTR	C
		CONT	C
BOC	BOTTOM OF CURB	CORR	C
BD	BOARD	CY	C
BOF	BOTTOM OF FOOTING		
BITUM	BITUMINOUS	DBL	
BLDG	BUILDING	DF	
BLK	BLOCK	DET	
BM	BEAM	DIA	
BOT	BOTTOM	DIM	
BRT	BEARING	DISP	

BRICK

BETWEEN

BRK

B/W

CATCH BASIN CUBICLE CURTAIN TRACK CAST IRON **CONTROL JOINT** CAULKING CLOSET CLEAR CONCRETE MASONRY UNIT COUNTER COLUMN CONCRETE CONNECTION CONSTRUCTION CONTINUOUS CORRIDOR CUBIC YARD

EMER DOUBLE DRINKING FOUNTAIN DETAIL DIAMETER **DIMENSION DISPENSER** DOWN DOOR DOWNSPOUT DUMBWAITER DRAWING

ELECTRICAL CONTRACTOR ELEVATION **EMERGENCY** EQUIPMENT EXPOSED STRUCTURE EXISTING TO REMAIN EXISTING EXISTING EXPANSION EXTERIOR HDCP ELECTRIC WATER COOLER HDWD HGT FOUNDATION HOR FIRE EXTINGUISHER

EACH

FIRE HOSE CABINET

FLOOR

FACE OF

FIRE RATING

FOOT OR FEET

FLOURESCENT

GALVANIZED GROUND GRADE HOLLOW CORE HANDICAP HARDWOOD HOLLOW METAL HORIZONTAL FIRE EXTINGUISHER CABINET ID INSULATED HOLLOW METAL INSULATION INT INTERIOR INV INVERT INSULATED TEMPERED PLATE GLASS NTS FIRE RATED GLAZING SYSTEM JAN FIRE RETARDANT TREATED JOINT

KITCHEN

MECHANICAL CONTRACTOR MECH MECHANICAL MEMBRANE MEMB MANUFACTURE MANHOLE MINIMUM MIRROR MISCELLANEOUS MASONRY OPENING MOISTURE RESISTANT MTD MOUNTED MULLION

NOT IN CONTRACT

NUMBER

NOMINAL

OPENING

OPPOSITE

OPNG

NOT TO SCALE

OUTSIDE DIAMETER

ON CENTER

POINT ROD & SHELF R&S RADIUS ROOF DRAIN RECEPTACLE REFRIGERATOR REINFORCED REQUIRED ROOM ROUGH OPENING SEALED CONCRETE SCHEDULE SECTION SHOWER SHEET SIMILAR SPECIFICATIONS

SLAB ON GRADE

SQUARE

SOG

STAINLESS STEEL STRUCTURAL SYSTEM TOP OF CURB TELEPHONE TOF TOP OF FOOTING TONGUE & GROOVE THICK TOP OF TOP OF WALL TOP OF PAVEMENT TEMPERED PLATE GLASS TELEVISION THRU WALL FLASHING

UNDERCUT

UNFINISHED

URINAL

UON

UNIT DIMENSION

UNLESS OTHERWISE NOTED

VENTILATED VERTICLE VESTIBULE VINYL COATED GYPSUM BOARD WIRED GLASS WITHOUT WAINSCOAT WEIGHT WELDED WIRE FABRIC

TOILET ACCESSORY (H1)—— WINDOW DETAILING WINDOW TYPE STOREFRONT TYPE WINDOW GLAZING APPLIANCE TYPE **DEMOLITION NOTE** (COL) COLUMN BUBBLE

ROOM NUMBER

DOOR MARK

1 PARTITION TYPE

SYMBOLS & MATERIALS KEY BUILDING SECTION KEY OR

ELEVATION KEY CONTROL OR WORK POINT REVISION OCCUPANT COUNT

OCCUPANT LOAD

CONCRETE BLOCK

ROUGH WOOD OR BLOCKING CONTINUOUS WOOD BLOCKING **BATT INSULATION** ACOUSTICAL TILE RIGID INSULATION PLYWOOD

MYERSVILLE

COMMUNITY **LIBRARY**

8 HARP PLACE MYERSVILLE, MD 21773

PROJECT OWNER FREDERICK COUNTY, **MARYLAND** DEPARTMENT OF PUBLIC **WORKS**



ASSOCIATES, INC.


ARCHITECTS

ABEL CONSULTING ENGINEERS 9055 COMPRINT COURT, SUITE 370 | GAITHERSBURG, MD | 20878

CJL ENGINEERING 3 WEST SECOND STREET | FREDERICK, MD | 00000-0000 P: 301.695.9424 | F: 301.293.6338

P: 301.662.4488 | F: 301.662.4906

CIVIL ENGINEER HARRIS, SMARIGA & ASSOCIATES, INC. 125 SOUTH CARROLL STREET | FREDERICK, MD | 21701

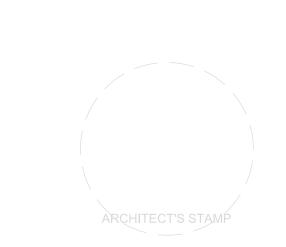

SHEET INFORMATION <u>KEY PLAN</u>

PROJECT STATUS

JOB NUMBER: 10 APRIL 2018 ISSUE DATE: AS INDICATED SHEET TITLE: **COVER SHEET** SHEET NUMBER:


SWM DEVELOPMENT / IMPROVEMENT PLANS

FOR

MYERSVILLE LIBRARY

Sheet List Table Sheet Number Sheet Title COVER SHEET TYPICAL SECTIONS, NOTES, AND DETAILS C-2C-3DEMOLITION PLAN C-4GRADING AND STORM DRAIN PLAN DIMENSION PAVING AND UTILITY PLAN C-5 C-6 ADDITIONAL PARKING AND HARP PLACE MILL AND OVERLAY PLANS C-7WATER AND SEWER PROFILES C-8 STORM DRAIN PROFILES C-9 SEDIMENT AND EROSION CONTROL PLAN SEDIMENT AND EROSION CONTROL NOTES AND DETAILS C-10 STORMWATER MANAGEMENT PLAN C-11 STORMWATER MANAGEMENT NOTES AND DETAILS C-12 C-13 LANDSCAPE PLAN

LEGEND

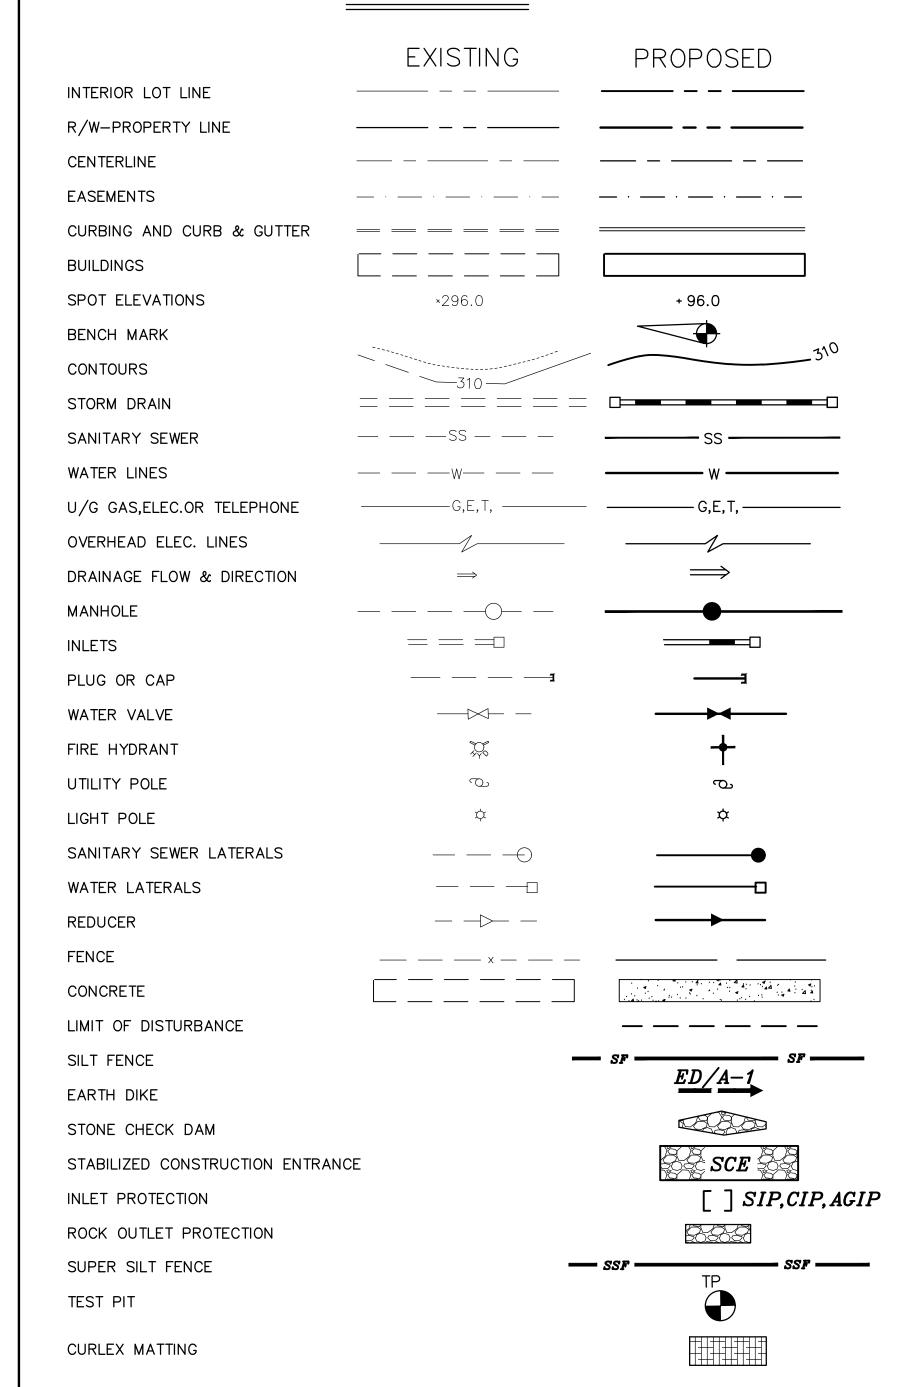

PREPARED FOR: OWNER / DEVELOPER:

28643

ENGINEERS CERTIFICATION I HEREBY CERTIFY TO THE BEST OF MY KNOWLEDGE AND 2011 MARYLAND STANDARDS AND SPECIFICATIONS FOR REG. NO.

FREDERICK COUNTY PUBLIC LIBRARY IN MYERSVILLE, MARYLAND, AND PROVIDE ADDITIONAL PARKING FOR THE ADJACENT MYERSVILLE COMMUNITY PARK

NOTE: THERE IS NO 100-YR FLOODPLAIN SHOWN PER FEMA MAP #24021C0115D, DATED SEPT. 19, 2007. NO WETLANDS ON SITE PER NATIONAL WETLANDS INVENTORY.

THE TOTAL AREA TO BE DISTURBED SHOWN ON THESE PLANS HAS BEEN DETERMINED TO BE APPROXIMATELY 79,658 SQ.FT. (1.83 AC.) AND THE TOTAL AMOUNT OF EXCAVATION AND FILL AS SHOWN ON THESE PLANS HAS BEEN COMPUTED TO BE APPROXIMATELY 1,985 CU.YDS. OF EXCAVATION AND APPROXIMATELY 310 CU.YDS. OF FILL. PRINT NAME: MALLE A MUCELY DISTURBED AREA QUANTITY NOT FOR BIDDING PURPOSES

TELEPHONE

OWNER/DEVELOPER CERTIFICATION

BEGINNING THE PROJECT.

PROFESSIONAL ENGINEER.'

(SIGNATURE)

PERSONNEL INVOLVED IN THE CONSTRUCTION PROJECT WILL HAVE A CERTIFICATE OF ATTENDANCE AT A DEPARTMENT OF NATURAL RESOURCES APPROVED TRAINING PROGRAM

FOR THE CONTROL OF SEDIMENT AND EROSION BEFORE


"I/WE UNDERSTAND THAT AS-BUILT PLANS MUST BE


SUBMITTED AND APPROVED FOLLOWING CONSTRUCTION

OF THE STORM WATER MANAGEMENT POND AND THAT

OWNER/DENELOPER (NAME & TITLE PRINTED)

CONSTRUCTION MUST BE SUPERVISED BY A REGISTERED

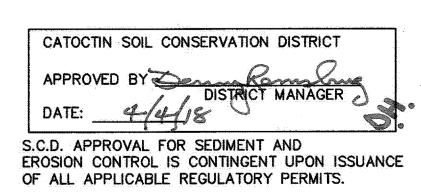

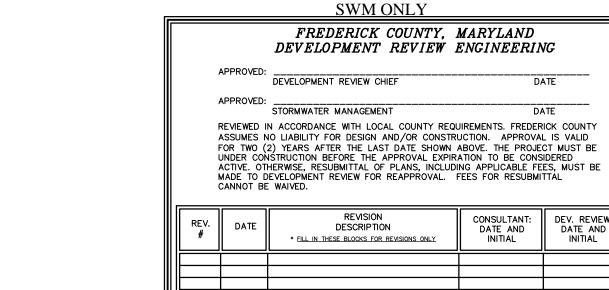

CDD-Dev. Review

JANUARY 2018

FREDERICK COUNTY C/O TYLER MUNTZ WINCHESTER HALL 12 E.CHURCH ST. FREDERICK, MD 21701


THAT THE PLANS HAVE BEEN DESIGNED IN ACCORDANCE WITH LOCAL ORDINANCES, COMAR 26.17.01 SOIL EROSION AND SEDIMENT CONTROL.

PREPARED BY:



FREDERICK MARYLAND 21701 P. 301.662.4488 F. 301.662.4906 www.harrissmariga.com

125 S. CARROLL STREET

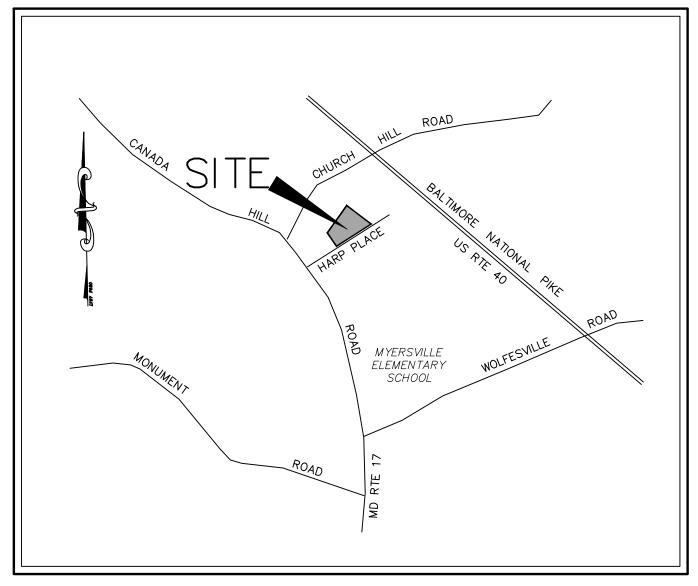

SCALE 1"=1,000'± TAX MAP 70 P/O PARCEL 320 TAX ID #16-355941

PROJECT DESCRIPTION: THE PURPOSE OF THIS PROJECT IS TO PROVIDE A NEW

2-20-18 MYERSVILLE PLANNING COMMISSION CHAIRMAN



Professional Certification. I hereby certify that these am a duly licensed professional engineer under the laws of the State of Maryland.

License No. 28643 Expiration Date <u>3-26-19</u>

REV. #: DESCRIPTION:

PROJECT STATUS

PROJECT INFORMATION

PROJECT TITLE

MYERSVILLE

COMMUNITY

LIBRARY

8 HARP PLACE **MYERSVILLE. MD 21773**

PROJECT OWNER

FREDERICK COUNTY,

MARYLAND

DEPARTMENT OF PUBLIC

WORKS

PROJECT TEAM

<u>ARCHITECT</u>

6 NORTH EAST STREET, SUITE 300 FREDERICK, MD | 21701-5680

P: 301.662.8611 | F: 301.662.8632 NOELKERHULL.COM

PA | MD | VA

STRUCTURAL ENGINEER

ABEL CONSULTING ENGINEERS

9055 COMPRINT COURT, SUITE 370 | GAITHERSBURG, MD | 20878

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3 WEST SECOND STREET | FREDERICK, MD | 00000-0000

P: 301.695.9424 | F: 301.293.6338

CIVIL ENGINEER

HARRIS, SMARIGA & ASSOCIATES, INC.

125 SOUTH CARROLL STREET | FREDERICK, MD | 21701

P: 301.662.4488 | F: 301.662.4906

SHEET INFORMATION

JOB NUMBER: ISSUE DATE: 10 APRIL 2018 SCALE: SHEET TITLE: SHEET NUMBER: © COPYRIGHT 2018 NOELKER AND HULL ASSOCIATES, INC

GENERAL NOTES

AND 'MYERS AZ'. 2. VERTICAL DATUM NAVD 88, PER SAME SAME MONUMENTS IN NOTE 1 ABOVE. 3. ONSITE TOPOGRAPHY IS FIELD RUN BY HSA AUGUST, 2017.

CONSTRUCTION. ANY UTILITY (WHETHER SHOWN OR NOT) DAMAGED DUE TO CONSTRUCTION SHALL BE REPAIRED IMMEDIATELY. ANY EXISTING FIRE HYDRANTS, MANHOLES, ETC. TO BE RAISED OR LOWERED ARE TO BE DONE SO BY CONTRACTOR. THE CONTRACTOR SHALL BE RESPONSIBLE FOR REMOVING AND REPLACING ANY EXISTING FENCES, DRIVEWAYS, ETC. DAMAGED OR REMOVED BY HIM DURING CONSTRUCTION. ALL OFF SITE
DISTURBED AREAS SHALL BE RETURNED TO A STABLE, NON-ERODABLE CONDITION. 5. CONTRACTOR SHALL TEST PIT IN THE AREA OF KNOWN EXISTING

PERFORMING ANY WORK, UTILITY RELOCATIONS, WHETHER SHOWN ON THE PLANS OR DISCOVERED IN THE FIELD, ARE THE RESPONSIBILITY OF THE OWNER. PRIOR TO PERFORMING ANY WORK, THE OWNER AND THE CONTRACTOR SHALL NEGOTIATE A COST FOR DISCOVERED UTILITY WORK.

TO START OF CONSTRUCTION. 7. ALL CONSTRUCTION TO CONFORM TO THE LATEST FREDERICK

SPECIFICATIONS, THE BETTER QUALITY OR GREATER QUANTITY OF WORK OR MATERIALS SHALL BE USED FOR BIDDING THE WORK AND SHALL BE PROVIDED BY THE CONTRACTOR.

FREDERICK COUNTY WATER AND SANITARY SEWER STANDARDS AND SPECIFICATIONS. 9. ALL CONSTRUCTION WITHIN THE MARYLAND STATE HIGHWAY ADMINISTRATION RIGHT-OF-WAY SHALL BE IN CONFORMANCE WITH THE LATEST REQUIREMENTS OF THE MARYLAND STATE HIGHWAY ADMINISTRATION'S STANDARDS AND SPECIFICATIONS FOR CONSTRUCTION AND MATERIALS AND THE ISSUED ACCESS PERMIT, DISTRICT PERMITS, AND/OR UTILITY PERMIT. PER UTILITY

11. GUTTERS AND PAVING SHALL BE INSTALLED IN SUCH A MANNER AS TO INSURE POSITIVE DRAINAGE IN ALL AREAS, AS SHOWN. STANDARD GUTTER CROSS SLOPE SHALL BE REVERSED TO SLOPE AWAY IN SOME AREAS TO CONFORM TO NEW GRADING AS SHOWN ON PLANS. CONTRACTOR IS RESPONSIBLE FOR STRING LINING THE TOP OF CURB PROFILE TO ENSURE NO IRREGULAR HIGH OR LOW SPOTS ARE CREATED PRIOR TO POURING

12. THE CONTRACTOR SHALL BE RESPONSIBLE FOR KEEPING SILT AND DEBRIS OUT OF THE EXISTING STORM DRAIN SYSTEM DURING CONSTRUCTION AND SHALL CLEAN THE SYSTEM THOROUGHLY PRIOR TO FINAL ACCEPTANCE BY THE COUNTY AND THE

ONSTRUCTION THE CONTRACTOR ASSUMES ALL RESPONSIBILIT WITH ALL CODE REQUIREMENTS.

14. HARRIS, SMARIGA & ASSOCIATES, INC. HAS NOT PERFORMED ANY SUBSURFACE INVESTIGATION TO DETERMINE LOCATIONS OF ROCK, DIFFERENT SOIL TYPES, WATER TABLE, UTILITIES, ETC.

OPERATION SHALL BE REPLACED TO AN EQUAL DEPTH (6" MIN.) OR 16. THE CONTRACTOR SHALL BE RESPONSIBLE FOR MAINTENANCE OF

17. DIFFERING PLAN AND FIELD CONDITIONS: THE ENGINEER IS TO BE NOTIFIED IMMEDIATELY TO RESOLVE THE SITUATION. SHOULD THE CONTRACTOR AND/OR OWNER MAKE FIELD CORRECTIONS OR ADJUSTMENTS WITHOUT NOTIFYING THE ENGINEER. THEN THOSE

19. IT SHALL BE DISTINCTLY UNDERSTOOD THAT FAILURE TO MENTION SPECIFICALLY ANY WORK WHICH WOULD NATURALLY BE

20. PROVIDE DEPRESSED CURB AND HANDICAP RAMPS AT ALL ROAD AND STREET INTERSECTIONS WITH CURBING AND SIDEWALK AND AT ALL HANDICAP PARKING SPACES. PROVIDE HANDICAP SIGNS AT EACH HANDICAP PARKING SPACE. ALL CONSTRUCTION SHALL CONFORM TO STATE OF MARYLAND CODE FOR THE HANDICAPPED

FROM EXISTING TO PROPOSED PAVING SECTION.

FREDERICK COUNTY DIVISION OF HIGHWAY OPERATIONS FOR THE INSTALLATION OF UTILITIES, STORM DRAINS, ETC. TELEPHONE


23. THE CONTRACTOR SHALL PROVIDE A WATERTIGHT CONNECTION OF THE PROPOSED SANITARY SEWER TO THE EXISTING MANHOLE AND REBUILD MANHOLE CHANNEL AS OR IF DIRECTED BY THE ENGINEER.

25. SOME AREAS OF THE MONOCACY VALLEY HAVE KNOWN LIMESTONE FORMATIONS WITH SOLUTION CAVITIES (SINKHOLES) EVALUATE SUBSURFACE CONDITIONS DURING CONSTRUCTION. THE GEOTECHNICAL ENGINEER SHALL RECOMMEND CORRECTIVE

OWNER AND/OR HIS WETLAND CONSULTANT. HARRIS, SMARIGA & ASSOCIATES, INC. ASSUME NO RESPONSIBILITY FOR ITS EXISTENCE, ACCURACY, LOCATION, OR DETERMINATION. ANY WORK IN THE WETLANDS AND/OR ITS BUFFER SHOWN ON THIS PLAN OR RESULTING FROM EXISTING FIELD CONDITIONS REQUIRES A WETLAND PERMIT; APPLICATION FOR THIS PERMIT SHALL BE THE RESPONSIBILITY OF THE OWNER.

CONTRACTOR SHALL HAVE THE WASHINGTON GAS COMPANY (301-662-2151) VERIFY THAT NO LEAKS EXIST PRIOR TO ANY WORK IN THE AREA. A GAS COMPANY REPRESENTATIVE MUST BE PRESENT AT THE PROJECT SITE BEFORE ANY BLASTING WITHIN 20 FEET OF GAS LINES. ANY EXCAVATION WITH 5 FEET OF GAS LINES SHALL BE DONE BY HAND (NO MACHINERY). THE DEVELOPER OR THE DEVELOPER'S REPRESENTATIVE SHALL OBTAIN APPROVAL FROM THE GAS COMPANY FOR ANY WORK WITHIN A GAS LINE EASEMENT AREA.

INSTALLED IN ACCORDANCE WITH M.S.H.A. STANDARDS. 29. TRASH TO BE PICKED UP BY A PRIVATE CONTRACTOR AT THE DUMPSTER LOCATION SHOWN ON THE PLAN WHEN THE FACILITY IS OCCUPIED BY OWNER.

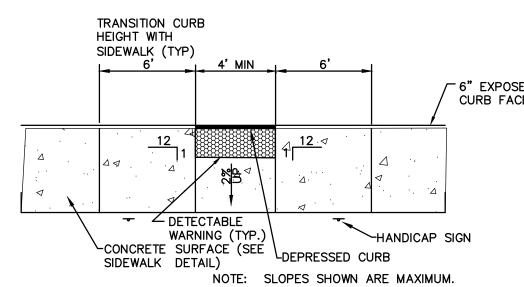

ASPHALT PAVEMENT

NOTE:

1. FILL AREAS TO BE PAVED SHALL HAVE SOIL PLACED IN 8"LIFTS & COMPACTED

TO 95% OF MAX. DENSITY. THE LAST TWO LIFTS SHALL BE COMPACTED TO

2. AFTER THE SUBGRADE IN CUTS & FILLS HAS BEEN FINALLY SHAPED TO THE SPECIFIED

TON ROLLER OR EQUIVALENT TO DETERMINE SOFT OR UNSUITABLE AREAS. PRIOR TO PAVING, SOFT OR UNSUITABLE AREAS SHALL BE REMOVED & BACKFILLED WITH SUITABLE

CROSS SECTION, IT SHALL BE CAREFULLY & THOROUGHLY PROOF ROLLED WITH A 20

3. NO PAVEMENT SHALL BE PLACED ON FROZEN OR FROSTED SUBGRADE NOR ON SUBGRADES

4. IF ROCK IS ENCOUNTERED IN THE SUBGRADE, REMOVE AN ADDITIONAL 6"BELOW SUBGRADE

ON-SITE

PAVING SECTIONS

Pavement sections (bituminous and concrete) shown on this plan are from a Geotechnical report entitled "Revised

Geotechnical Engineering Report, Myersville Library" prepared by ECS Mid-Atlantic, LLC, dated December 13, 2017

& BACKFILL WITH SUITABLE MATERIAL TO THE REQUIREMENTS ON NO. 1 ABOVE

and revised January 17, 2018. HSA, Inc. assumes no responsibility for pavement design.

100% OF MAX. DENSITY. MAXIMUM DENSITY SHALL BE DETERMINED IN

ACCORDANCE WITH AASHTO T-99 METHOD C.

MATERIAL TO THE REQUIREMENTS OF NO.1 ABOVE.

THAT WILL NOT ADEQUATELY SUPPORT THE PAVEMENT.

2" SURFACE COURSE

PG 64-22, LEVEL 2)

PG 64-22, LEVEL 2))

AGGREGATE FOR BASE

COURSE (GAB OR CR-6)


PREPARED SUBGRADE DESIGN

(HMA-SUPERPAVE 25mm,

4" BASE COURSE

6" MSHA GRADED


(HMA -SUPERPAVE 12.5mm,

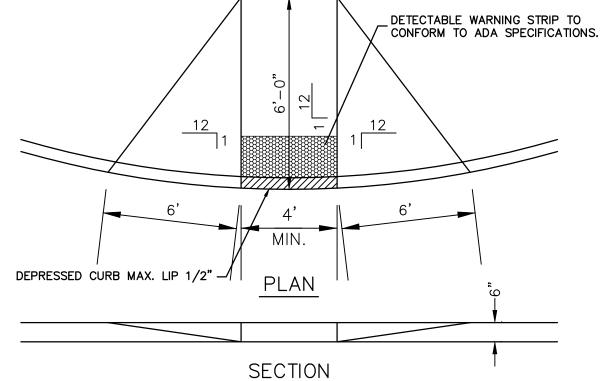


HANDICAP RAMP DETAIL

BICYCLE RACK DESIGNS PREFERRED "U Rack" DESIGN

'U-SHAPED' BICYCLE RACK DETAIL (OR APPROVED EQUAL) N.T.S.

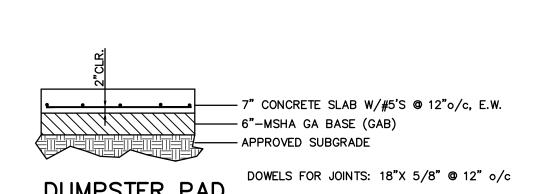

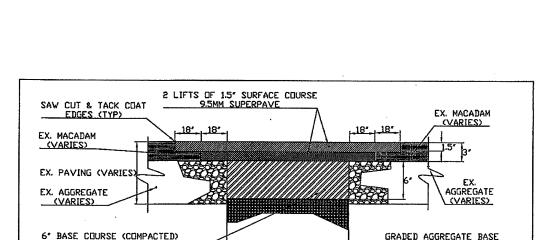

FULL TRENCH DEPTH
COMPACTED IN 8' LIFTS Utility Trench Backfill/Pavement Repair Detail Not To Scale NOTES: 1. BASE COURSE AND AT LEAST ONE SURFACE COURSE LAYER TO BE DONE IN SAME DAY. 2. FINAL SURFACE COURSE LAYER SHALL BE DONE WITHIN 5 CALENDAR DAYS OF THE INITIAL 3. EXISTING PAVEMENT EDGES TO BE SAW CUT (OR MILLED) TO PROVIDE A VERTICAL SURFACE 4. ALL VERTICAL EDGES OF THE REPAIR AREA SHALL BE TACKED BEFORE PLACEMENT OF THE SURFACE COURSE. 5. THE CONTRACTOR IS REQUIRED TO APPLY FOR AND OBTAIN A FREDERICK COUNTY "UTILITIES IN THE RIGHT-OF-WAY" PERMIT PRIOR TO COMMENCING WORK WITHIN THE COUNTY ROADWAYS OR RIGHT-OF-WAY. ENSURE THAT ALL TRENCH BACKFILL, ETC. IS SPECIFIED TO COMPLY WITH THE CONDITIONS

6. NOTE THAT THE SURFACE COURSE MILLING WILL BE DETERMINED BASED ON THE ROAD


SPECIFICATIONS FOR PLACEMENT OF UTILITIES WITHIN COUNTY RIGHT OF WAY".


7. FOR ADDITIONAL DETAIL AND SPECIFICATIONS REFFER TO "FREDERICK COUNTY

AGE WHICH WILL BE NOTED ON THE PERMIT.




Professional Certification. I hereby certify that these documents were prepared or approved by me, and that I am a duly licensed professional engineer under the laws of the State of Maryland. License No. 28643 Expiration Date 3-26-19

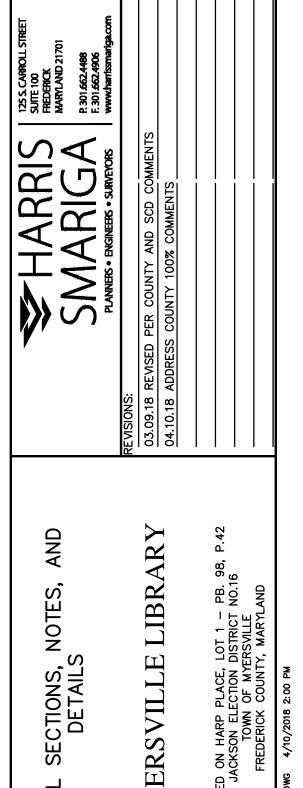

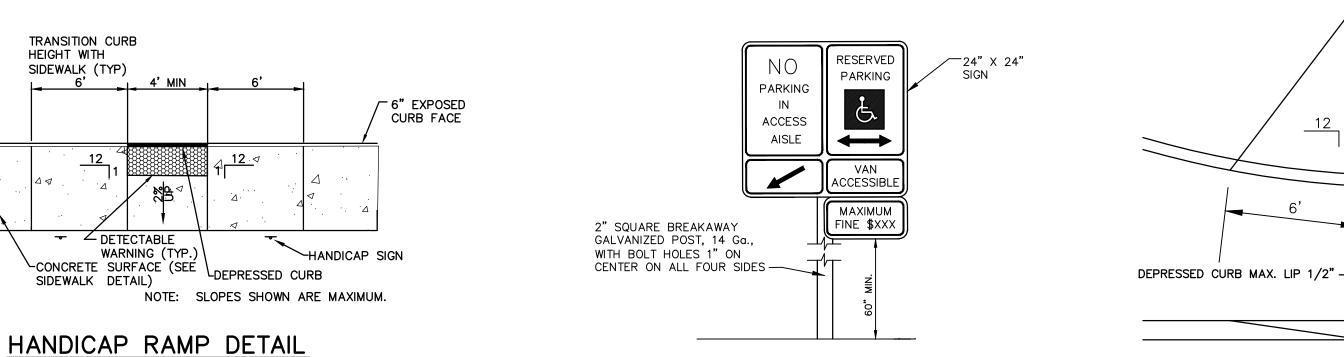

ON-SITE HANDICAP SIGN DETAIL

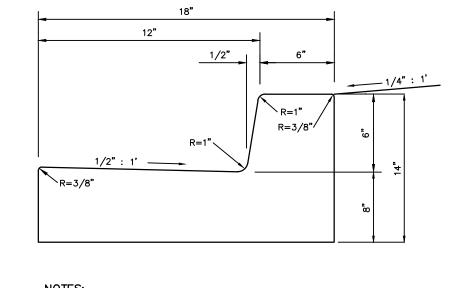

VARIES SEE PLAN (5' MIN.)

~1/8"R (TYP.)

~~4X4-W1.4XW1.4

<u></u>4"− # 57 STONE

----APPROVED SUBGRADE

1. BROOM THE SURFACE WITH A FINE-HAIR BROOM

AT RIGHT ANGLES TO CENTER LINE, TOOL ALL

BITUMINOUS MATERIAL SHALL BE PLACED AT

20 FT. SPACING & BETWEEN THE SIDEWALK

4 AFTER FINISHING, APPLY AN APPROVED CURING

5. PATTERN SIDEWALK FORMS TO BE SPECIFIED

COMPOUND. PROTECT SIDEWALK FOR 7 DAYS.

ON-SITE SIDEWALK DETAIL

3. MARK THE WALK AT 5' INTERVALS WITH A

EDGES, JOINTS AND MARKINGS.


AND BUILDINGS OR STRUCTURES.

BY OWNER.

2. EXPANSION JOINTS OF 1/2"(MIN.) RIGID


MSHA MIX NO. 2 CONCRETE. STEEL TROWEL AND BRUSH FINISH. CONCRETE SHALL BE SPRAYED WITH LIQUID CURING COMPOUND. 4. NOSE DOWN FREE ENDS OF CURBING IN LAST 4' FT.

STANDARD CURB & GUTTER

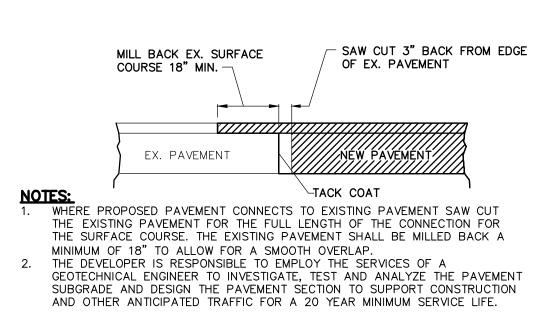

TIE IN TO EX. PAVEMENT



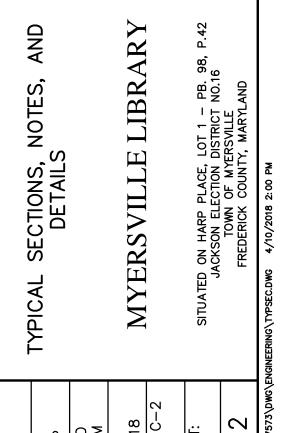

1. HORIZONTAL DATUM: MD STATE PLANE, NAD 83/91. PER COUNTY MONUMENTS 'MYERS"

4. EXISTING UTILITIES SHOWN ARE ASBUILT LOCATIONS BY HSA, INC. CONTRACTOR SHALL FIELD VERIFY ALL LOCATIONS AND ELEVATIONS PRIOR TO

UTILITIES TO VERIFY SIZE, LOCATION AND TYPE PRIOR TO

6. CONTRACTOR SHALL NOTIFY MISS UTILITY 1-800-257-7777 (A MINIMUM OF 5 WORKING DAYS) AND THE FREDERICK COUNTY ENVIRONMENTAL COMPLIANCE SECTION AT 301-600-3507, AND CONSTRUCTION MANAGEMENT AT 301-600-2079) 48 HOURS PRIOR

COUNTY STANDARDS AND SPECIFICATIONS, SHOULD THE DRAWINGS DISAGREE WITH THEMSELVES, OR WITH THE

8. ALL WATER AND SEWER CONSTRUCTION SHALL BE IN ACCORDANCE WITH THE PERMIT REQUIREMENT, THE CONTRACTOR SHALL BE NAMED AS THE TRAFFIC CONTROL

10. WHEN REMOVING EXISTING CURB, GUTTER, OR SIDEWALK, REMOVE TO THE NEAREST JOINT.

CURB. IF IRREGULARITIES EXIST, CONTACT ENGINEER FOR RESOLUTION.

13. HARRIS, SMARIGA & ASSOCIATES, INC. IS NOT RESPONSIBLE FOR THE CONTRACTOR'S UTILIZATION OF MEN, MATERIALS, EQUIPMENT OR SAFETY MEASURES IN PERFORMANCE OF ANY WORK FOR THIS FOR PERFORMING THE WORK CORRECTLY AND IN CONFORMANCE

15. ALL EXISTING PAVING DISTURBED BY THE CONTRACTOR'S

TRAFFIC ON ANY EXISTING ROADS OR ACCESS TO ANY EXISTING HOUSES IN ACCORDANCE WITH MUTCD, LATEST EDITION. THE CONTRACTOR WILL HAVE READY ACCESS TO WATER TRUCK AND POWER BROOM TO CLEAN HARP PLACE AS NECESSARY DURING CONSTRUCTION.

PARTIES ASSUMES ALL RESPONSIBILITY FOR THOSE CHANGES. 18. THE CONTRACTOR SHALL NOTE THAT IN THE CASE OF A DISCREPANCY BETWEEN THE SCALED AND FIGURED DIMENSIONS SHOWN ON THESE PLANS, THE FIGURED DIMENSION SHALL GOVERN.

REQUIRED TO COMPLETE THE PROJECT SHALL NOT RELIEVE THE CONTRACTOR OF HIS RESPONSIBILITY TO PERFORM SUCH WORK.

AND THE AMERICANS WITH DISABILITIES ACT (ADA), WHERE APPLICABLE. 21. FIELD ADJUSTMENTS SHALL BE MADE AS NECESSARY TO PROVIDE A SMOOTH TRANSITION BOTH VERTICALLY AND HORIZONTALLY

22. EXCAVATION WITHIN A COUNTY ROAD RIGHT-OF-WAY WILL NOT BE ALLOWED WITHOUT OBTAINING A PERMIT FROM THE


24. FINAL LOCATION OF FIRE HYDRANTS WILL BE DETERMINED IN THE FIELD.

HARRIS, SMARIGA & ASSOCIATES RECOMMENDS THAT THE OWNER RETAIN THE SERVICES OF A GEOTECHNICAL ENGINEER TO MEASURES IF SOLUTION CAVITIES ARE ENCOUNTERED.

26. THE WETLAND LIMITS, IF SHOWN HEREON, WERE SUPPLIED BY THE 27. WHEN WORKING IN THE AREA OF ANY EXISTING GAS LINE, THE

28. THE GUARDRAIL LIMITS WILL BE DETERMINED IN THE FIELD BASED ON "AS-BUILT" CONDITIONS, IF NECESSARY. GUARDRAIL WILL BE

30. ALL PARKING ISLAND RADII ARE 4.5' UNLESS NOTED OTHERWISE. 31. FOR FINAL POLE LOCATIONS AND CONDUIT ROUTING, SEE ELECTRICAL PLAN PREPARED BY THE MEP ENGINEER.

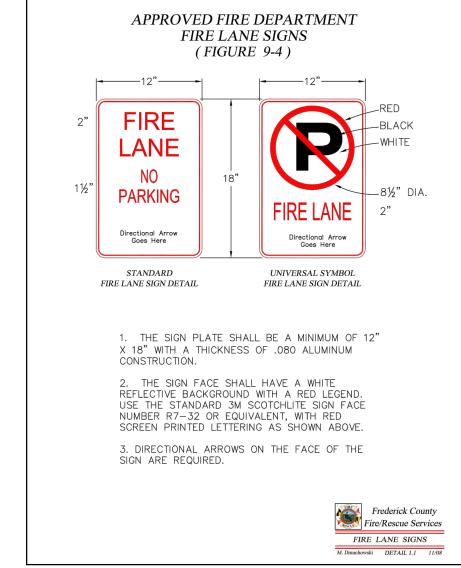

FIRE/RESCUE NOTES

FIRE DEPARTMENT ACCESS ROADS SHALL BE ACCESSIBLE DURING ALL TYPES OF WEATHER AND AT FIRE DEPARTMENT ACCESS ROADS SHALL BE CAPABLE OF SUPPORTING FIRE APPARATUS AT ALL TIMES AND BE A MINIMUM OF 20' WIDE. FIRE DEPARTMENT ACCESS ROADS SHALL BE PROVIDED AND MAINTAINED TO ALL STRUCTURES UNDERGOING CONSTRUCTION, ALTERATION OR DEMOLITION. THE ACCESS ROADWAYS SHALL PROVIDE A MINIMUM TURNING RADII OF 40-45 FEET. FIRE LANES SHALL BE ESTABLISHED BY THE FIRE MARSHAL DURING CONSTRUCTION AND BEFORE THE PROPERTY ADDRESSES SHALL BE INCORPORATED INTO THE SITE SIGN AND SHALL BE POSTED ON EACH BUILDING IN ACCORDANCE WITH THE FREDERICK COUNTY PREMISE IDENTIFICATION ORDINANCE #05-01-362. A COPY OF THE ORDINANCE IS AVAILABLE AT: HTTP: //www.co.frederick.md.us/info/pdf_files/premiseordinance.pdf AN ACCESS BOX (KNOX BOX) FOR FIRE DEPARTMENT USE SHALL BE INSTALLED NEAR THE MAIN ENTRANCE OF THE MAIN BUILDING IN ACCORDANCE WITH THE PROVISIONS OF NFPA #1, THE UNIFORM FIRE CODE SECTION 18.2.2. DUE TO THE SIZE OF THE BUILDING AND SINCE THERE IS FIRE

DEPARTMENT ACCESS IN THE REAR OF THE BUILDING, AN ADDITIONAL KNOX BOX(ES) SHALL BE

DUMPSTER ENCLOSURE DETAILS

SCALE 1"=10'

NOTE: DUMPSTER IS CONCEPTUAL, CONTRACTOR TO SUBMIT SHOP DRAWINGS FOR APPROVAL

PROVIDED AT APPROVED LOCATIONS. IF APPLICABLE, ANY GATES IN FENCED ENCLOSURES SHALL HAVE A KNOX PAD LOCK INSTALLED. PLOWABLE FIRE HYDRANT MARKERS SHALL BE INSTALLED TO IDENTIFY THE LOCATIONS OF HYDRANTS. MARKERS SHALL BE PLACED SIX INCHES FROM THE EDGE OF THE PAINTED CENTERLINE OR FROM THE APPROXIMATE CENTER OF STREETS WITHOUT A PAINTED CENTERLINE ON THE SIDE NEAREST THE HYDRANT. FIRE HYDRANTS ON STREET CORNERS SHALL HAVE MARKERS INSTALLED IN EACH ROADWAY. THE MARKER IS A STIMSONITE MARKER; MODEL 101, OR APPROVED EQUIVALENT. THE MARKER SHALL BE BLUE IN COLOR.

REV. #: DESCRIPTION:

SHEET INFORMATION

KEY PLAN

PROJECT INFORMATION

PROJECT TITLE

MYERSVILLE

COMMUNITY

LIBRARY

PROJECT ADDRESS 8 HARP PLACE

MYERSVILLE, MD 21773

PROJECT OWNER

FREDERICK COUNTY,

MARYLAND

DEPARTMENT OF PUBLIC

WORKS

PROJECT TEAM

<u>ARCHITECT</u>

6 NORTH EAST STREET, SUITE 300

P: 301.662.8611 | F: 301.662.8632

FREDERICK, MD | 21701-5680

NOELKERHULL.COM

PA | MD | VA

STRUCTURAL ENGINEER

ABEL CONSULTING ENGINEERS

9055 COMPRINT COURT, SUITE 370 | GAITHERSBURG, MD | 20878

P: 301.258.8884 | F: 301.258.9457

M/E/P ENGINEER

CJL ENGINEERING

3 WEST SECOND STREET | FREDERICK, MD | 00000-0000


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CIVIL ENGINEER

HARRIS, SMARIGA & ASSOCIATES, INC.

125 SOUTH CARROLL STREET | FREDERICK, MD | 21701 P: 301.662.4488 | F: 301.662.4906

JOB NUMBER:	17905
SSUE DATE: 10 A	PRIL 2018
SCALE:	
SHEET TITLE:	
SHEET NUMBER:	
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JAN SWITE TELEVI ATTEC BLESHA BLEX PALITENAL No., Novice Liquige	

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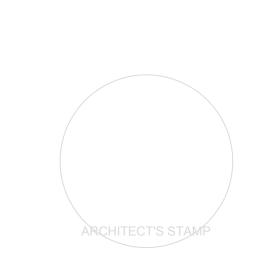
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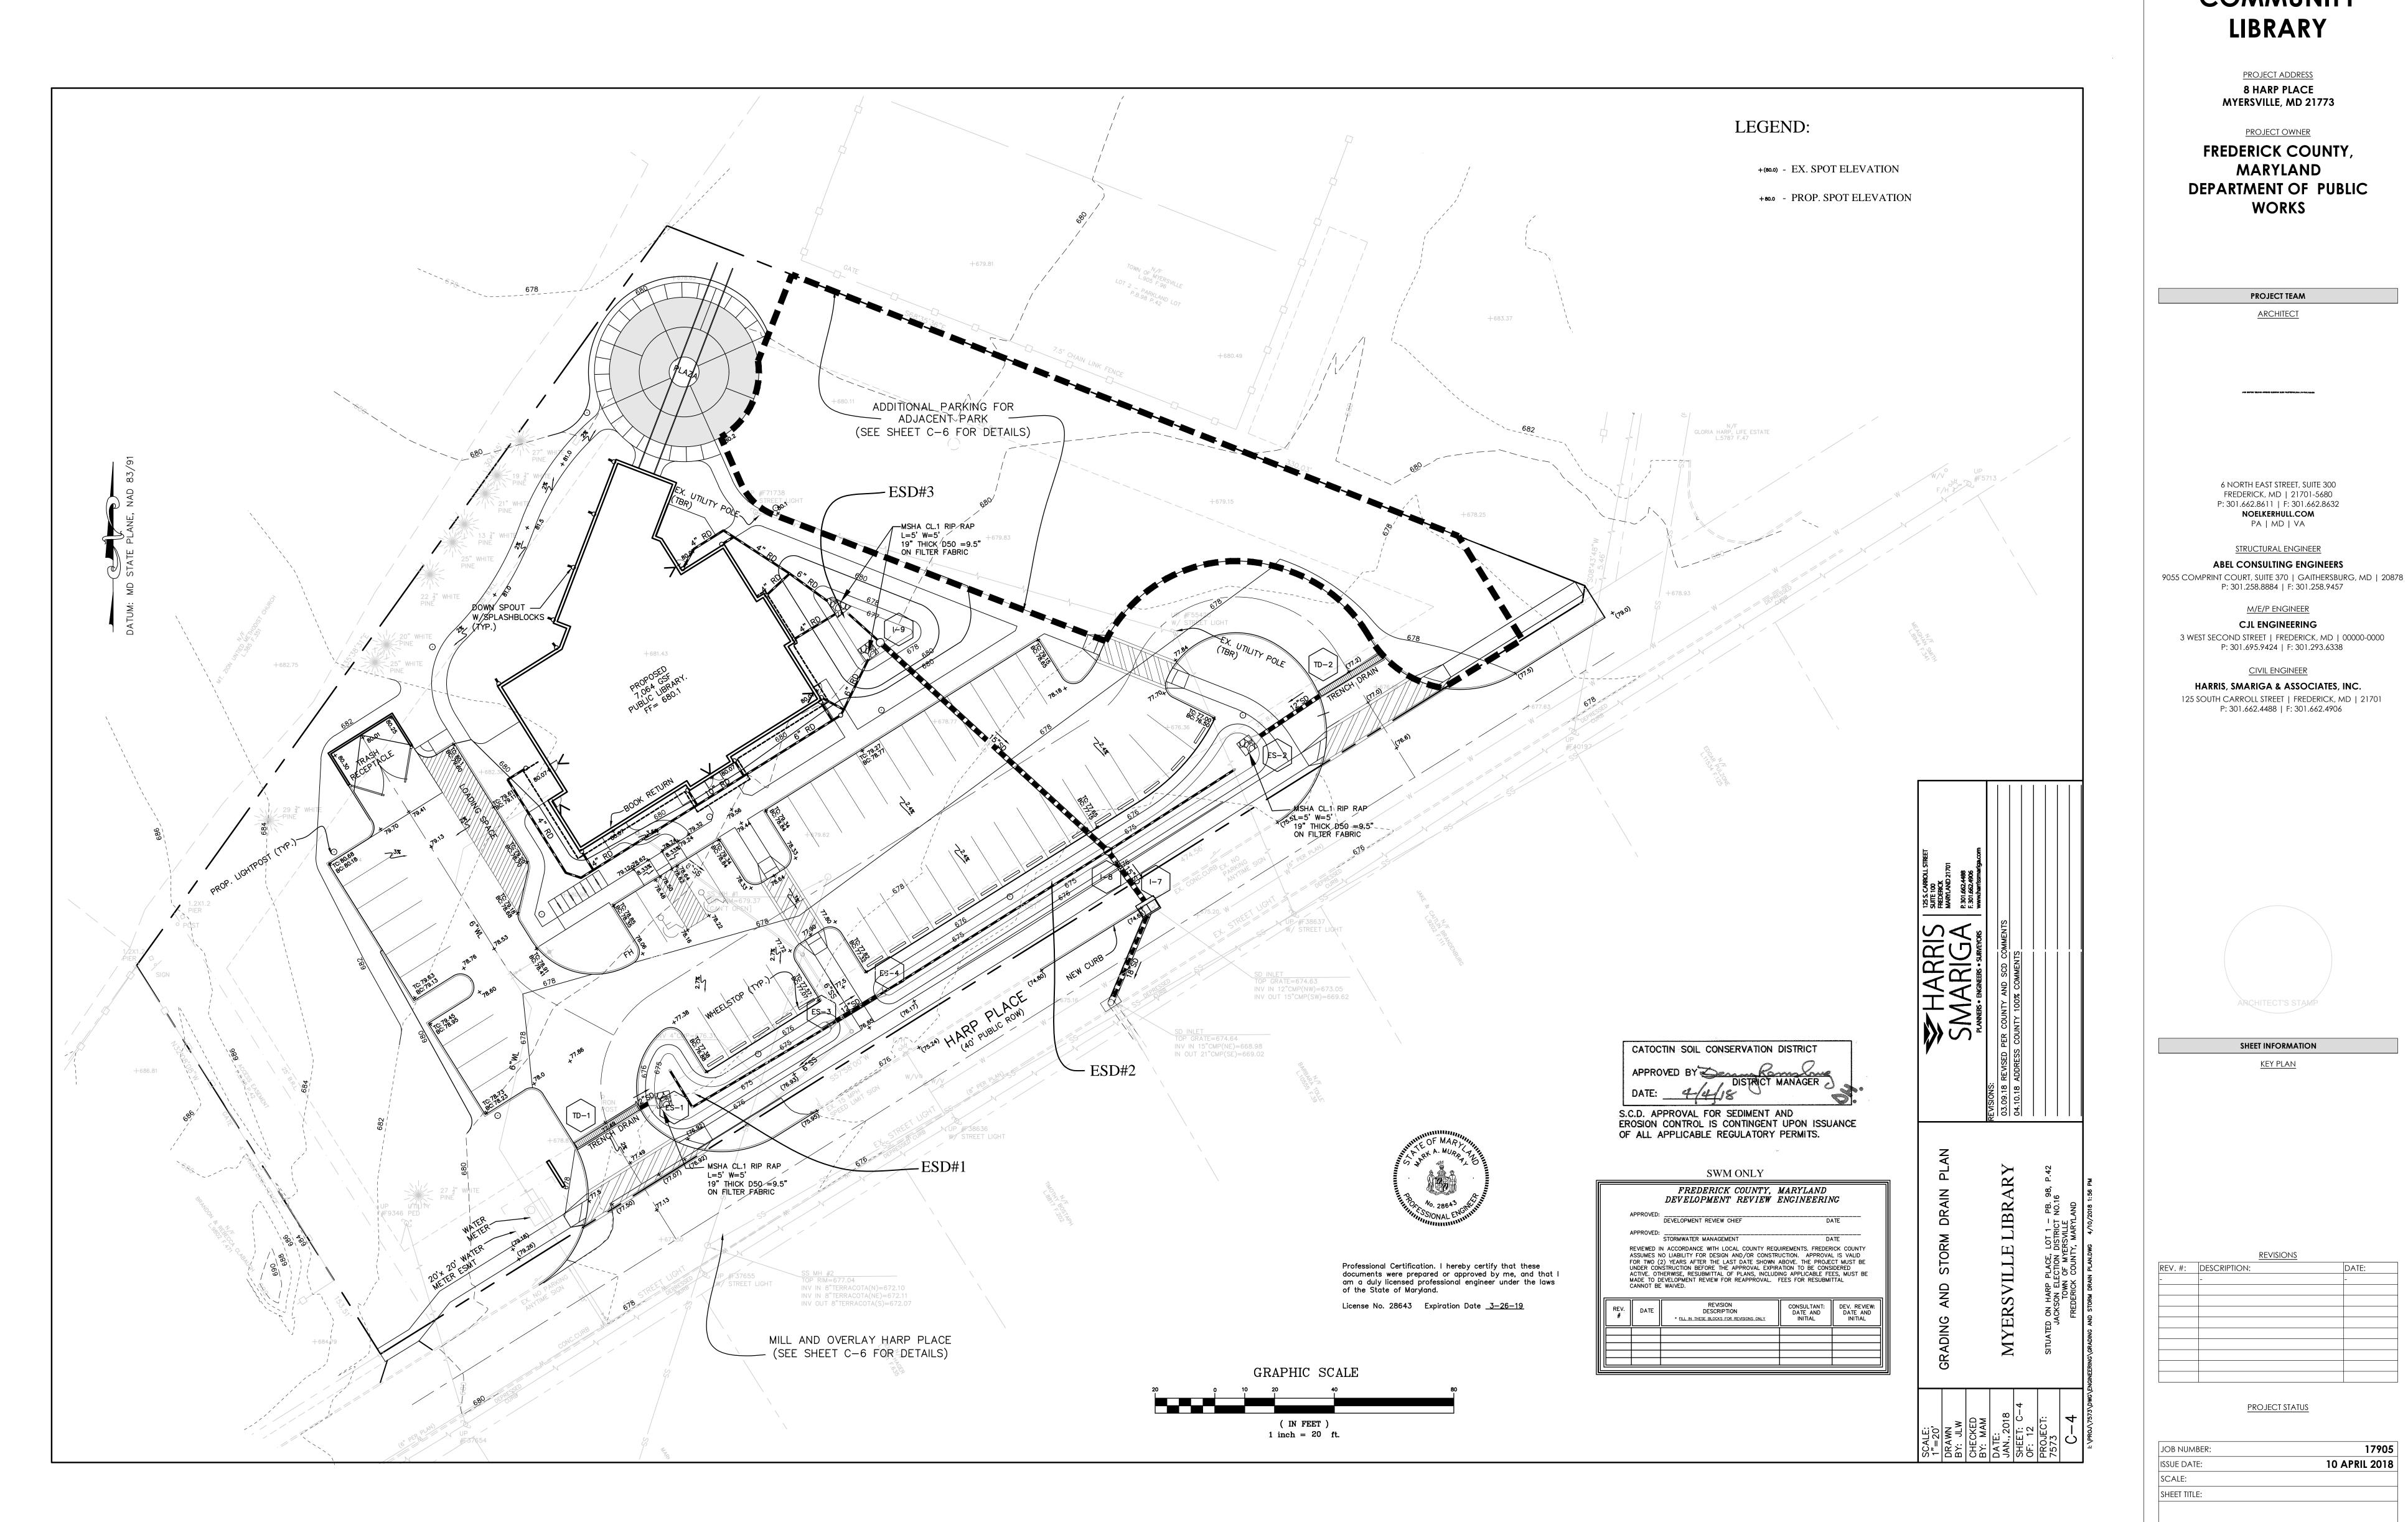

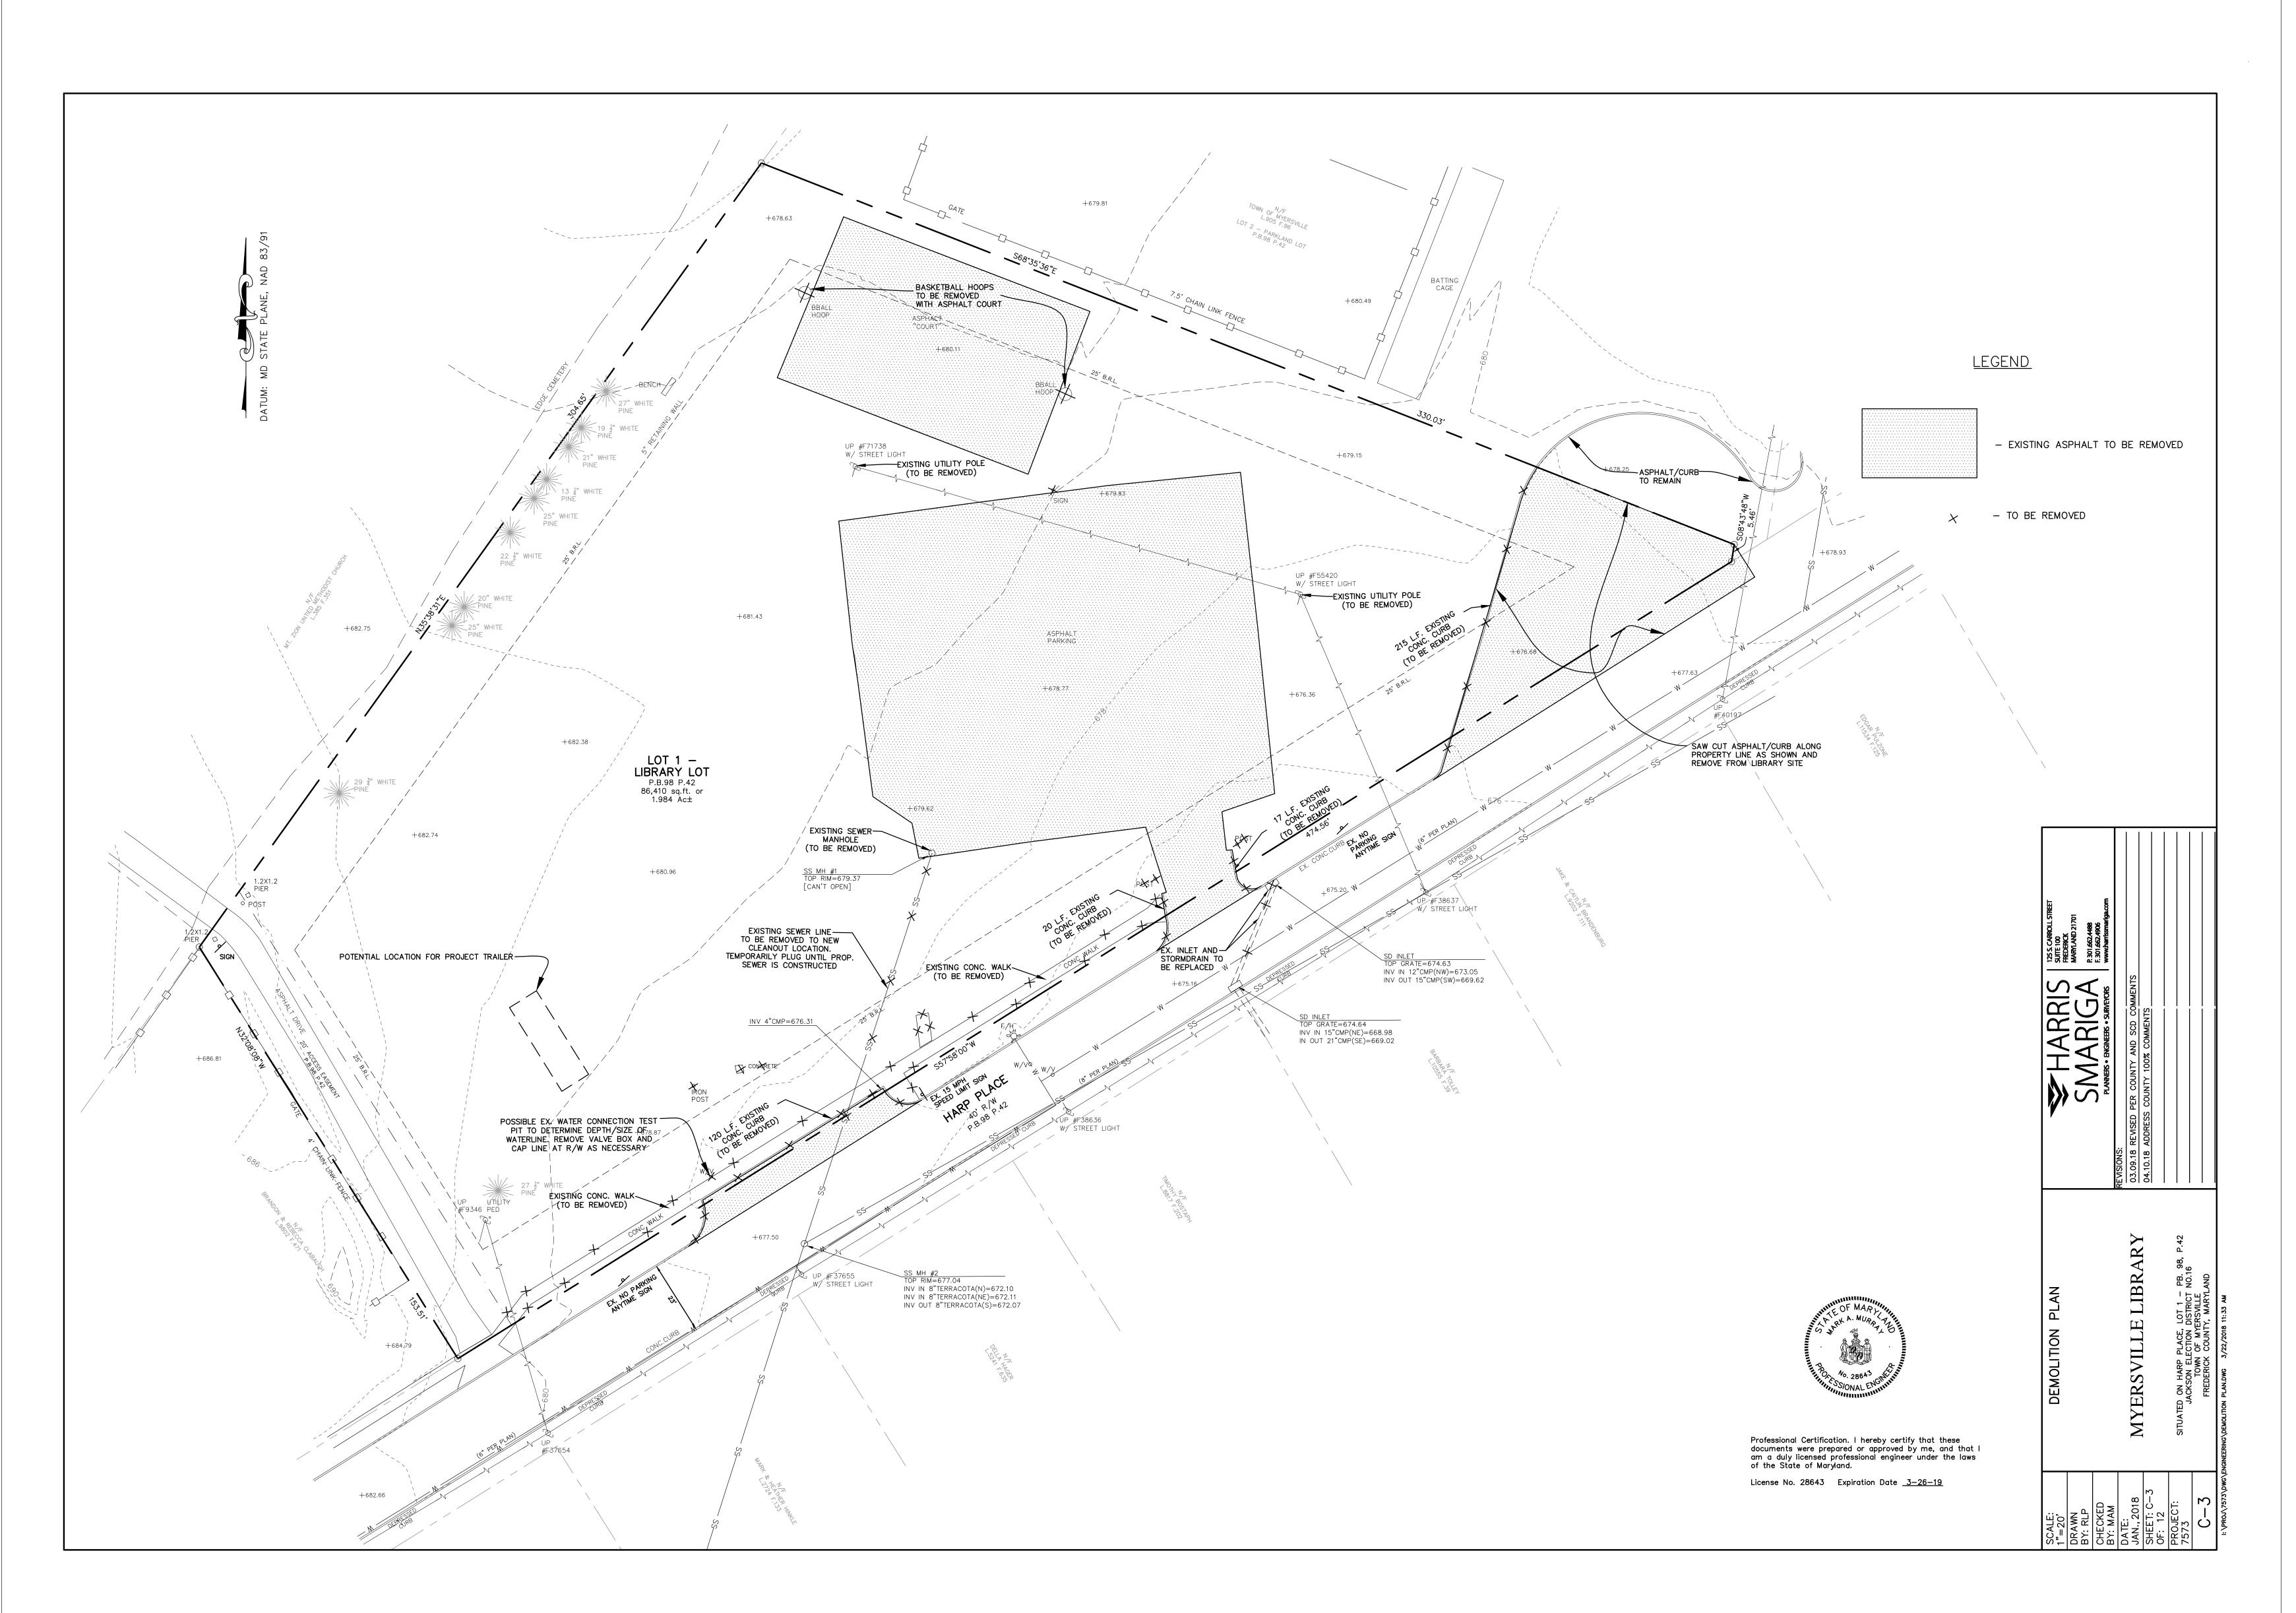
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10 APRIL 2018
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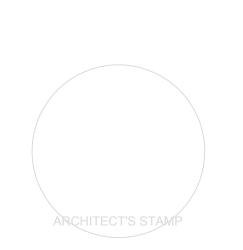
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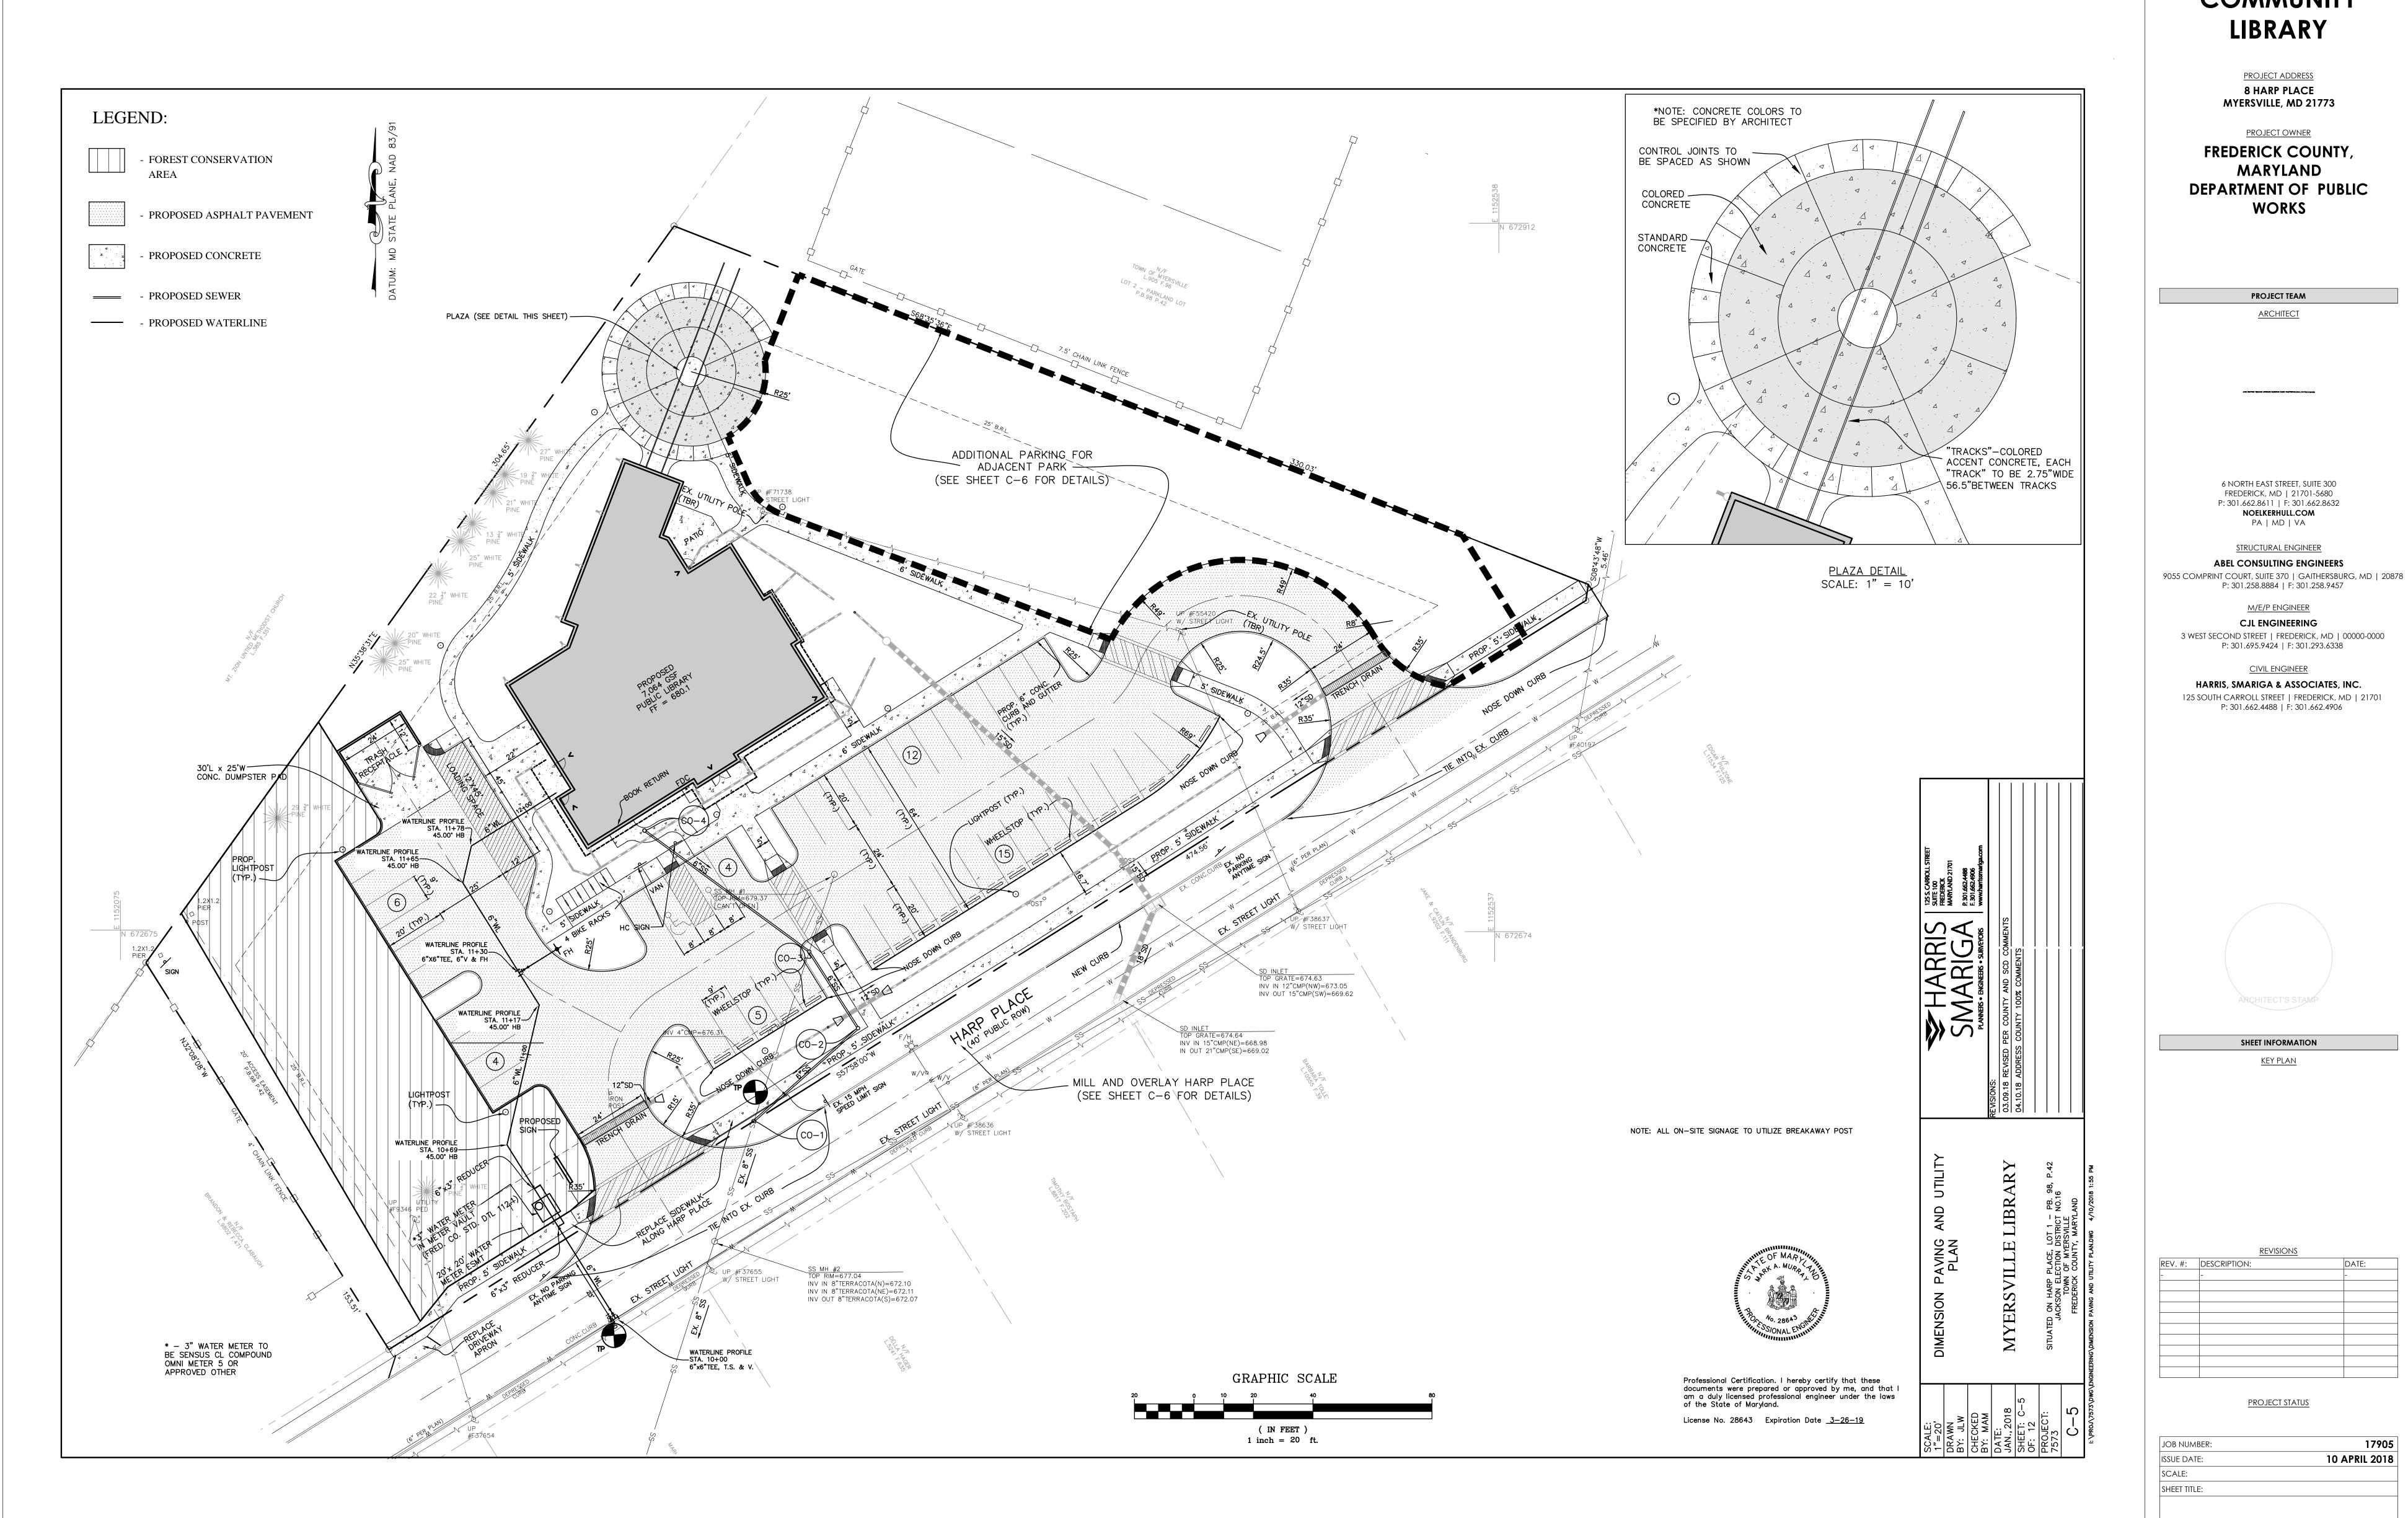


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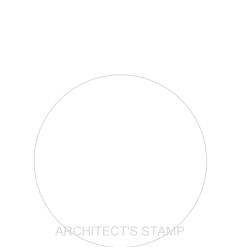
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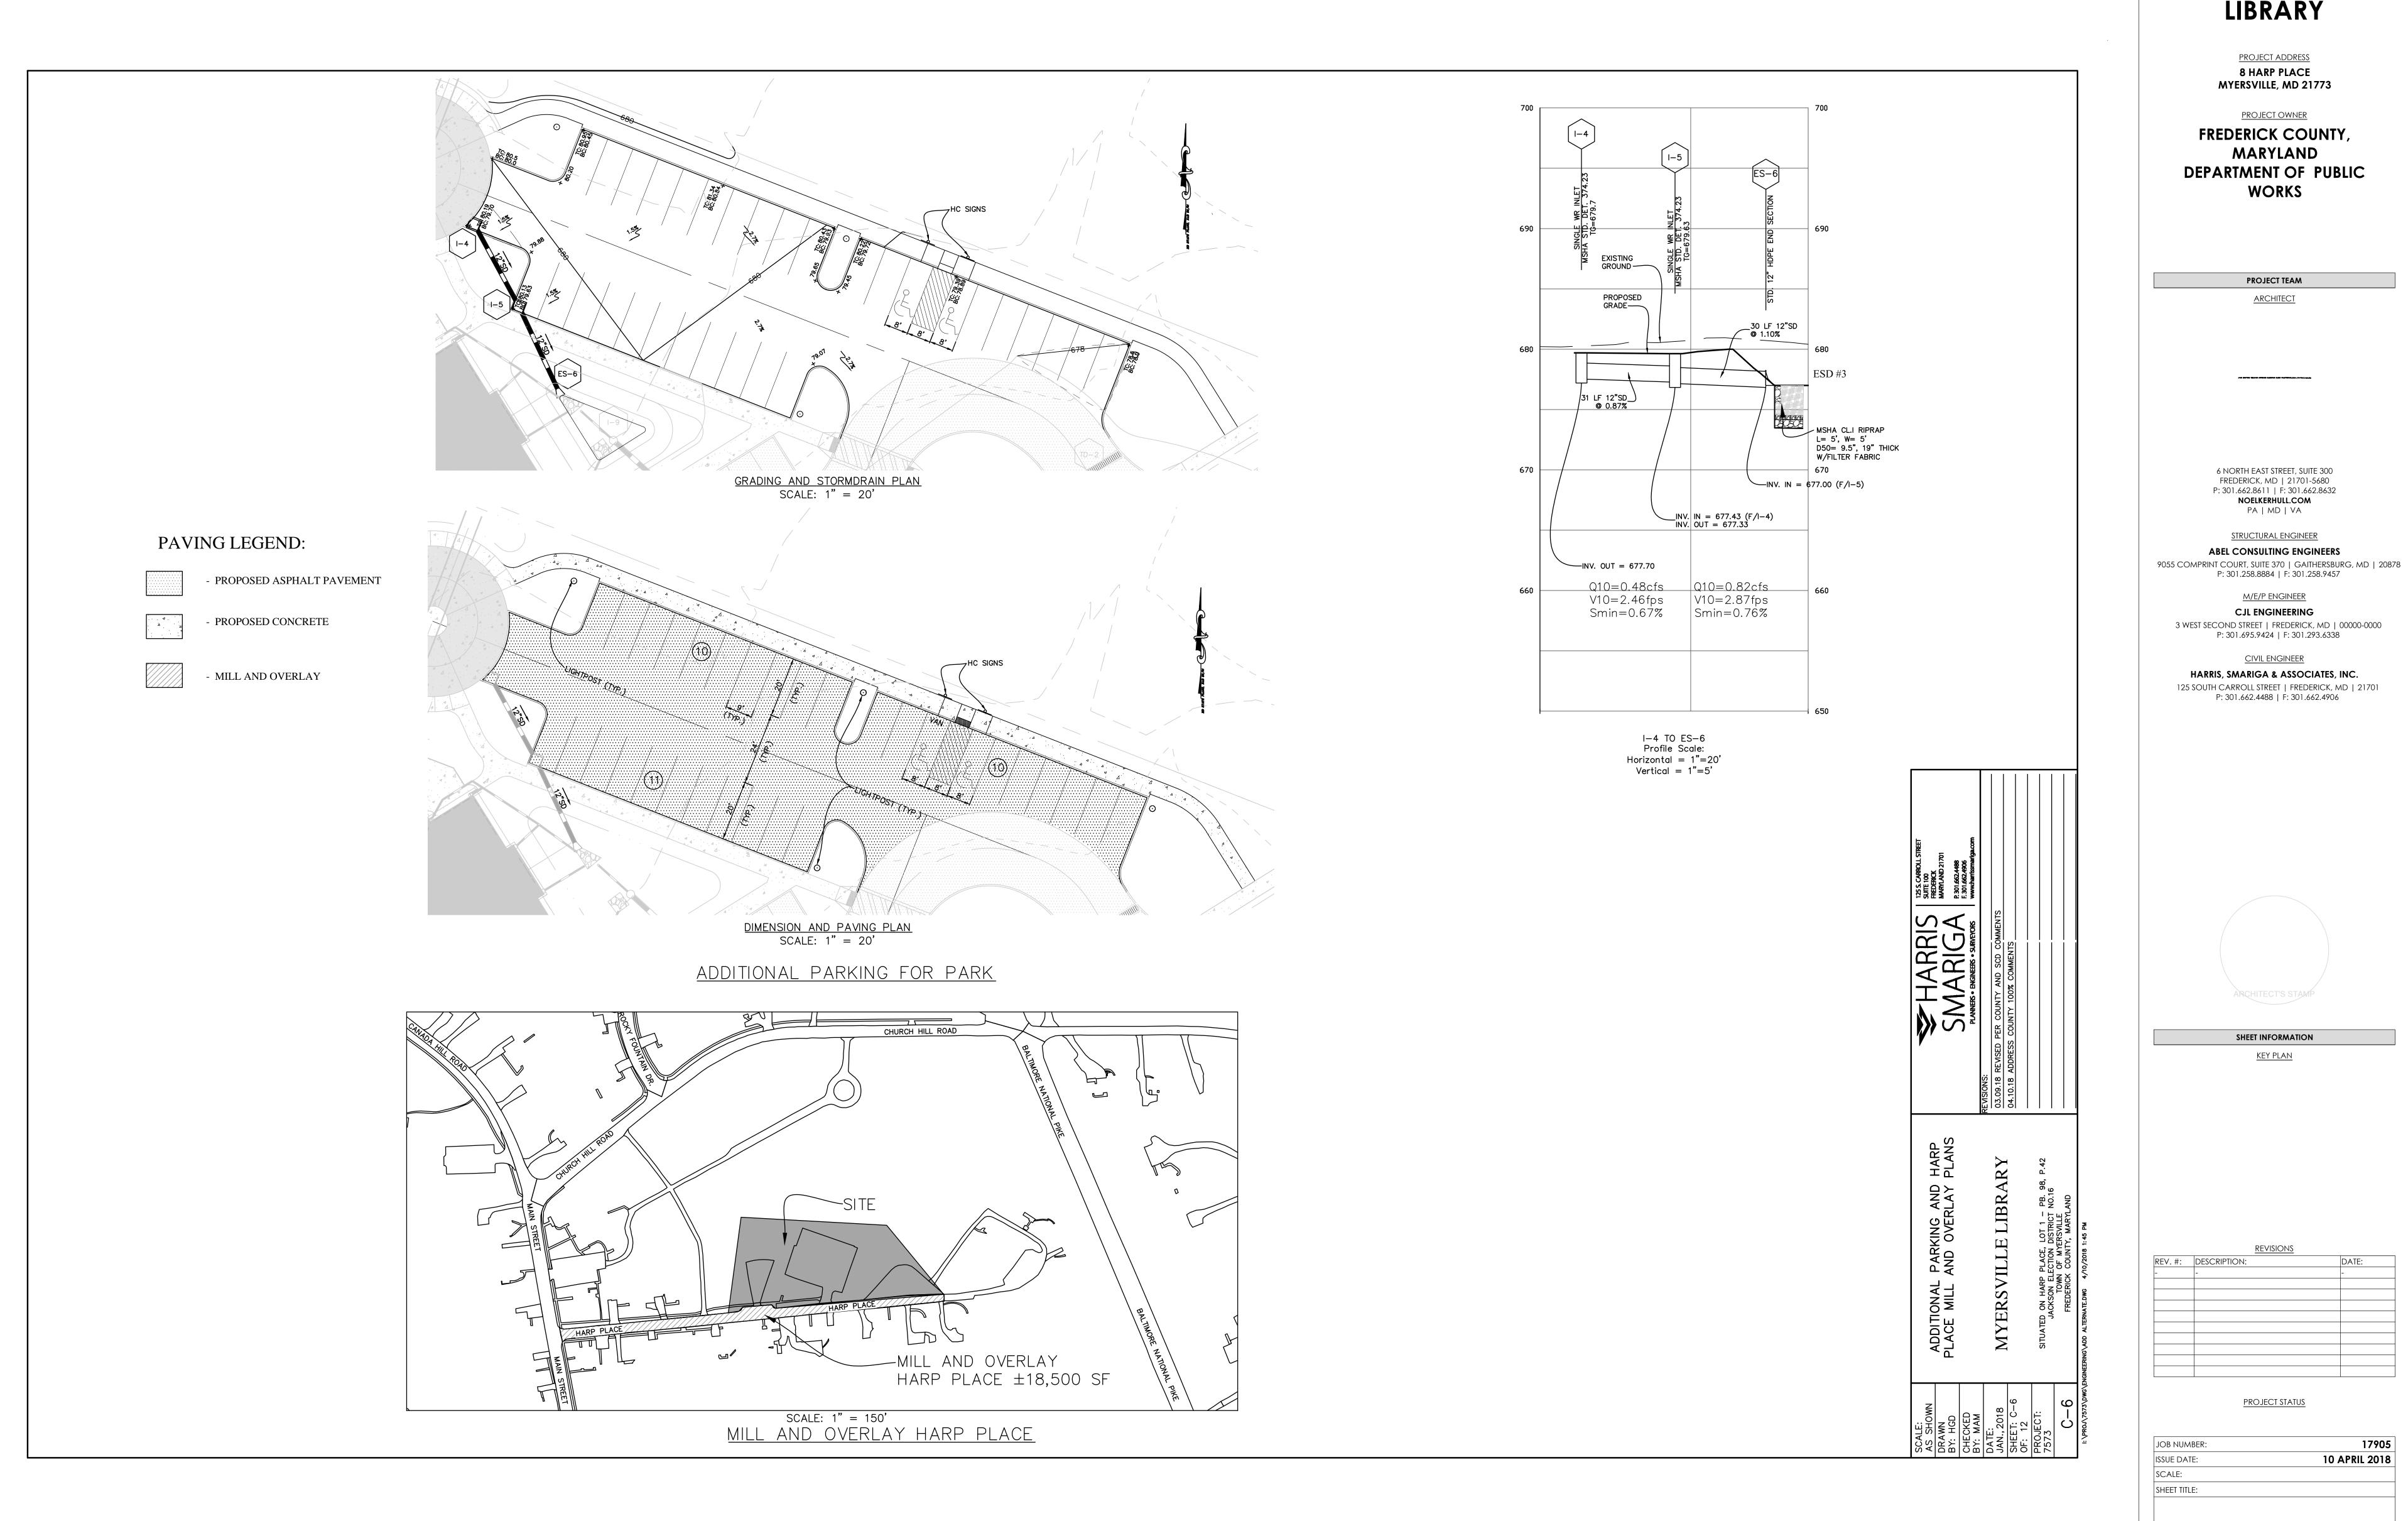
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PROJECT STATUS

JOB NUMBER: 17905 10 APRIL 2018 ISSUE DATE: SCALE: SHEET TITLE: SHEET NUMBER: © COPYRIGHT 2018 NOELKER AND HULL ASSOCIATES, INC



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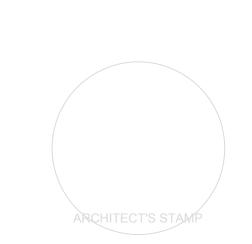
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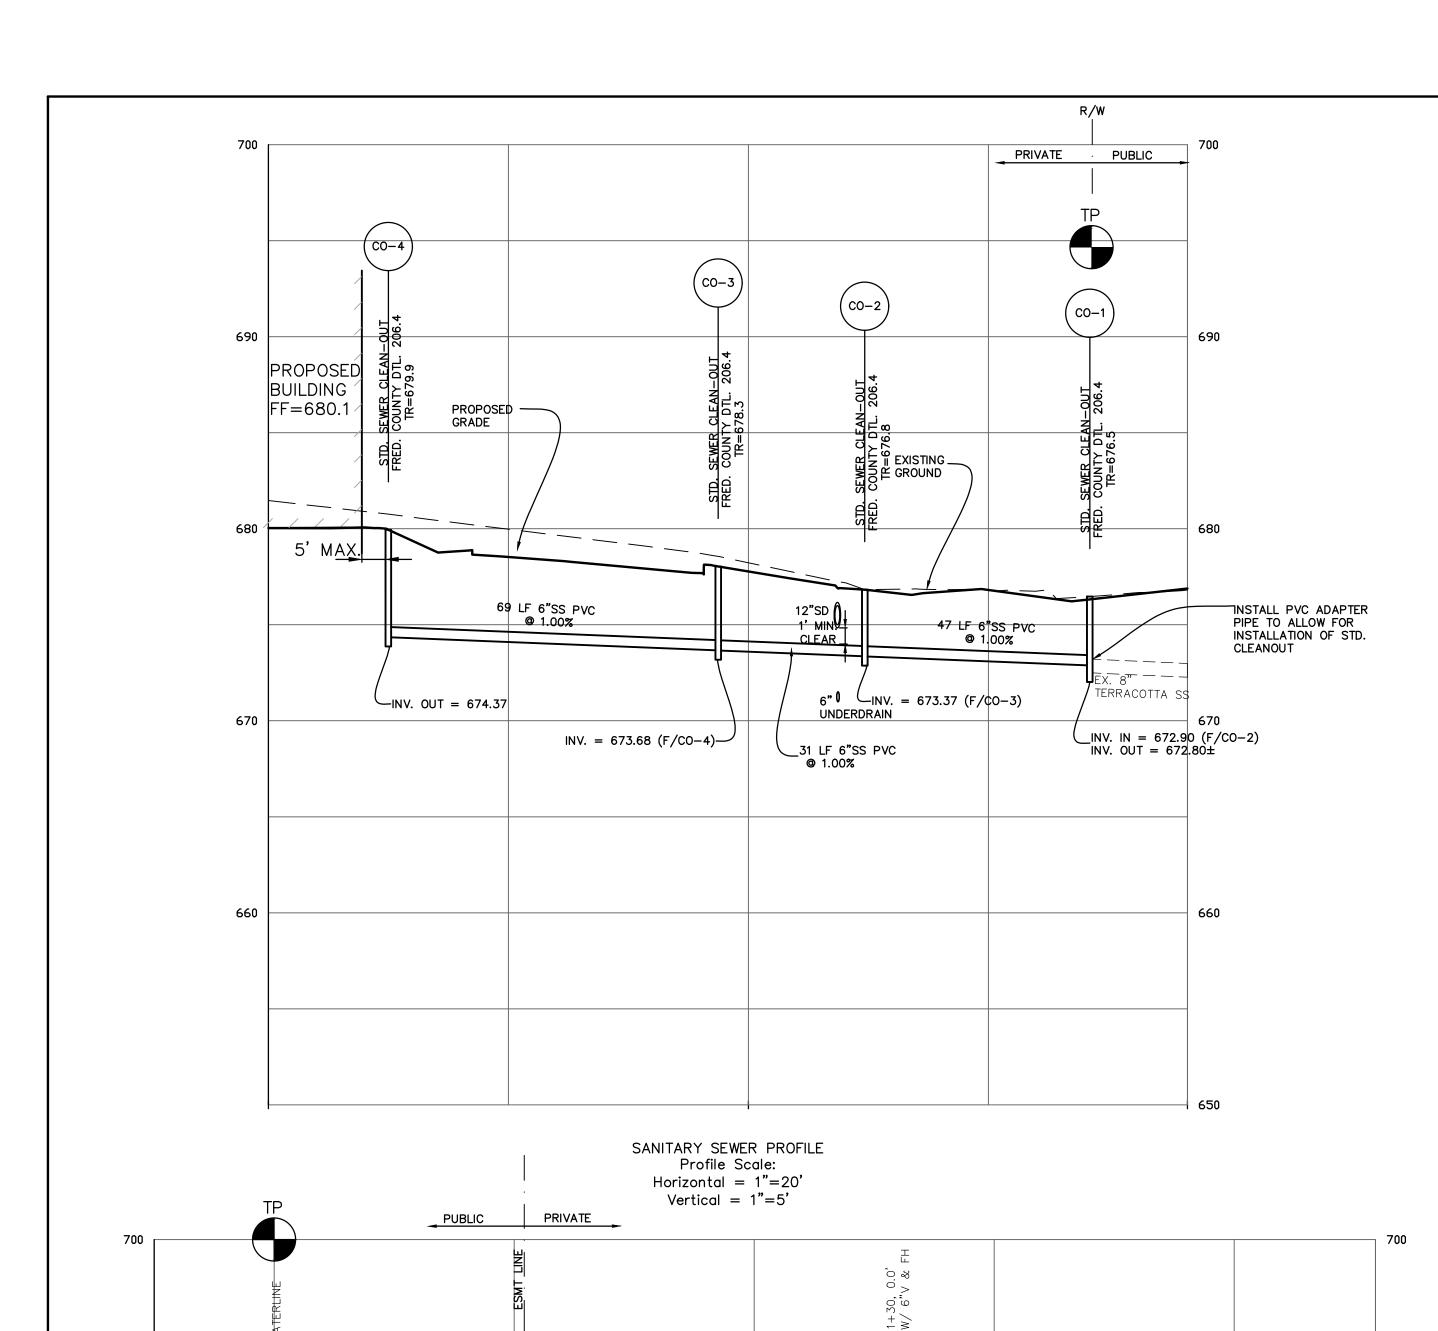


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EET TITLE:	
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PROPOSED GRADE

-INV. = 671.44

├─INV. = 673.57

EXISTING GROUND-

-INV. = 674.03

WATERLINE PROFILE

Profile Scale: Horizontal = 1"=20'

Vertical = 1"=5"

PROPOSED


BUILDING FF=680.1

─INV. = 675.59

ROOF DRAIN-

INV. = 675.52

-INV. = 674.67

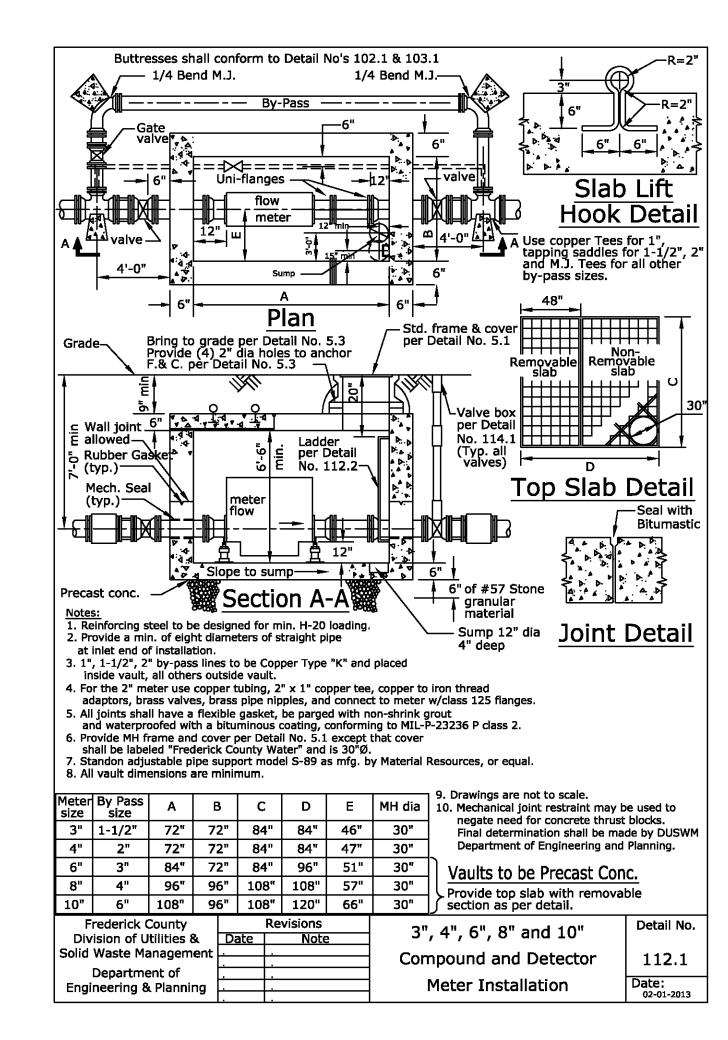

WATER & SEWER GENERAL NOTES

- ALL WATER AND SEWER CONSTRUCTION SHALL BE IN ACCORDANCE WITH THE FREDERICK COUNTY "GENERAL CONDITIONS & STANDARD SPECIFICATIONS", DETAILS FOR WATER MAINS, SANITARY SEWER AND RELATED STRUCTURES, SPECIAL PROVISIONS AND AMENDMENTS THERETO.
- 2. EXISTING UTILITIES ARE SHOWN FROM BEST AVAILABLE RECORDS. THE CONTRACTOR SHALL TEST PIT IN THE AREA OF KNOWN UTILITIES TO VERIFY SIZE, ELEVATION, LOCATION AND TYPE PRIOR TO PERFORMING ANY WORK. ANY UTILITY, WHETHER SHOWN OR NOT, THAT IS DAMAGED BY THE CONTRACTOR SHALL BE REPAIRED IMMEDIATELY AT NO EXPENSE TO THE OWNER. SHOULD THE CONTRACTOR DISCOVER DISCREPANCIES BETWEEN THE PLANS AND FIELD CONDITIONS, THE OWNER IS TO BE NOTIFIED IMMEDIATELY. SHOULD THE CONTRACTOR MAKE FIELD CORRECTIONS OR ADJUSTMENTS WITHOUT THE AUTHORIZATION OF THE OWNER, THEN THE CONTRACTOR ASSUMES THE RESPONSIBILITY FOR SAID CORRECTIONS OR ADJUSTMENTS.
- 3. ANY NECESSARY ADJUSTMENTS TO EXISTING MANHOLES, VALVE BOXES, ETC., ARE TO BE DONE SO BY THE CONTRACTOR. THE CONTRACTOR IS RESPONSIBLE FOR REMOVING AND REPLACING ANY EXISTING FENCES, DRIVEWAYS, SIGNS, DRAINAGE PIPES, MAILBOXES, SHRUBS, TREES, ETC. DAMAGED OR REMOVED DURING CONSTRUCTION. ALL DISTURBED AREAS SHALL BE RETURNED TO THEIR ORIGINAL CONDITION OR BETTER.
- 4. ALL WATER MAINS TO BE DUCTILE IRON PIPE (3" 6" CLASS 54, 8" AND LARGER CLASS 52). ALL GRAVITY SEWER MAINS TO BE SDR 35 PVC, UNLESS DEPTH EXCEEDS 14', THEN USE SDR-26, UNLESS OTHERWISE NOTED.
- MEGALUG RESTRAINTS TO BE USED ON WATER LINES WHERE EARTH IS DISTURBED BY OTHER CONSTRUCTION.
 ALL OUTSIDE FIRE PROTECTION LINE CONSTRUCTION SHALL CONFORM TO NFPA 24 REQUIREMENTS.
- 7. ALL SANITARY SEWER CLEANOUTS (C/O) TO BE CONSTRUCTED PER FRED. CO. STD. DTL. 206.4, OR 208.1 IF IN TRAFFIC AREAS.
- 8. THE CONTRACTOR SHALL NOTIFY MISS UTILITY (1-800-257-7777) 5 DAYS PRIOR TO START OF CONSTRUCTION.
- 9. THE CONTRACTOR SHALL BE RESPONSIBLE FOR KEEPING SILT AND DEBRIS OUT OF THE STORM DRAINAGE SYSTEM FOR THE DURATION OF THE CONTRACT.
- 10. THE CONTRACTOR SHALL MAINTAIN ACCESS TO ALL PROPERTY OWNERS AT ALL TIMES. THE CONTRACTOR, WITH OWNER APPROVAL, WILL COORDINATE WITH PROPERTY OWNERS IF ACCESS MUST BE INTERUPTED FOR
- 11. ALL PUBLIC FITTINGS AND VALVES ARE TO BE RESTRAINED BY USE OF "MEGA—LUGS" OR EQUAL. IF NO RESTRAINED JOINT LENGTH IS SHOWN ON THE DRAWINGS, INSTALL CONCRETE BUTTRESS/ANCHORS AT FITTINGS PER THE STANDARD DETAILS OR SUBMIT AN RFI TO THE ENGINEER TO HAVE RESTRAINED JOINT
- 12. OWNER/DEVELOPER/CONTRACTOR RESPONSIBILITIES FOR SUBGRADE: A. THE CONTRACTOR SHALL ENSURE THAT THE GROUND ELEVATION OVER THE WATER AND/OR SEWER LINE LOCATIONS IS WITHIN SIX (6) INCHES OF FINISHED GRADE (OUTSIDE ROADWAY) OR AT THE ROAD SUBGRADE ELEVATION (WITHIN ROADWAY) PRIOR TO THE START OF ANY EXCAVATION OR TRENCHING OF WATER AND/OR SEWER LINES. CUT SHEETS PREPARED BY THE CONTRACTOR SHALL BE PRESENTED TO THE INSPECTOR SUFFICIENTLY IN ADVANCE OF THE WORK BEING DONE (THIS ADVANCE NOTICE TO BE DETERMINED BY THE INSPECTOR DURING THE PRECONSTRUCTION MEETING). THE INSPECTOR RESERVES THE RIGHT TO WITHHOLD PAYMENT AND/OR TO STOP WORK IF CUT SHEETS ARE NOT PROVIDED IN A TIMELY FASHION. B. IF AFTER INSTALLATION OF WATER AND/OR SEWER FACILITIES THERE EXISTS A CONFLICT WITH OTHER UTILITIES (SHOWN AS FUTURE), THE RELOCATION, ADJUSTMENT, REPLACEMENT, ETC. OF SAID WATER AND SEWER WILL BE AFFECTED PURSUANT TO ARTICLE 16 OF THE GENERAL CONDITIONS AND STANDARD SPECIFICATIONS. C. IF SUBGRADE IS SHOWN AS CONTROLLED FILL OR FILL BENEATH THE WATER AND/OR SANITARY SEWER, THE MASS GRADING ENGINEER OF RECORD SHALL CERTIFY THE ENTIRE PORTION OF THE MASS GRADED AREA HAS BEEN INSTALLED PURSUANT TO THE SECTION 2200 WHERE WATER AND/OR SEWER LINES ARE TO BE INSTALLED.
- 13. 18" MINIMUM SEPARATION BETWEEN ALL VALVES AND TEE/CROSS.

LENGTH CLARIFIED.



Professional Certification. I hereby certify that these documents were prepared or approved by me, and that I am a duly licensed professional engineer under the laws of the State of Maryland.

License No. 28643 Expiration Date 3-26-19

SCALE:
AS SHOWN
DRAWN
BY: DLS
CHECKED
BY: MAM
DATE:
JAN., 2018
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OF: 12
PROJECT:
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PROJECT INFORMATION

PROJECT TITLE

MYERSVILLE COMMUNITY LIBRARY

PROJECT ADDRESS

8 HARP PLACE
MYERSVILLE, MD 21773

PROJECT OWNER

FREDERICK COUNTY,

MARYLAND

DEPARTMENT OF PUBLIC

WORKS

PROJECT TEAM

<u>ARCHITECT</u>

6 NORTH EAST STREET, SUITE 300 FREDERICK, MD | 21701-5680 P: 301.662.8611 | F: 301.662.8632 NOELKERHULL.COM

PA | MD | VA

STRUCTURAL ENGINEER

ABEL CONSULTING ENGINEERS

9055 COMPRINT COURT, SUITE 370 | GAITHERSBURG, MD | 20878 P: 301.258.8884 | F: 301.258.9457

M/E/P ENGINEER


CJL ENGINEERING

3 WEST SECOND STREET | FREDERICK, MD | 00000-0000

P: 301.695.9424 | F: 301.293.6338 <u>CIVIL ENGINEER</u>

HARRIS, SMARIGA & ASSOCIATES, INC.

125 SOUTH CARROLL STREET | FREDERICK, MD | 21701
P: 301.662.4488 | F: 301.662.4906

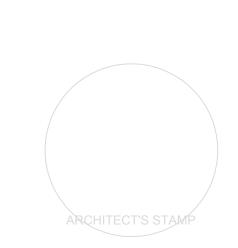

SHEET INFORMATION

KEY PLAN

<u>revisions</u>


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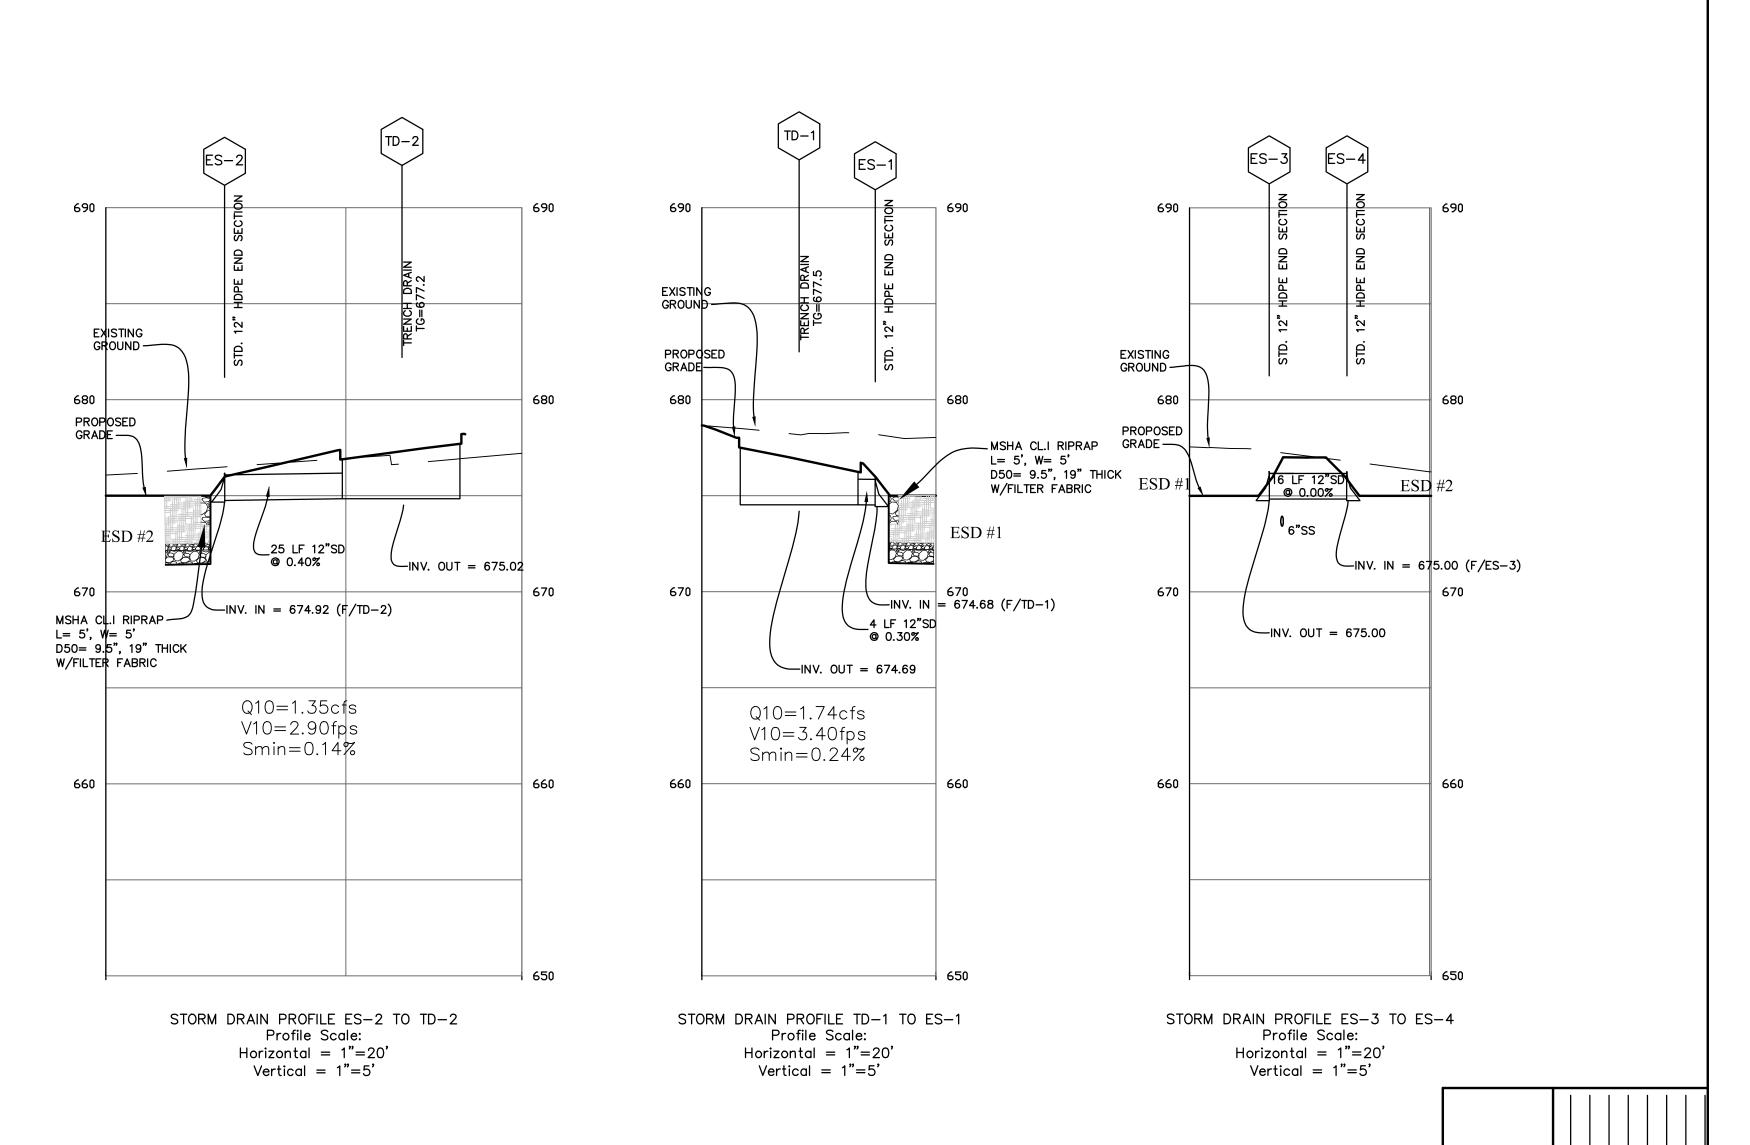
PROJECT STATUS

JOB NUMBER: 17905
ISSUE DATE: 10 APRIL 2018
SCALE:
SHEET TITLE:

SHEET NUMBER:

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CATOCTIN SOIL CONSERVATION DISTRICT S.C.D. APPROVAL FOR SEDIMENT AND EROSION CONTROL IS CONTINGENT UPON ISSUANCE OF ALL APPLICABLE REGULATORY PERMITS.

Professional Certification. I hereby certify that these documents were prepared or approved by me, and that I am a duly licensed professional engineer under the laws of the State of Maryland.

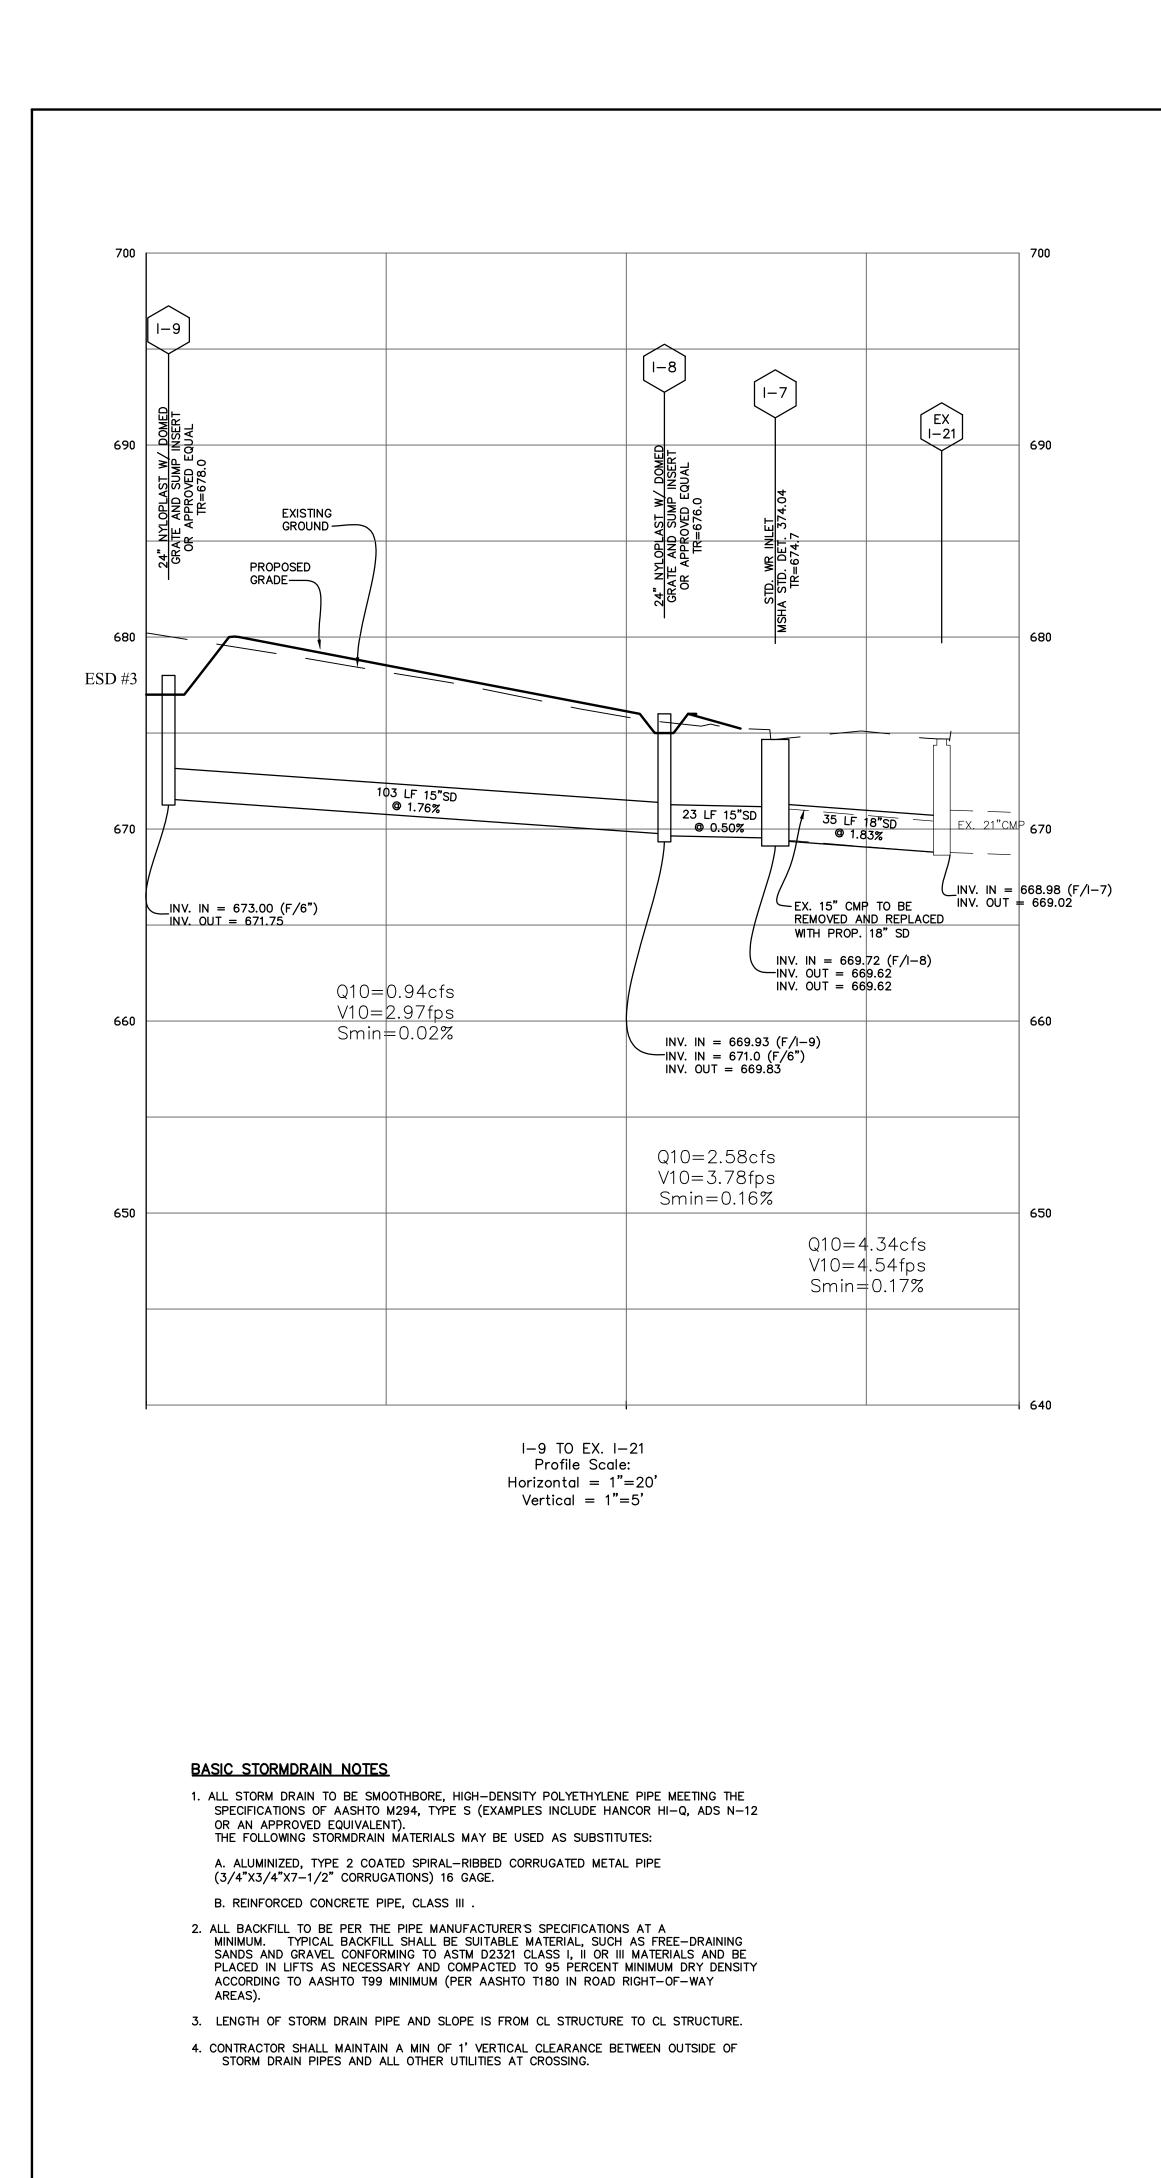DEVELOPMENT REVIEW CHIEF STORMWATER MANAGEMENT REVISION DESCRIPTION * FILL IN THESE BLOCKS FOR REVISIONS ONLY License No. 28643 Expiration Date <u>3-26-19</u>

SWM ONLY FREDERICK COUNTY, MARYLAND DEVELOPMENT REVIEW ENGINEERING REVIEWED IN ACCORDANCE WITH LOCAL COUNTY REQUIREMENTS. FREDERICK COUNTY ASSUMES NO LIABILITY FOR DESIGN AND/OR CONSTRUCTION. APPROVAL IS VALID FOR TWO (2) YEARS AFTER THE LAST DATE SHOWN ABOVE. THE PROJECT MUST BE UNDER CONSTRUCTION BEFORE THE APPROVAL EXPIRATION TO BE CONSIDERED ACTIVE. OTHERWISE, RESUBMITTAL OF PLANS, INCLUDING APPLICABLE FEES, MUST BE MADE TO DEVELOPMENT REVIEW FOR REAPPROVAL. FEES FOR RESUBMITTAL CANNOT BE WAIVED. CONSULTANT: DEV. REVIEW:
DATE AND
INITIAL INITIAL

LIBR

JOB NUMBER: 10 APRIL 2018 ISSUE DATE: SCALE: SHEET TITLE: SHEET NUMBER:

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PROJECT INFORMATION PROJECT TITLE

MYERSVILLE COMMUNITY **LIBRARY**

> PROJECT ADDRESS **8 HARP PLACE** MYERSVILLE, MD 21773

> > PROJECT OWNER

FREDERICK COUNTY, **MARYLAND** DEPARTMENT OF PUBLIC WORKS

PROJECT TEAM

<u>ARCHITECT</u>

6 NORTH EAST STREET, SUITE 300 FREDERICK, MD | 21701-5680 P: 301.662.8611 | F: 301.662.8632 NOELKERHULL.COM PA | MD | VA


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CJL ENGINEERING 3 WEST SECOND STREET | FREDERICK, MD | 00000-0000 P: 301.695.9424 | F: 301.293.6338

CIVIL ENGINEER HARRIS, SMARIGA & ASSOCIATES, INC. 125 SOUTH CARROLL STREET | FREDERICK, MD | 21701


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STRUCTURAL ENGINEER


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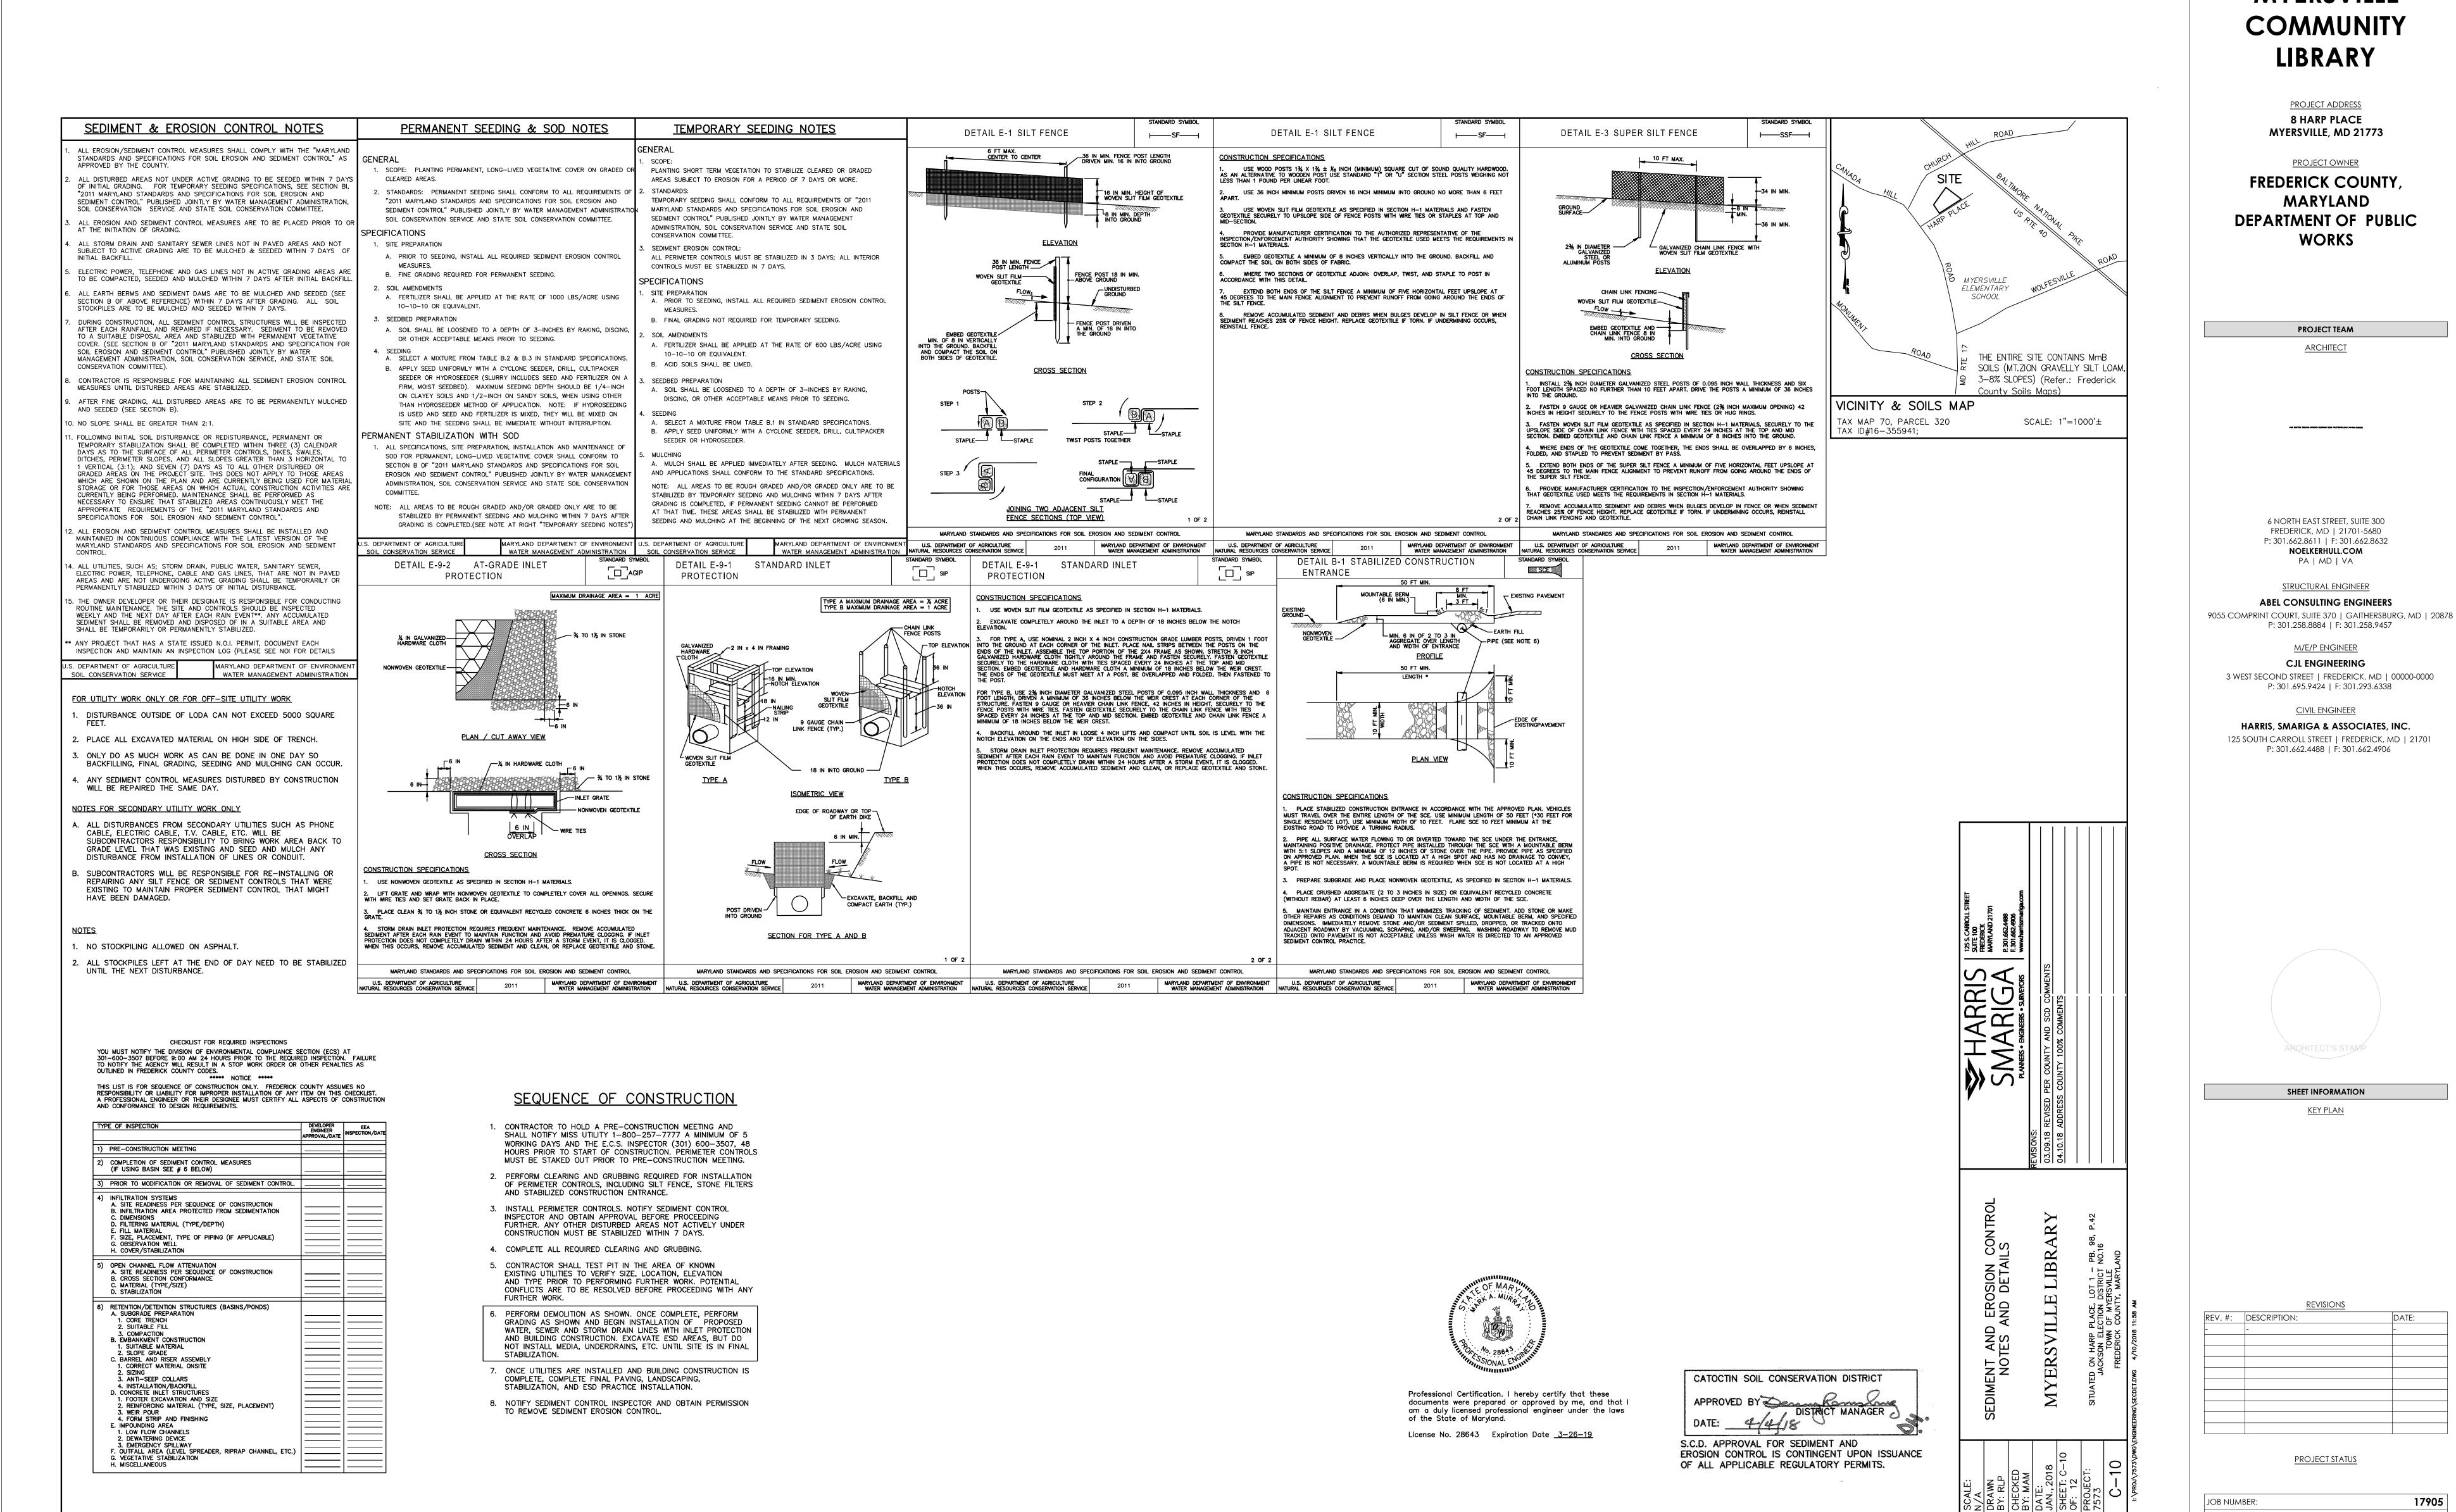
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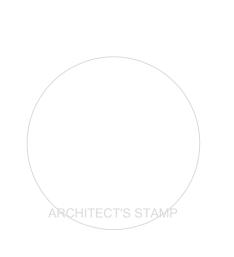
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CIVIL ENGINEER

HARRIS, SMARIGA & ASSOCIATES, INC. 125 SOUTH CARROLL STREET | FREDERICK, MD | 21701 P: 301.662.4488 | F: 301.662.4906

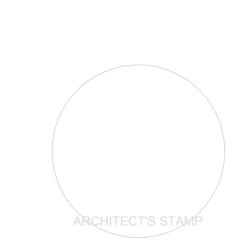


SHEET INFORMATION

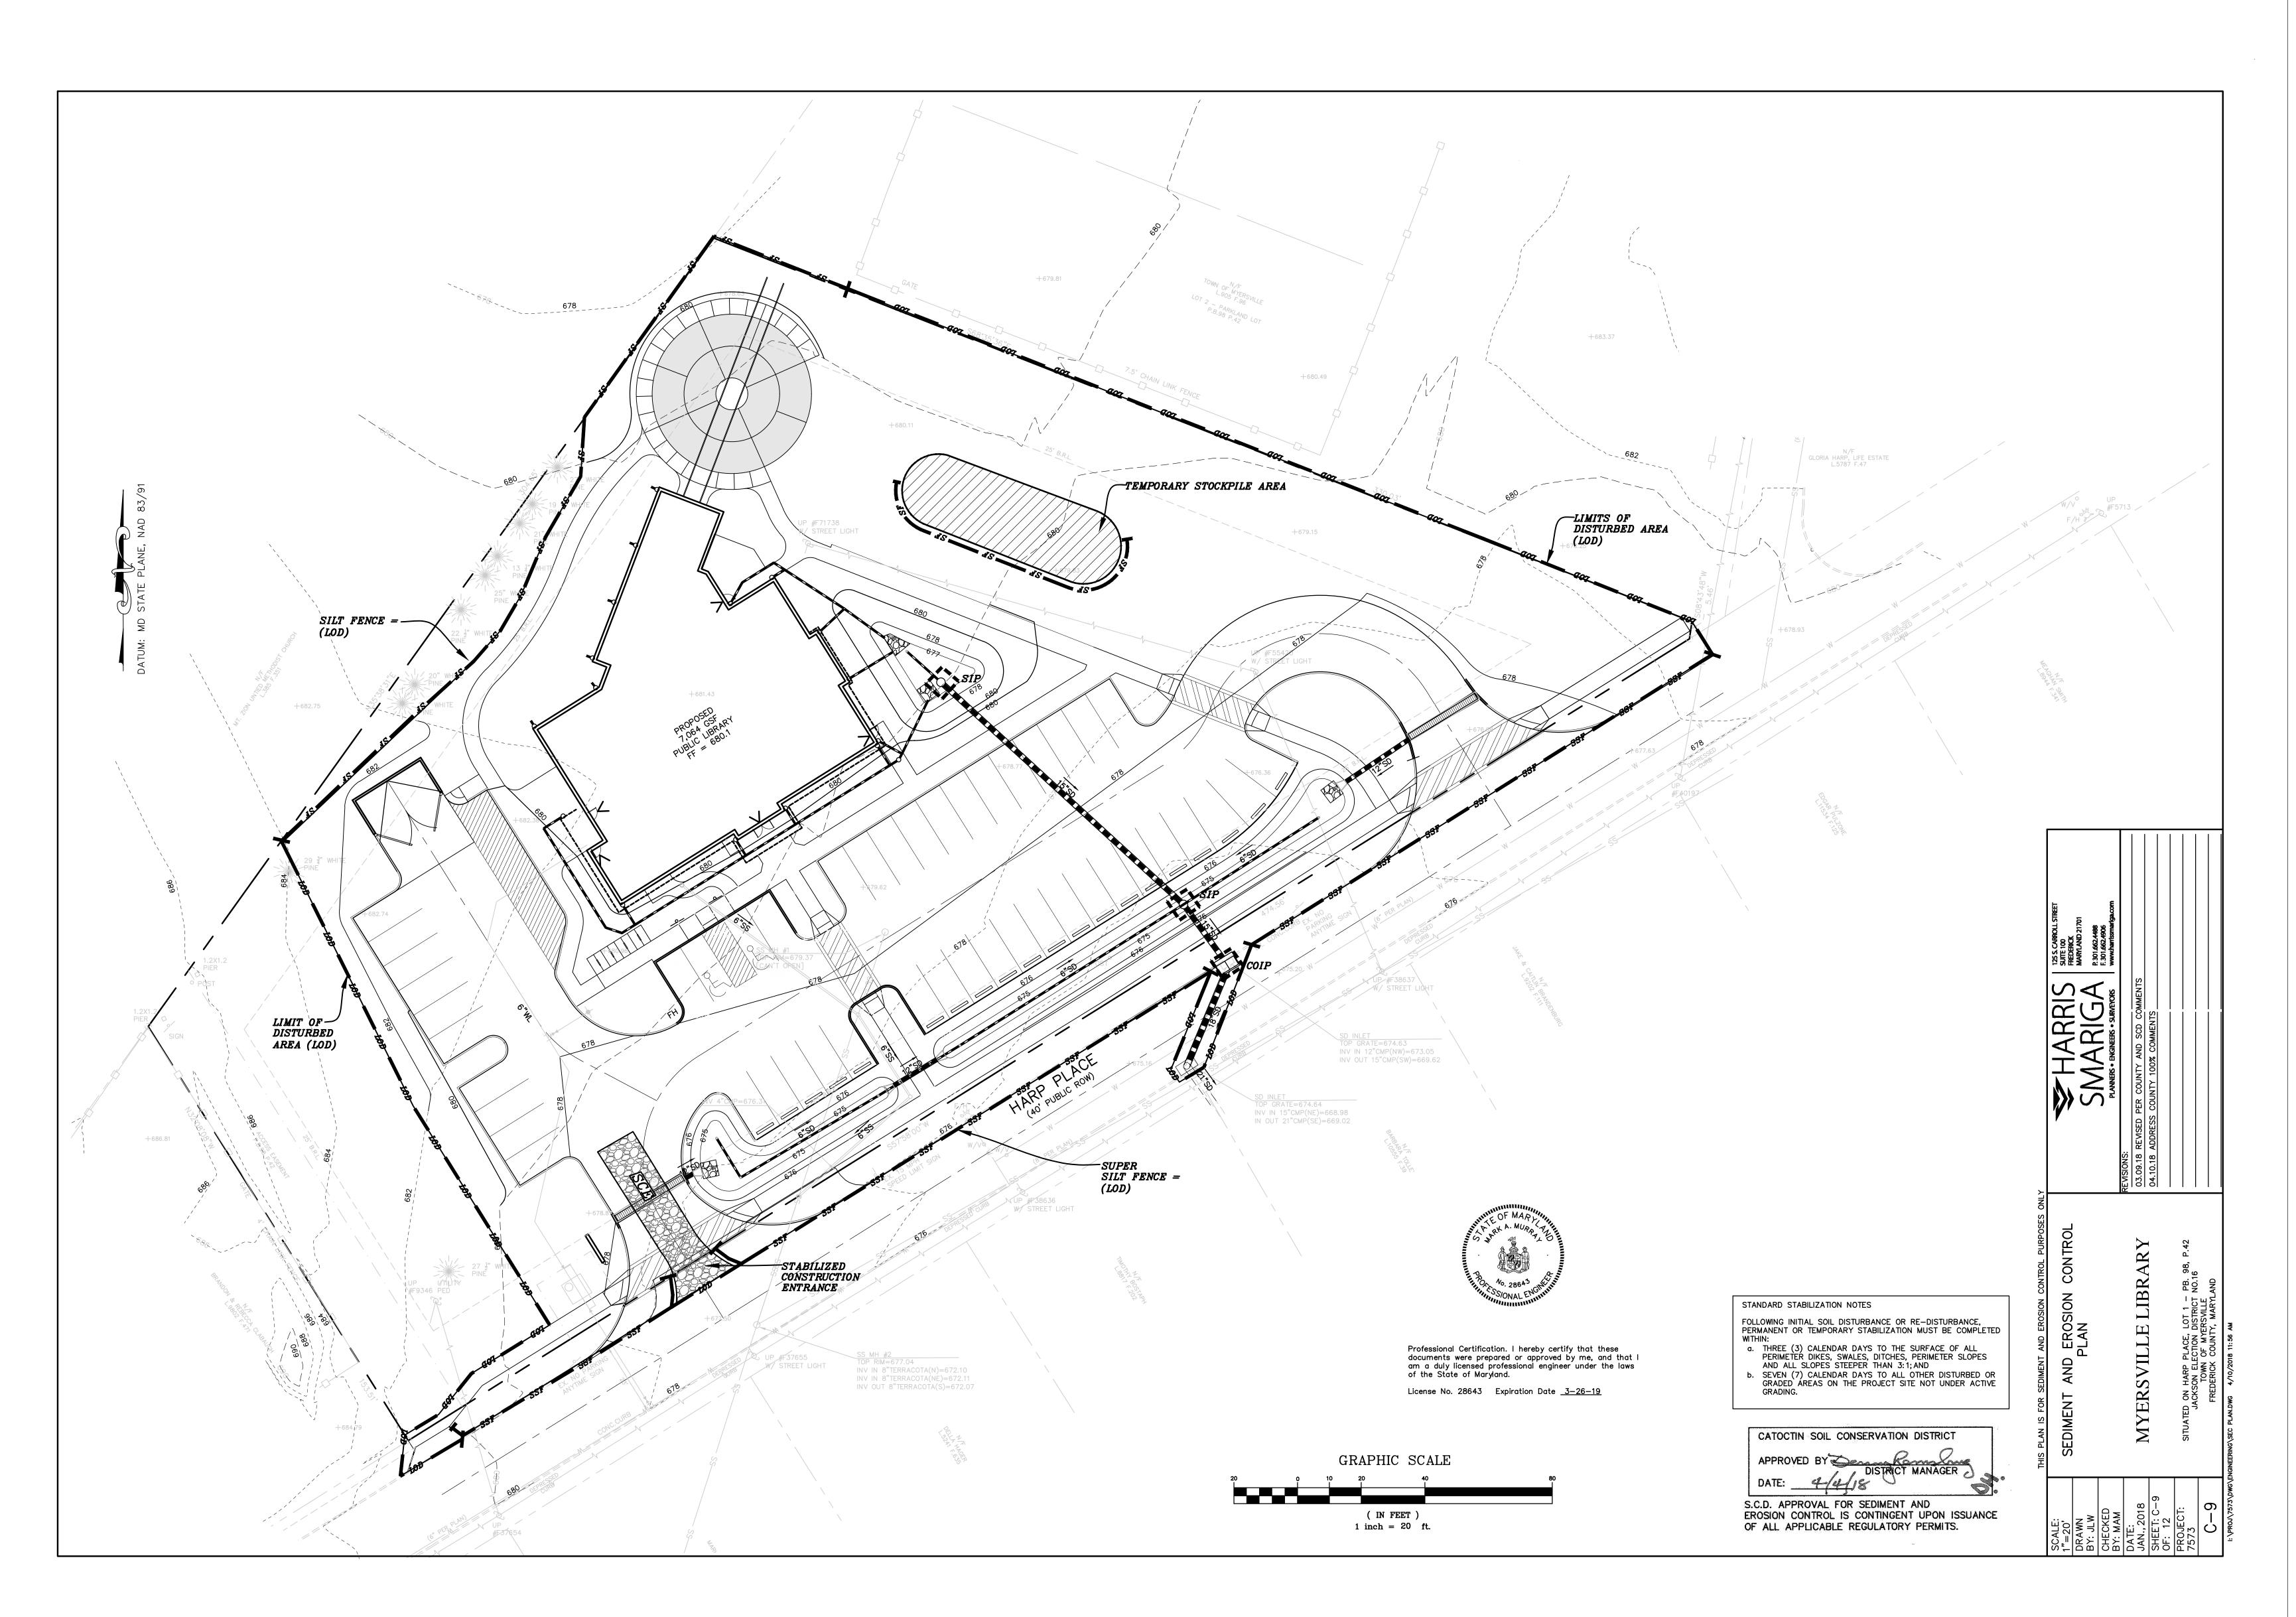KEY PLAN

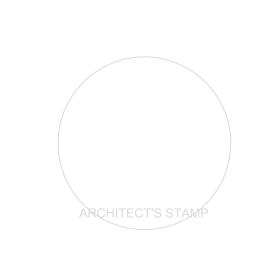REV. #: DESCRIPTION:

PROJECT STATUS

JOB NUMBER: 17905 10 APRIL 2018 ISSUE DATE: SCALE: SHEET TITLE: SHEET NUMBER: © COPYRIGHT 2018 NOELKER AND HULL ASSOCIATES, INC

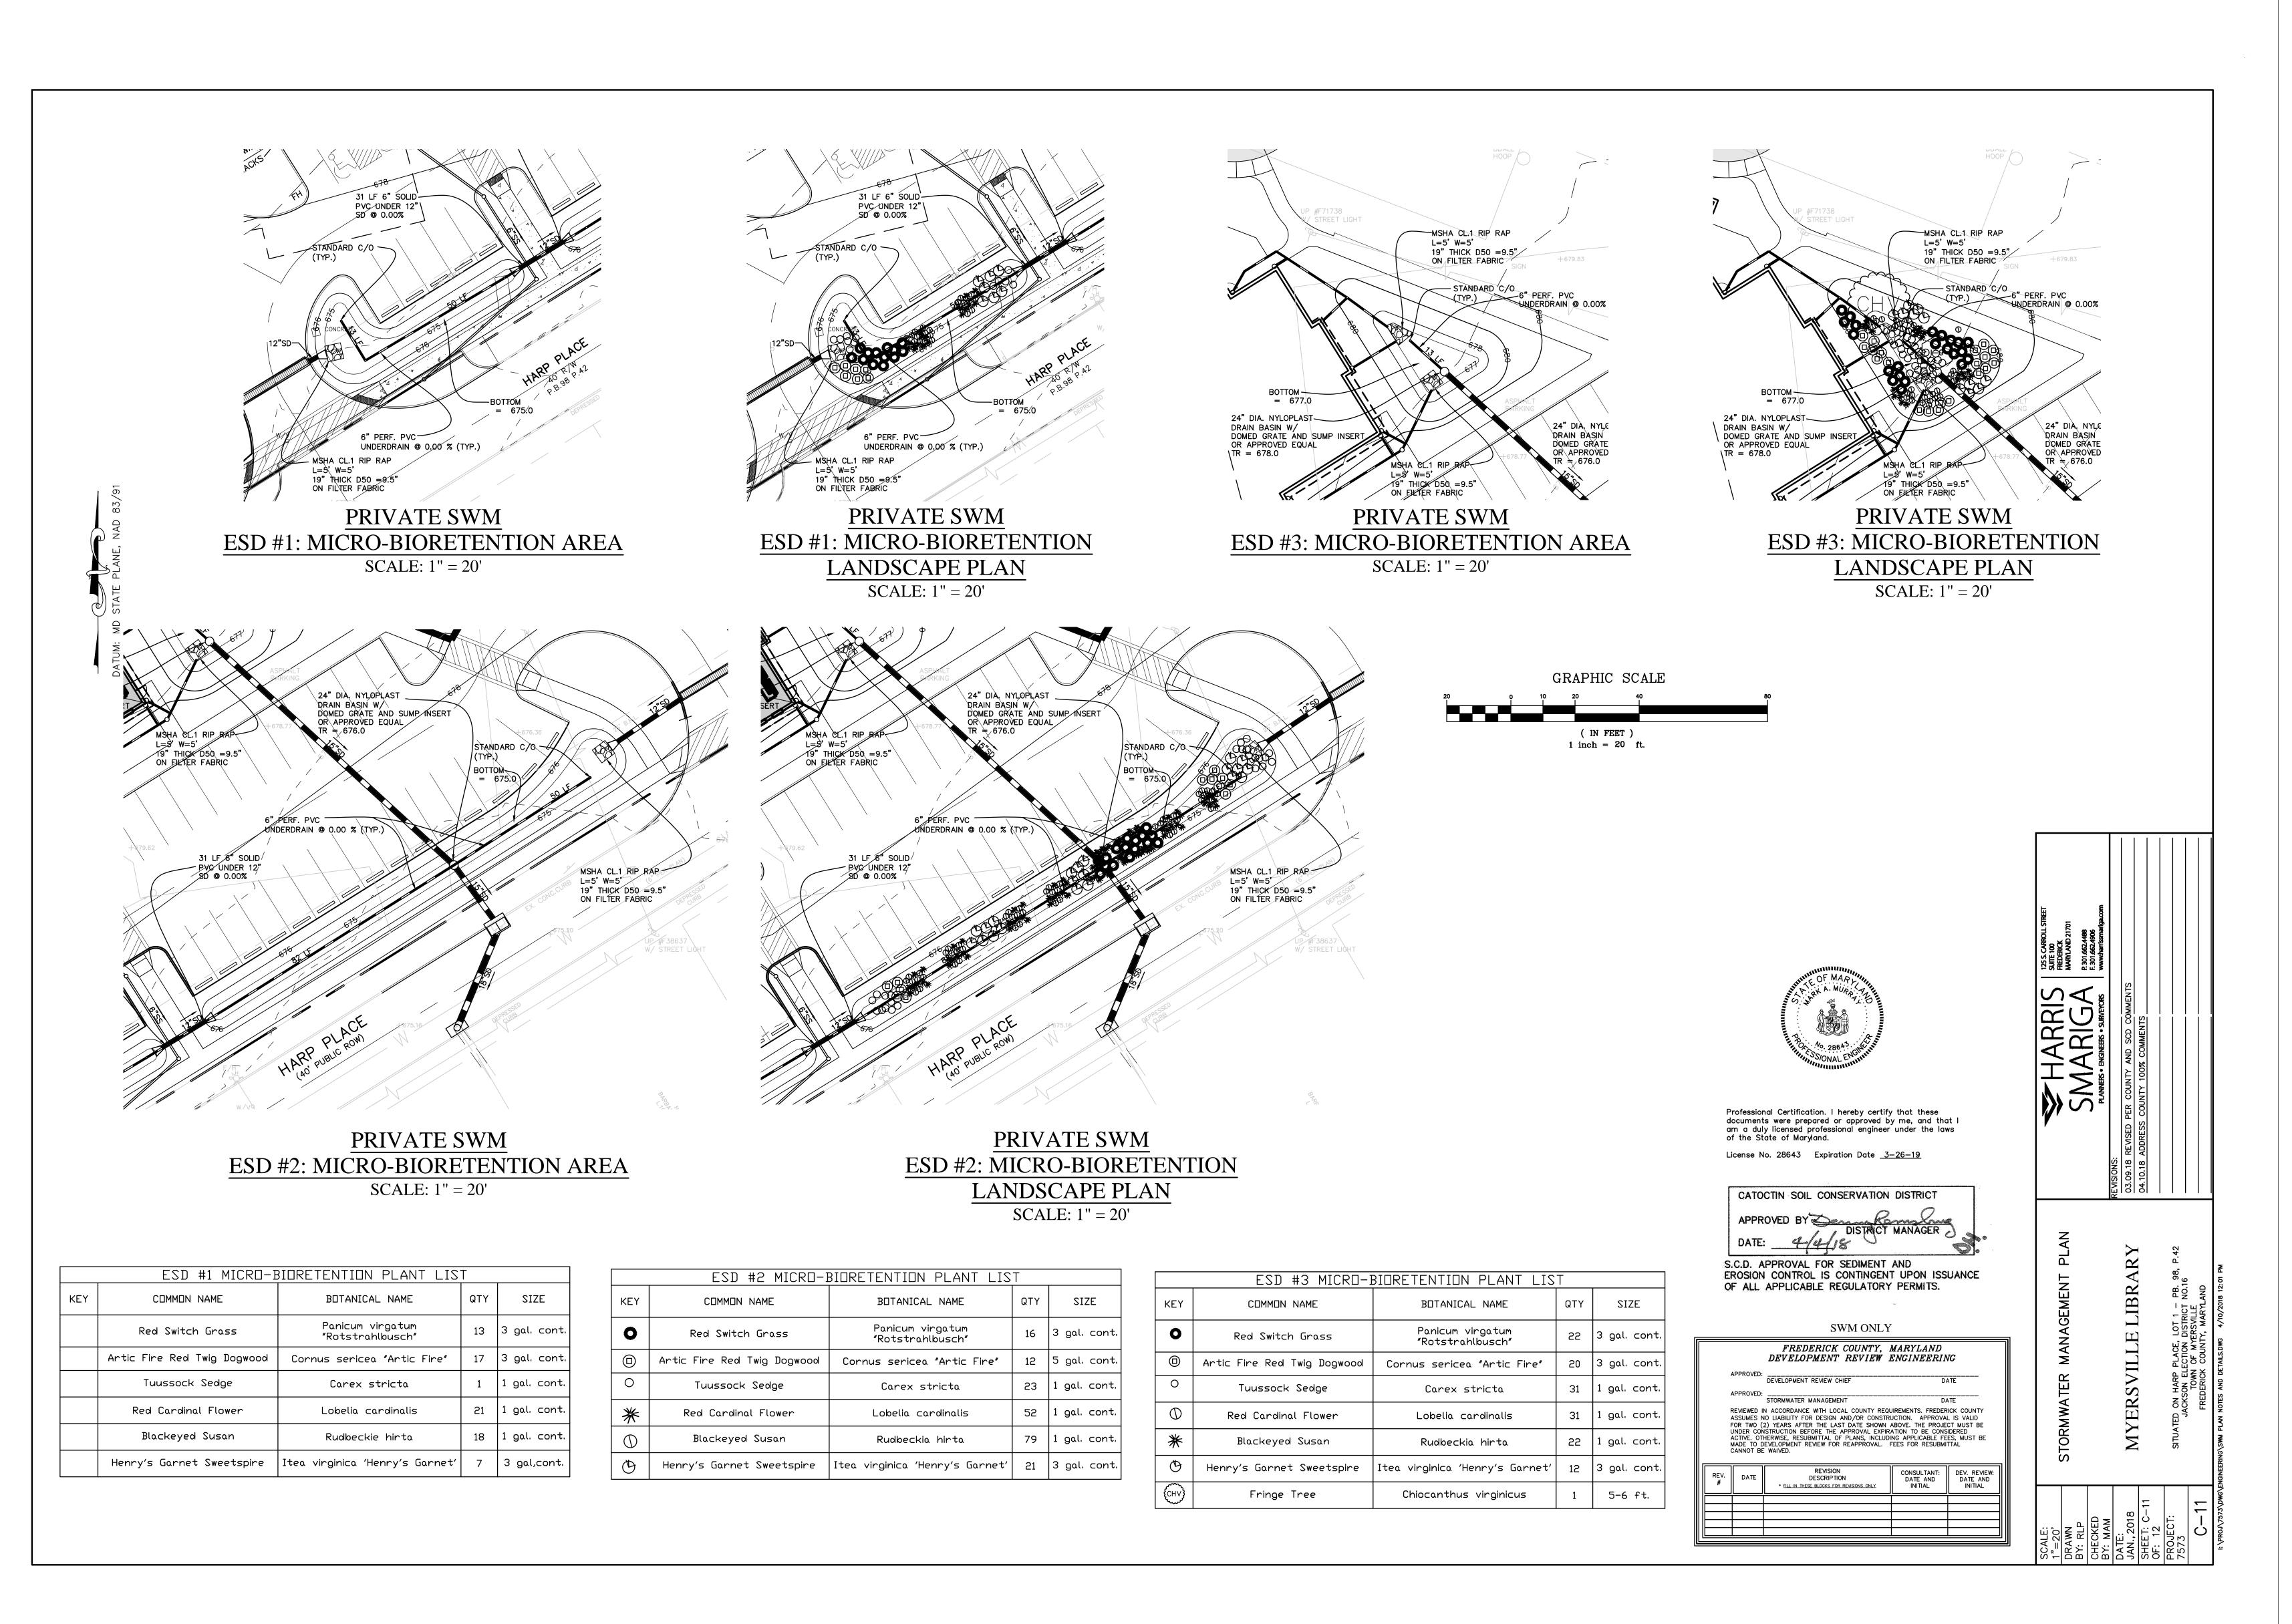

PROJECT TITLE

PROJECT HILE

MYERSVILLE COMMUNITY LIBRARY

PROJECT ADDRESS

8 HARP PLACE
MYERSVILLE, MD 21773

PROJECT OWNER

FREDERICK COUNTY,
MARYLAND
DEPARTMENT OF PUBLIC
WORKS

PROJECT TEAM

<u>ARCHITECT</u>

John Bertill TELEVII Armitica BLESTAN BLEST PALITYRANI, below Lapanja

6 NORTH EAST STREET, SUITE 300 FREDERICK, MD | 21701-5680 P: 301.662.8611 | F: 301.662.8632 NOELKERHULL.COM PA | MD | VA

STRUCTURAL ENGINEER

ABEL CONSULTING ENGINEERS

9055 COMPRINT COURT, SUITE 370 | GAITHERSBURG, MD | 20878

M/E/P ENGINEER

CJL ENGINEERING


3 WEST SECOND STREET | FREDERICK, MD | 00000-0000 P: 301.695.9424 | F: 301.293.6338

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P: 301.662.4488 | F: 301.662.4906



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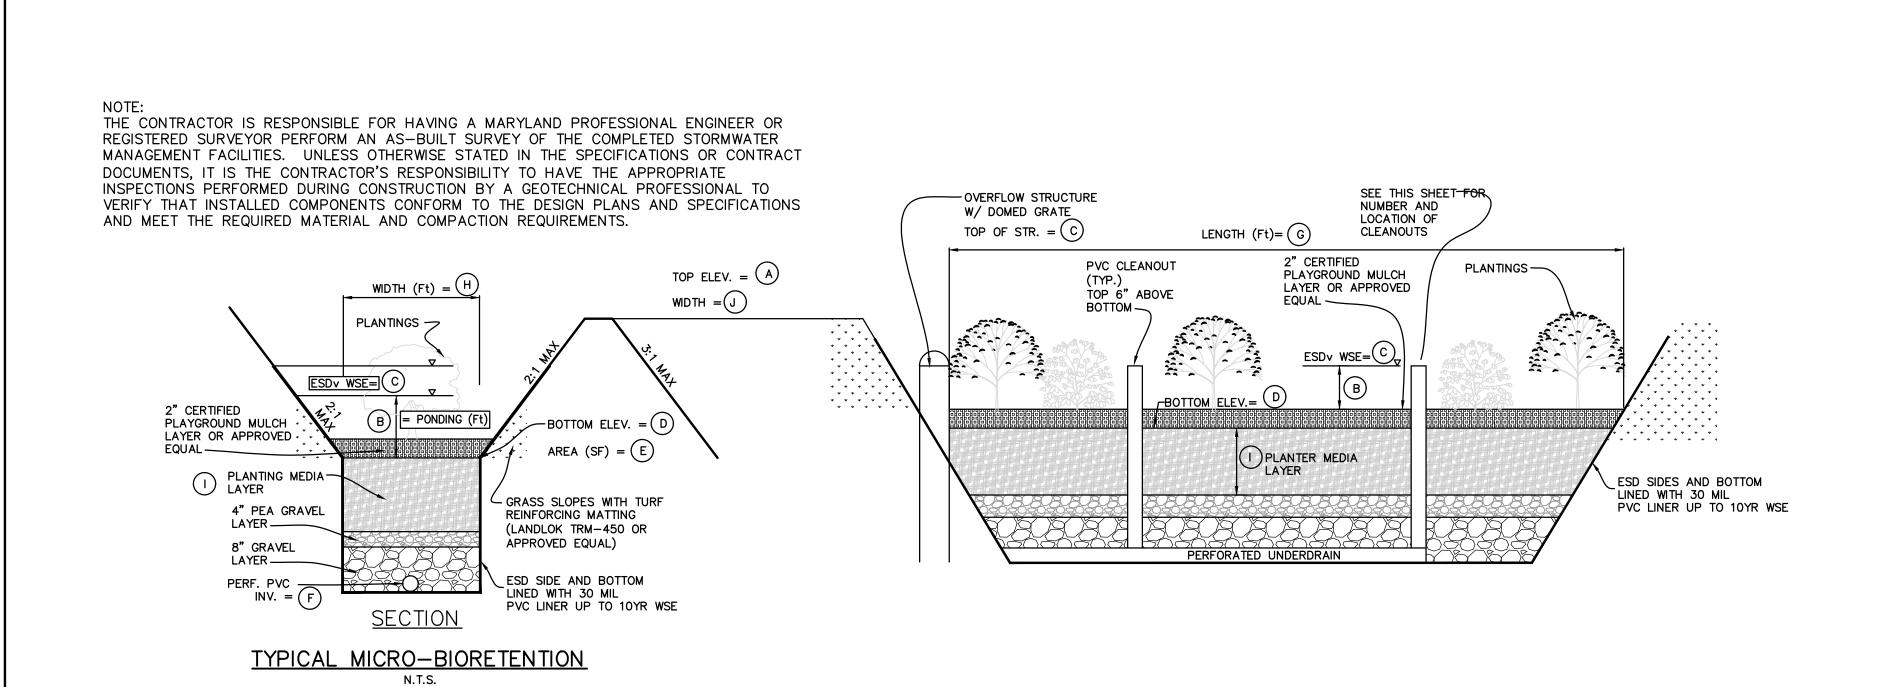
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PROJECT STATUS

JOB NUMBER: 17905
ISSUE DATE: 10 APRIL 2018
SCALE:
SHEET TITLE:

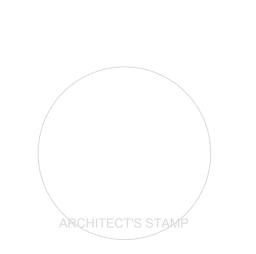SHEET NUMBER:


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MICRO-BIORETENTION AREA DIMENSIONS

MBR#	А	В	С	D	E	F	G	Н	I	J
1	676.5	1.0	676.0	675.0	446	270.5	30±	30 ±	4.0	1
2	676.5	1.0	676.0	675.0	738	263.0	80±	30 ±	4.0	1
3	680.0	1.0	678.0	677.0	264	275.5	116±	35 ±	4.0	2

NOTE: SEE PLAN VIEW SECTIONS FOR MORE DETAIL




Material	Specification	Size	Notes
Plantings	see Appendix A, Table A.4	n/a	plantings are site-specific
Planting soil [2' to 4' deep]	loamy sand (60 - 65%) & compost (35 - 40%) or sandy loam (30%), coarse sand (30%) & compost (40%)	n/a	USDA soil types loamy sand or sandy loam; clay content
Organic content	Min. 10% by dry weight (ASTM D 2974)		
(SEE DETAIL)			
Pea gravel diaphragm	pea gravel: ASTM-D-448	NO. 8 OR NO. 9 (1/8" TO 3/8")	
Curtain drain	ornamental stone: washed cobbles	stone: 2" to 5"	
Geotextile		n/a	PE Type 1 nonwoven
Gravel (underdrains and infiltration berms)	AASHTO M-43	NO. 57 OR NO. 6 AGGREGATE (3/8" to 3/4")	
Underdrain piping	F 758, Type PS 28 or AASHTO M-278	4" to 6" rigid schedule 40 PVC or SDR35	Slotted or perforated pipe; 3/8" perf. @ 6" on center, 4 hol row; minimum of 3" of gravel over pipes; not necessary underneath pipes. Perforated pipe shall be wrapped with ½ galvanized hardware cloth
Poured in place concrete (if required)	MSHA Mix No. 3; $f_e = 3500$ psi @ 28 days, normal weight, air-entrained; reinforcing to meet ASTM-615-60	n/a	on-site testing of poured-in-place concrete required: 28 day strength and slump test; all concrete design (cast-in or pre-cast) not using previously approved State or local standards requires design drawings sealed and approved b professional structural engineer licensed in the State of Ma-design to include meeting ACI Code 350.R/89; vertical le [H-10 or H-20]; allowable horizontal loading (based on so pressures); and analysis of potential cracking
Sand	AASHTO-M-6 or ASTM-C-33	0.02" to 0.04"	Sand substitutions such as Diabase and Graystone (AASH #10 are not acceptable. No calcium carbonated or dolomit substitutions are acceptable. No "rock dust" can be used for

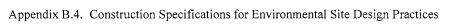

Professional Certification. I hereby certify that these documents were prepared or approved by me, and that I am a duly licensed professional engineer under the laws of the State of Maryland.

License No. 28643 Expiration Date 3-26-19

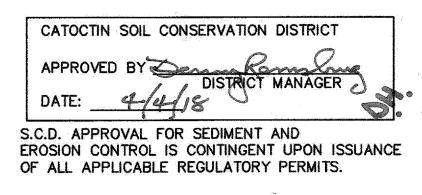

SWM ONLY

_			SWM ONLY	<u> </u>	
			FREDERICK COUNTY, DEVELOPMENT REVIEW		īG
		APPROVED:	DEVELOPMENT REVIEW CHIEF	DA	ATE
		APPROVED:	STORMWATER MANAGEMENT	D#	ATE
	i	ASSUMES N FOR TWO (UNDER CON ACTIVE. OT	N ACCORDANCE WITH LOCAL COUNTY REQUISION LIABILITY FOR DESIGN AND/OR CONSTRICED FOR A STATE SHOWN. STRUCTION BEFORE THE APPROVAL EXPIREMESE, RESUBMITTAL OF PLANS, INCLUDING PORTON OF PROPERTY OF PR	UCTION. APPROVAI ABOVE. THE PROJEI ATION TO BE CONS ING APPLICABLE FE	L IS VALID CT MUST BE IDERED ES, MUST BE
	REV. #	DATE	REVISION DESCRIPTION * FILL IN THESE BLOCKS FOR REVISIONS ONLY	CONSULTANT: DATE AND INITIAL	DEV. REVIEW: DATE AND INITIAL
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r notes	SMARKS SUITE 100 REDERICK MARRIAND 21701 SMARKIAND 21701 R. 301 662.4988 F. 301 662.4988 F. 301 662.4988 F. 301 662.4988
ARY	REVISIONS: 03.09.18 REVISED PER COUNTY AND SCD COMMENTS 04.10.18 ADDRESS COUNTY 100% COMMENTS
98, P.42 6	

PROJECT INFORMATION

PROJECT TITLE

MYERSVILLE

COMMUNITY

LIBRARY

PROJECT ADDRESS

8 HARP PLACE
MYERSVILLE, MD 21773

PROJECT OWNER

FREDERICK COUNTY,

MARYLAND

DEPARTMENT OF PUBLIC

WORKS

PROJECT TEAM

<u>ARCHITECT</u>

6 NORTH EAST STREET, SUITE 300

PA | MD | VA

STRUCTURAL ENGINEER

ABEL CONSULTING ENGINEERS

M/E/P ENGINEER

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<u>CIVIL ENGINEER</u>

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9055 COMPRINT COURT, SUITE 370 | GAITHERSBURG, MD | 20878 P: 301.258.8884 | F: 301.258.9457


FREDERICK, MD | 21701-5680 P: 301.662.8611 | F: 301.662.8632 NOELKERHULL.COM

SHEET INFORMATION

KEY PLAN

REV. #: DESCRIPTION: DATE:
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3 NUMBER:	17905
JE DATE:	10 APRIL 2018
ALE:	
ET TITLE:	
ET NUMBER:	
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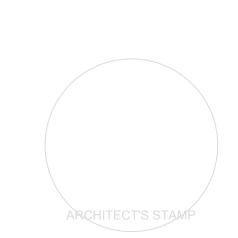
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HARRIS, SMARIGA & ASSOCIATES, INC.

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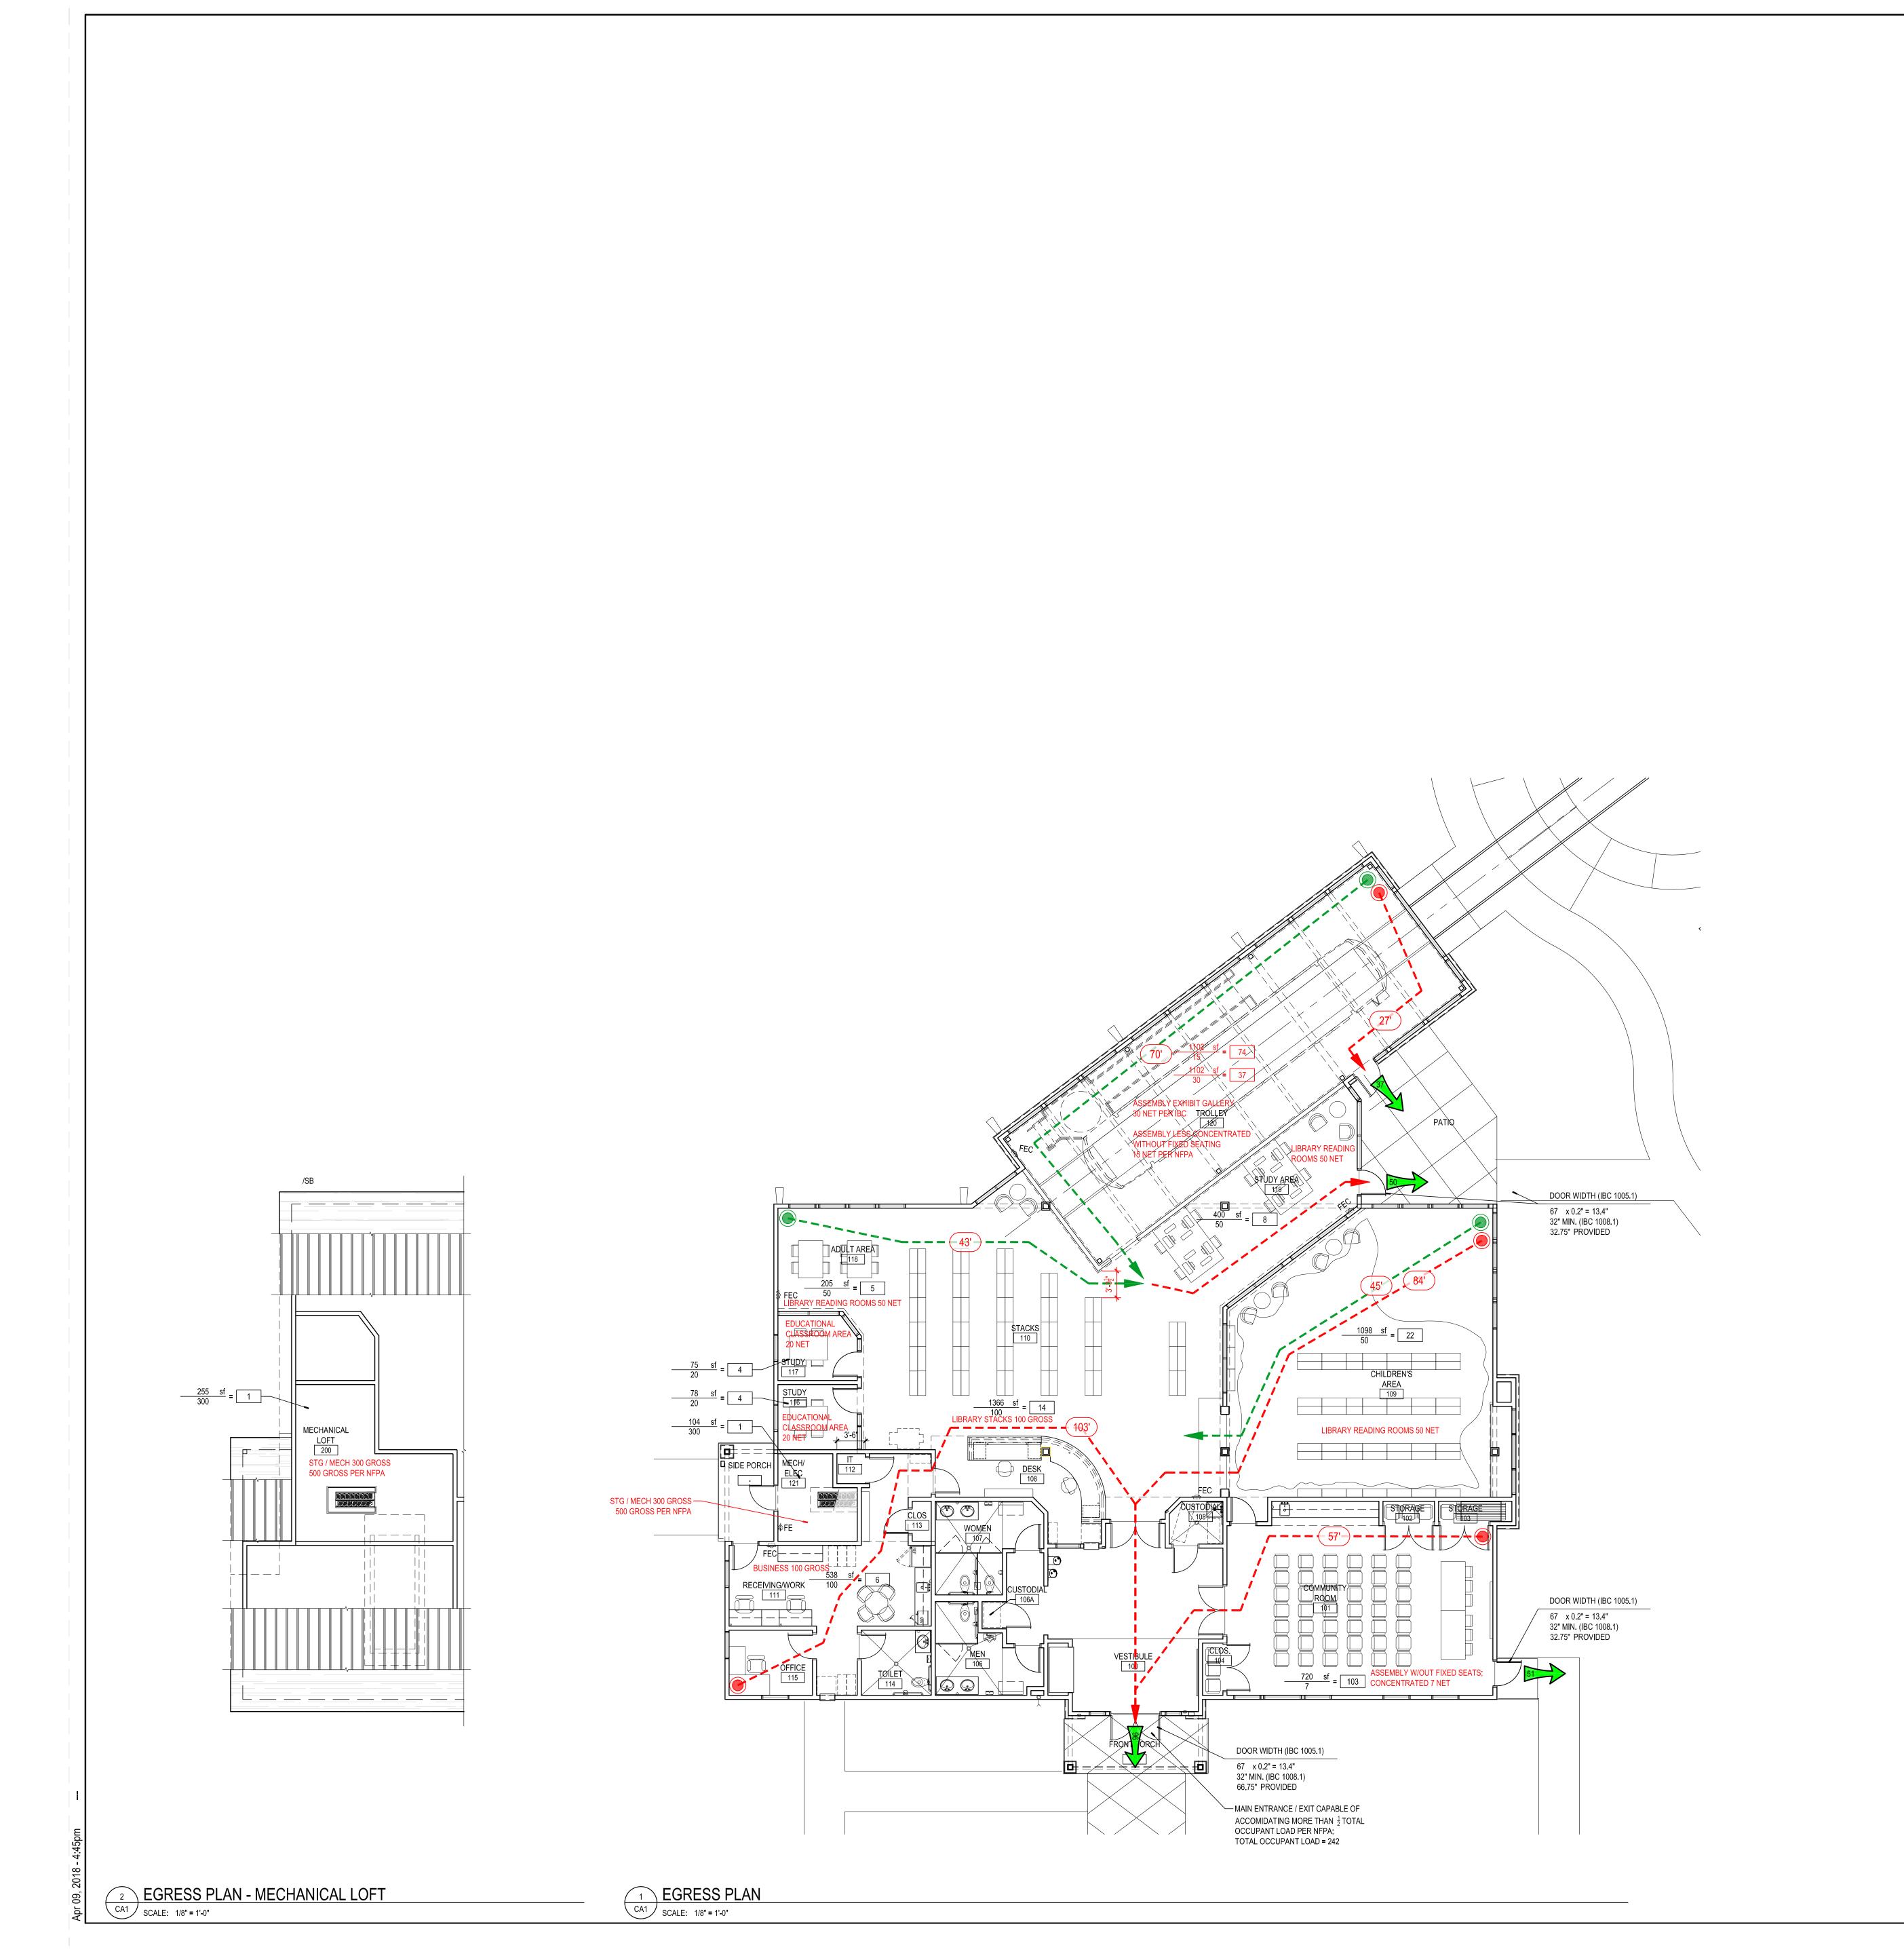
REV. #: DESCRIPTION: DATE:
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PROJECT STATUS

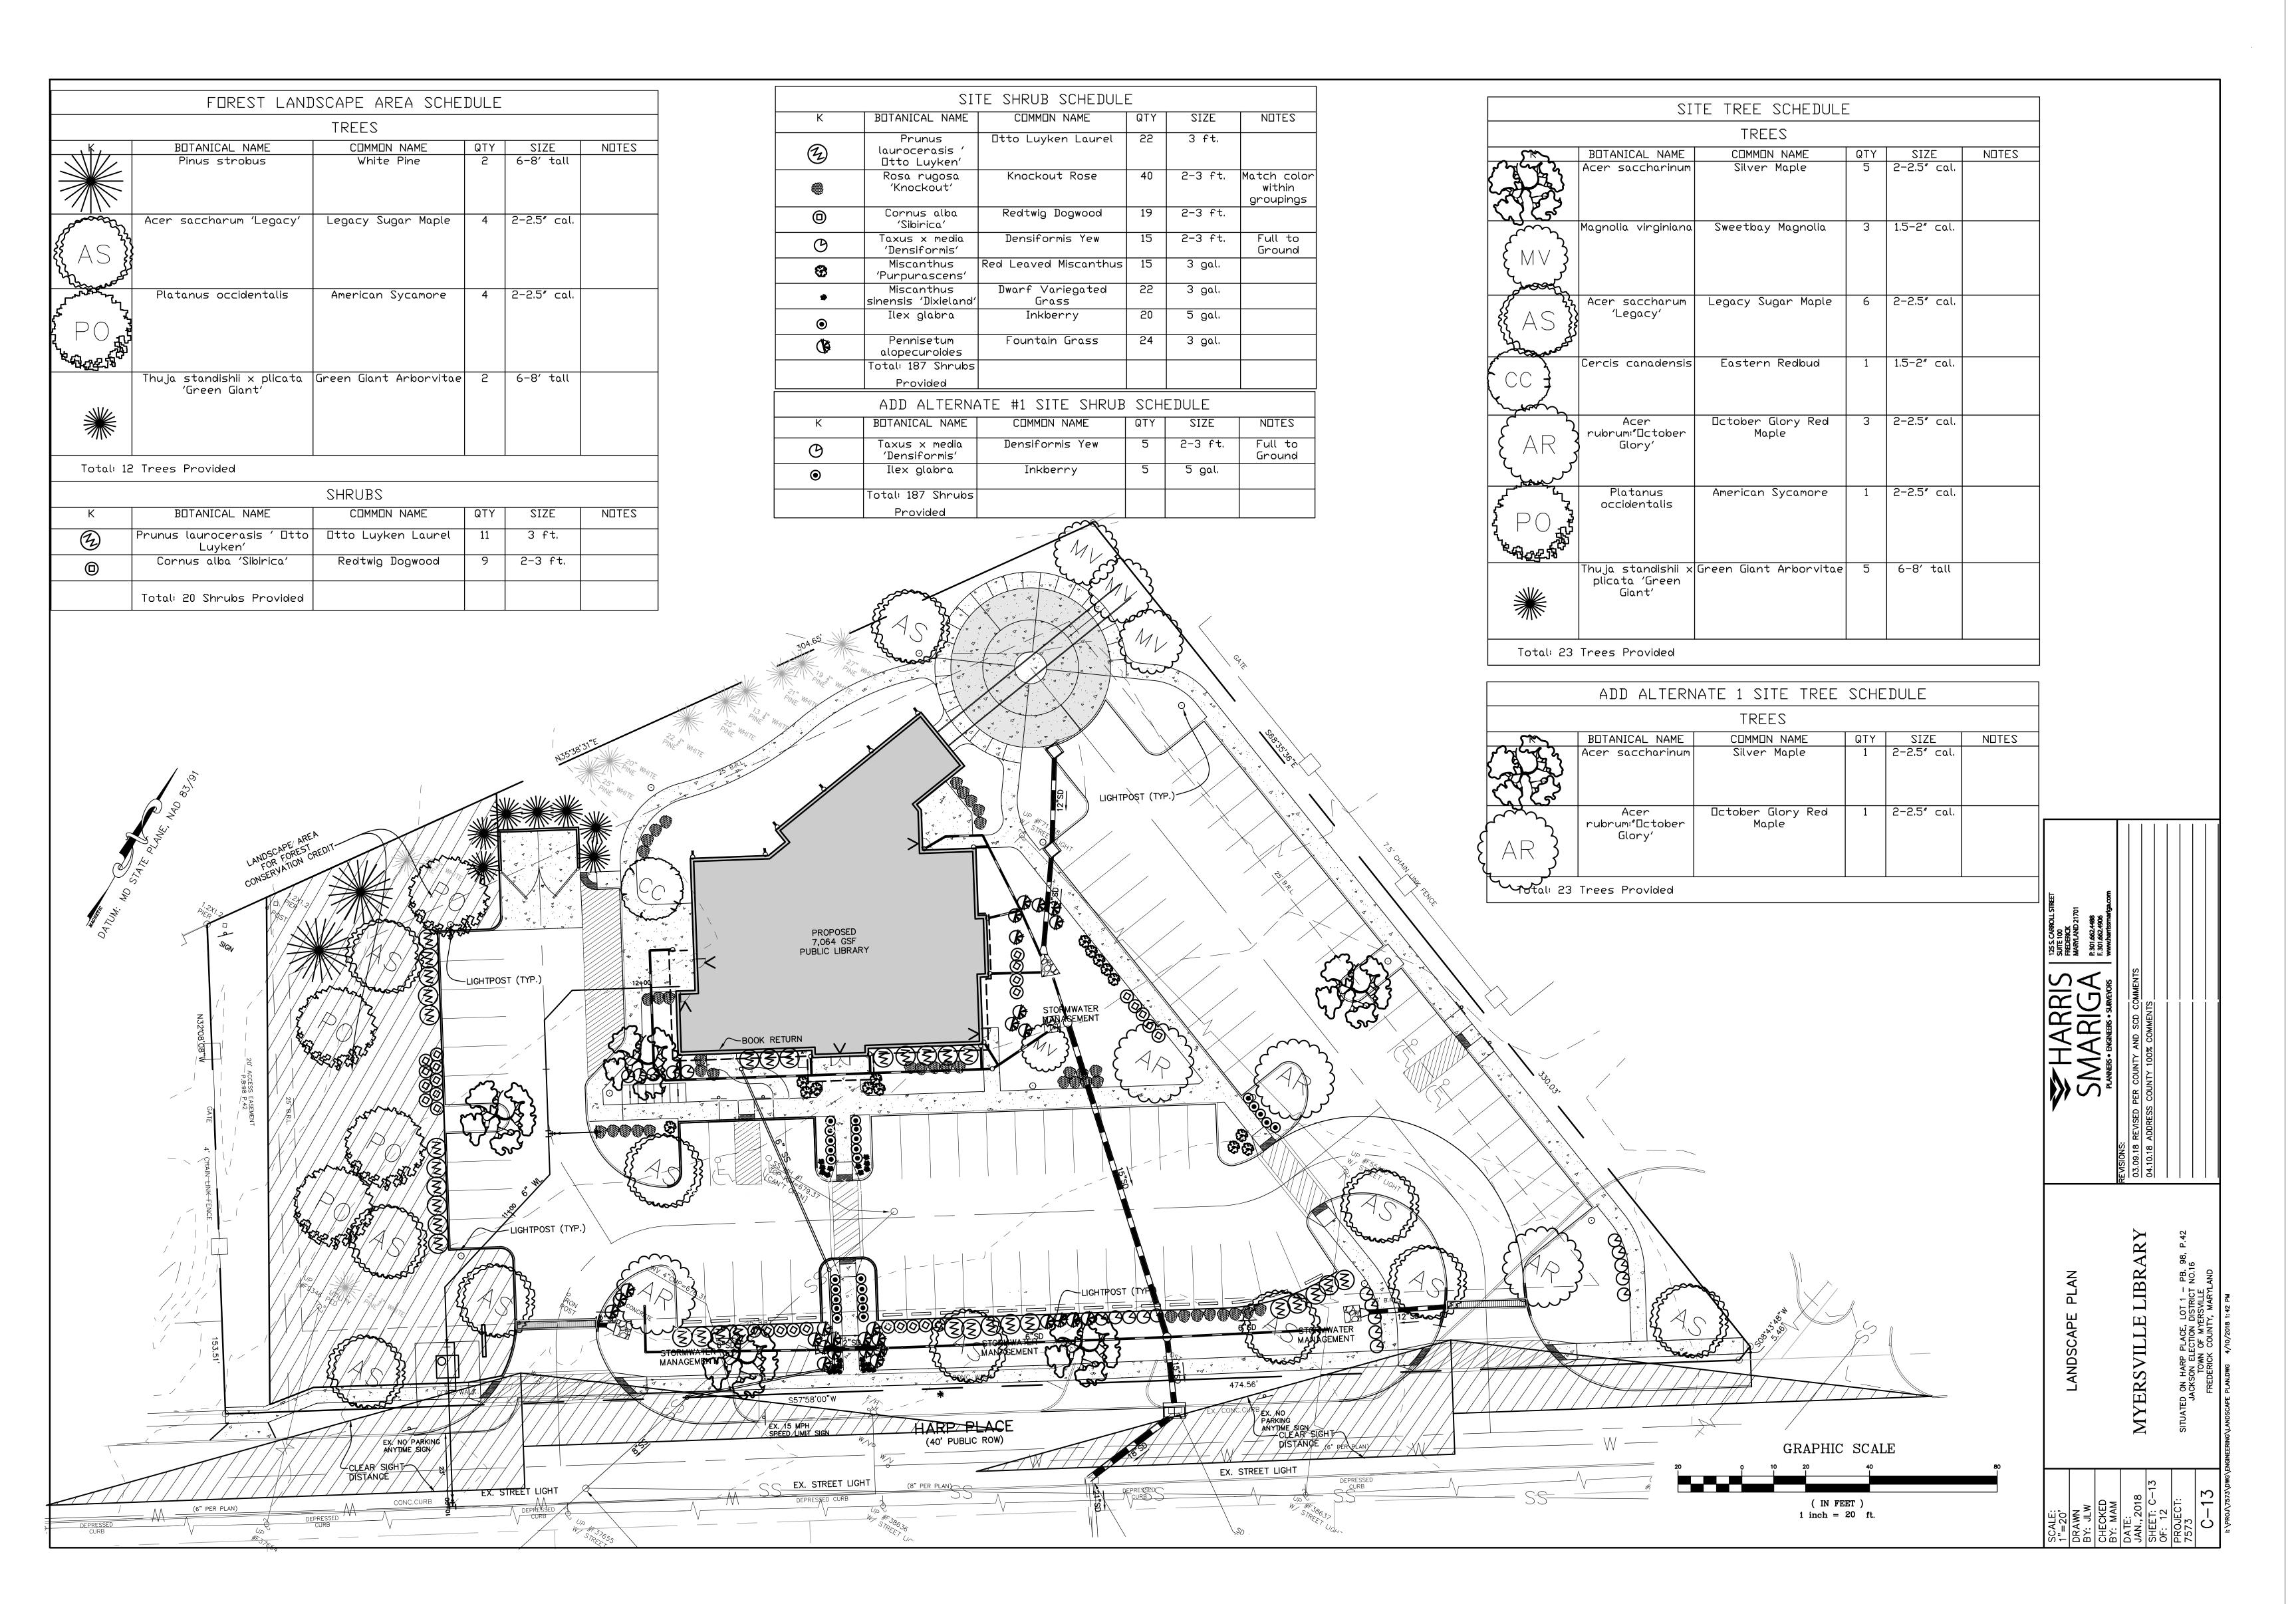JOB NUMBER: 17905
ISSUE DATE: 10 APRIL 2018
SCALE:
SHEET TITLE:

SHEET NUMBER:

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CODE ANALYSIS SUMMARY

PROJECT:
MYERSVILLE COMMUNITY LIBRARY 8 HARP PLACE

MYERSVILLE, MARYLAND 21773 FREDERICK COUNTY

APPLICABLE CODES:
2015 ICC INTERNATIONAL BUILDING CODE (IBC) WITH LOCAL AMENDMENTS 2014 NEC NATIONAL ELECTRICAL CODE 2015 ICC INTERNATIONAL PLUMBING CODE (IPC) WITH LOCAL AMENDMENTS 2015 ICC INTERNATIONAL FUEL GAS CODE (IFGC) WITH LOCAL AMENDMENTS 2015 ICC INTERNATIONAL MECHANICAL CODE 2015 NFPA 1 FIRE CODE WITH STATE AMENDMENTS 2015 NFPA 101 LIFE SAFETY CODE WITH STATE AMENDMENTS

2015 ICC INTERNATIONAL ENERGY CONSERVATION CODE 2009 ICC / ANSI A117.1-2009 EDITION 2012 MARYLAND ACCESSIBILITY CODE SECTION COMAR 05.02.02 2015 MARYLAND BUILDING PERFORMANCE STANDARDS COMAR

GROSS AREA:

BUILDING	AREA (GROSS SQ. FT.
LIBRARY	6,895 SQ. FT.
TOTAL GROSS AREA =	6,895 SQ. FT.

USE GROUP MATRIX:

	2015 IBC 2015 NFPA 101							
LIBRARY A-3 ASSEMBLY OCCUPANCY NEW ASSEMBLY OCCUPANCY ≤ 300 OCCUPANTS								
ONSTRUCTION TYPE MATRIX.								

CONSTRUCTION TYPE MATRIX:

_		_	
		2015 IBC	2015 NFPA 101
	LIBRARY	TYPE IIB FULLY SPRINKLERED (NFPA 13)	TYPE II (000) FULLY SPRINKLERED (NFPA 13)

HEIGHT ANALYSIS:

	2015 IBC	2015 NFPA 101	
	ALLOWABLE # OF STORIES / ALLOWABLE HEIGHT	ALLOWABLE # STORIES	ACTUAL # OF STORIES / ACTUAL HEIGHT
LIBRARY	3 STORIES / 75'	2 STORIES	1 STORY / 32'-10"

MAXIMUM BUILDING AREA DETERMINATION PER IBC:

	TABULAR ALLOWANCE	FRONTAGE ALLOWANCE	SPRINKLER ALLOWANCE	ADJUSTED ALLOW. (SQ. FT.)	ACTUAL BLDG. AREA (SQ. FT.)
LIBRARY	38,000 SQ. FT.	NOT USED	NOT USED	38,000 SQ. FT.	7,072 SQ. FT.

FIRE RESISTANCE SCHEDULE:

	2015 IBC	2015 NFPA 101	PROVIDED	REMARKS
STRUCTURAL FRAME (COLUMNS, GIRDERS, TRUSSES)	0 HOUR	0 HOUR	0 HOUR	
EXTERIOR BEARING WALLS	0 HOUR	0 HOUR	0 HOUR	
INTERIOR BEARING WALLS	0 HOUR	0 HOUR	0 HOUR	
FLOOR CONSTRUCTION	0 HOUR	0 HOUR	0 HOUR	
ROOF CONSTRUCTION	0 HOUR	0 HOUR	0 HOUR	
FIRE BARRIER - EXIT PASSAGEWAY	1 HOUR w/ 60 MIN DOOR	1 HOUR w/ 20 MIN DOOR	N/A	
FIRE BARRIER - STAIR ENCLOSURES	1 HOUR w/ 60 MIN DOOR	1 HOUR w/ 60 MIN DOOR	N/A	
FIRE BARRIER - SHAFT ENCLOSURES	1 HOUR w/ 60 MIN DOOR	1 HOUR w/ 60 MIN DOOR	N/A	
FIRE BARRIER - ELEVATOR SHAFT ENCLOSURES	1 HOUR w/ 60 MIN DOOR	1 HOUR w/ 60 MIN DOOR	N/A	
FIRE PARTITIONS - CORRIDOR WALLS	0 HOUR	0 HOUR	N/A	
SMOKE BARRIERS	1 HOUR w/ 20 MIN DOOR	1 HOUR w/ 20 MIN DOOR	N/A	
FIRE BARRIERS	2 HOUR w/ 90 MIN DOOR	2 HOUR w/ 90 MIN DOOR	N/A	


NOTE:
FIRE RETARDANT TREATED WOOD IS PERMITTED IN ROOF CONSTRUCTION (FOR TYPE II CONSTRUCTION), INCLUDING GIRDERS, TRUSSES, FRAMING AND BLOCKING PER IBC 603.1, 1.3.

CODE ANALYSIS LEGEND

TRAVEL DISTANCE LIMITATIONS

EXIT	—
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COMMON PATH (MAXIMUM 75'-0")

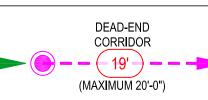


EXIT / EGRESS SYMBOLS



CALCULATED OCCUPANTS TO EXIT

WALL I	RATING KEY
WALL RATING	LINETYPE
0 HR SMOKE PARTITION	OHSP -
1/2 HR FIRE PARTITION	1/2HFP -
1 HR BEARING WALL	1HBW -
1 HR FIRE PARTITION	1HFP -
1 HR FIRE BARRIER	1HFB -
1 HR SMOKE BARRIER	1HSB -
1 HR EXTERIOR WALL	1HEW -
2 HR FIRE BARRIER	———— 2HFB -
2 HR FIRE WALL	2HFW -
3 HR FIRE WALL	3HFW -

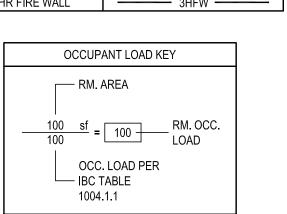

GENERAL CODE ANALYSIS NOTES

MAXIMUM COMMON PATH OF EGRESS LENGTH 100'-0" PER NFPA 101 18.2.5.3; MAXIMUM DEAD-END CORRIDOR LENGTH 30'-0" PER NFPA 101 18.2.5.2. MORE RESTRICTIVE LENGTHS PER IBC INDICATED IN TABLE.

PROJECT INFORMATION

PROJECT TITLE

MYERSVILLE COMMUNITY LIBRARY

PROJECT ADDRESS 8 HARP PLACE

MYERSVILLE, MD 21773 PROJECT OWNER

FREDERICK COUNTY, **MARYLAND** DEPARTMENT OF PUBLIC **WORKS**

PROJECT TEAM



ASSOCIATES, INC. ARCHITECTS

6 NORTH EAST STREET, SUITE 300 FREDERICK, MD | 21701-5680 P: 301.662.8611 | F: 301.662.8632 NOELKERHULL.COM


PA | MD | VA

STRUCTURAL ENGINEER ABEL CONSULTING ENGINEERS 9055 COMPRINT COURT, SUITE 370 | GAITHERSBURG, MD | 20878

P: 301.258.8884 | F: 301.258.9457

M/E/P ENGINEER CJL ENGINEERING 3 WEST SECOND STREET | FREDERICK, MD | 00000-0000 P: 301.695.9424 | F: 301.293.6338

<u>CIVIL ENGINEER</u> HARRIS, SMARIGA & ASSOCIATES, INC. 125 SOUTH CARROLL STREET | FREDERICK, MD | 21701 P: 301.662.4488 | F: 301.662.4906

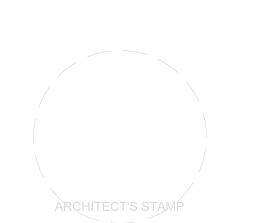


SHEET INFORMATION

<u>KEY PLAN</u>


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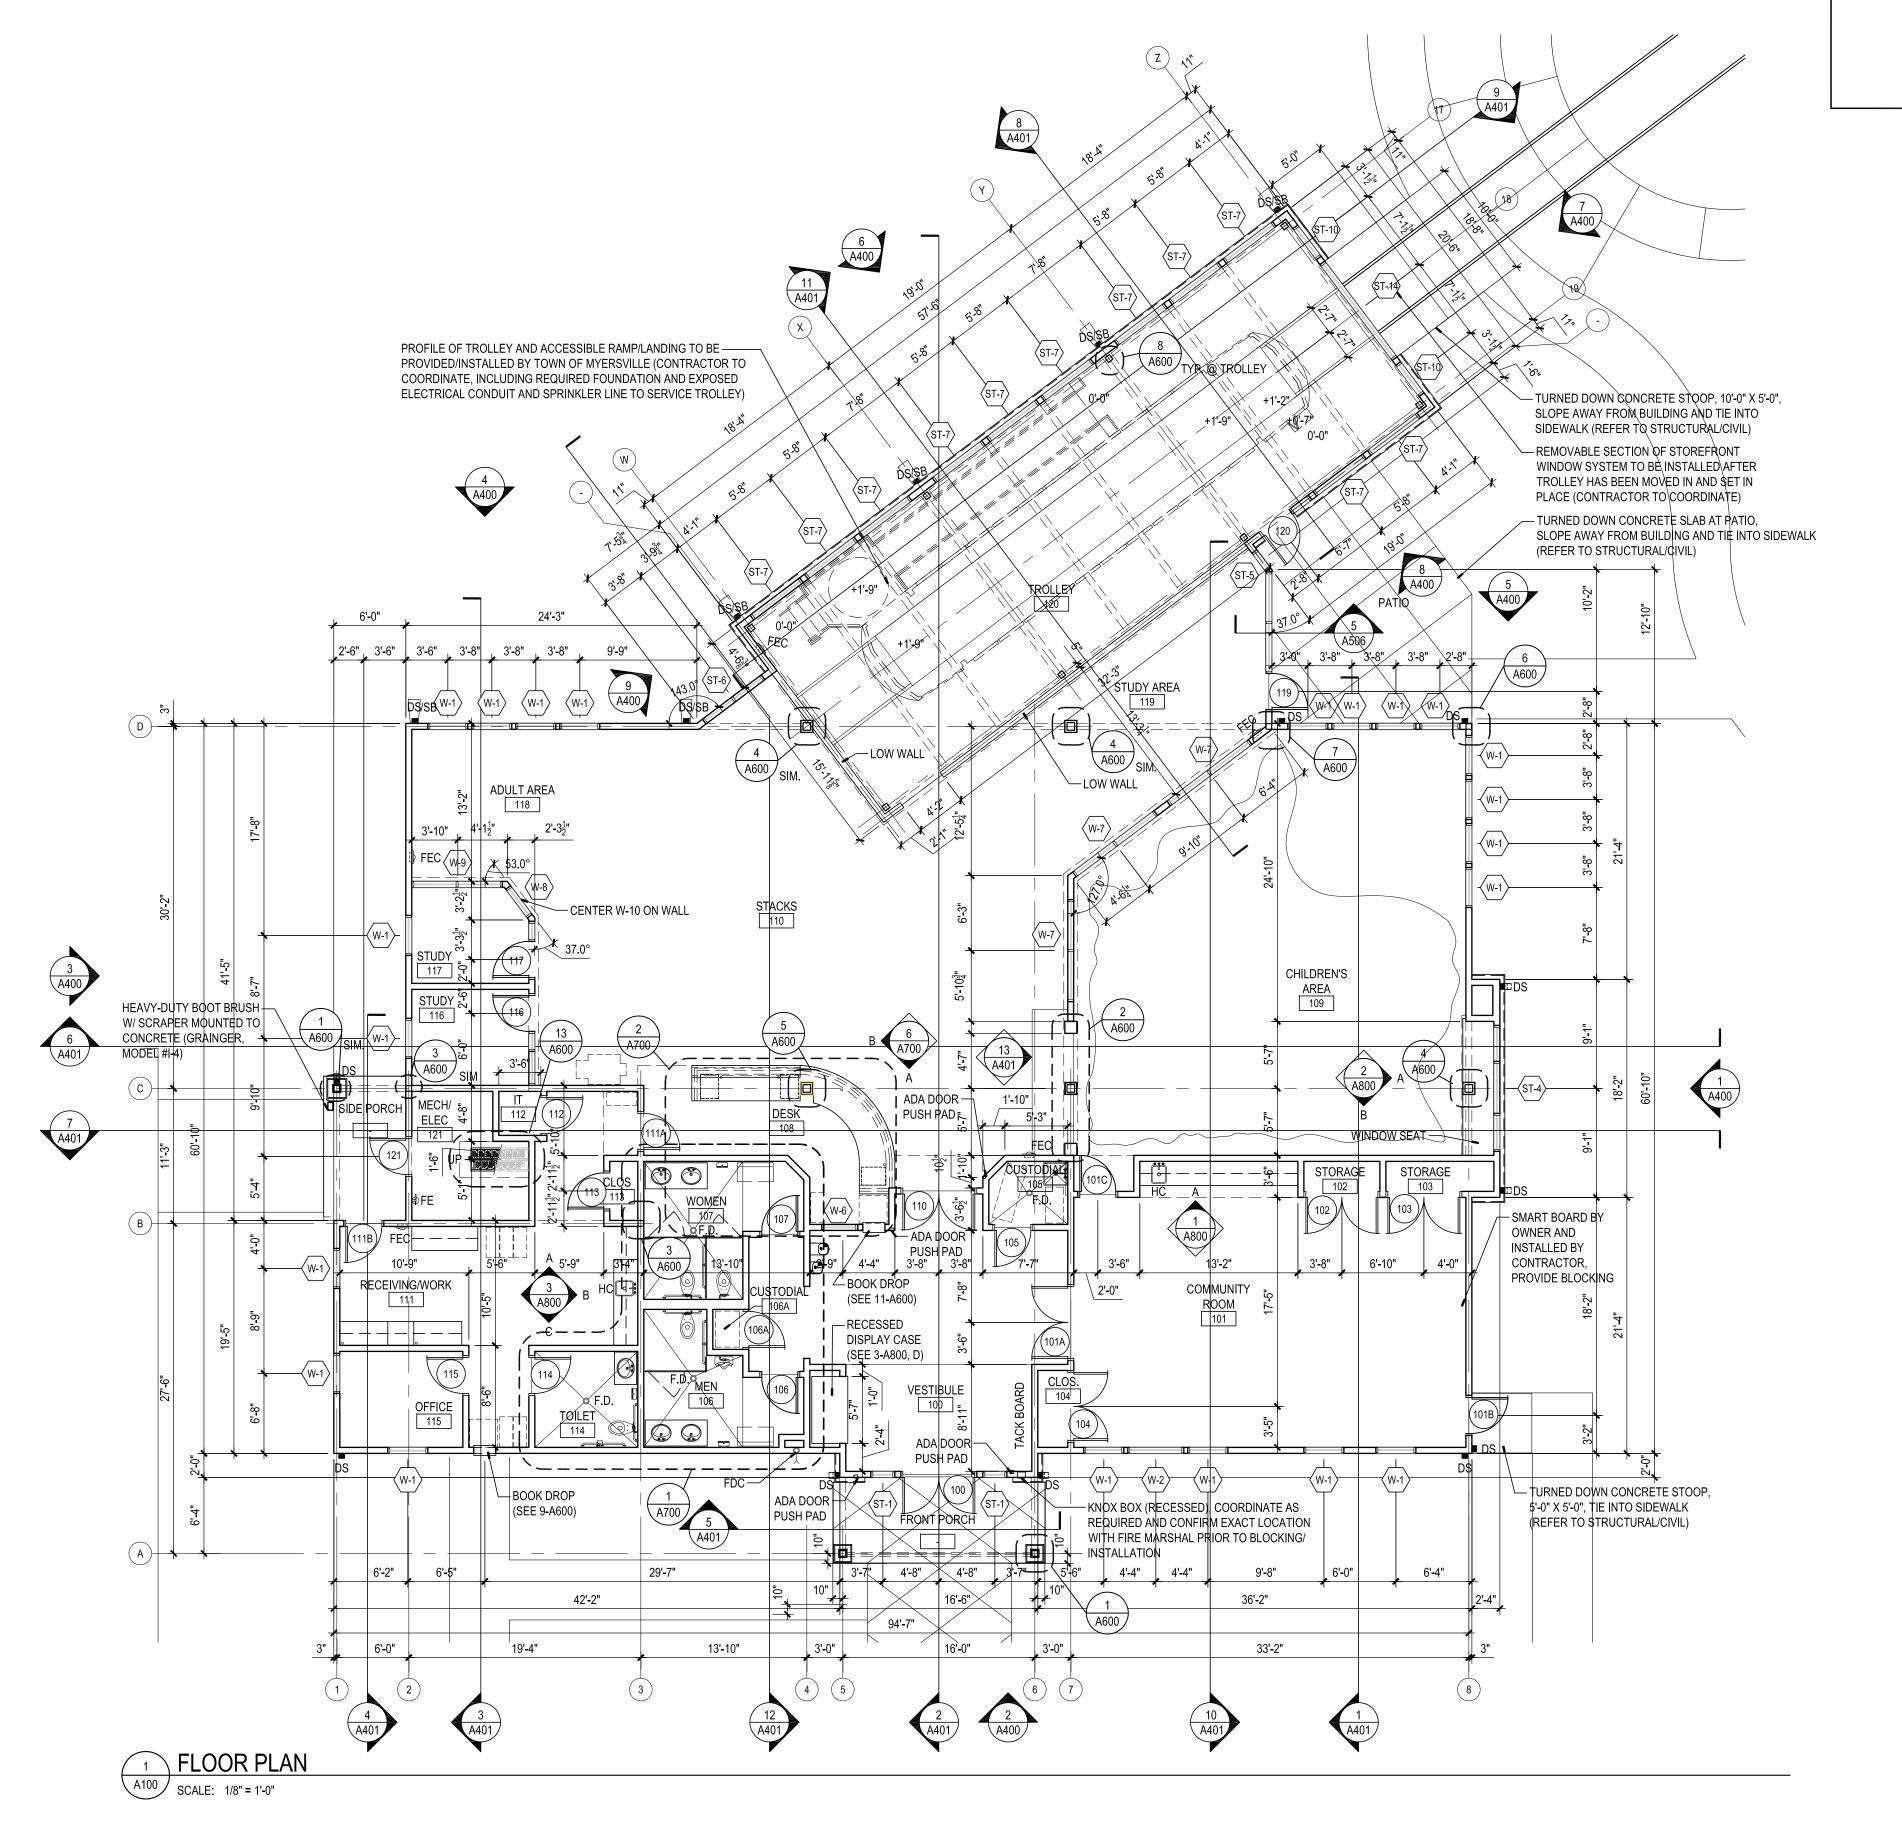
PROJECT STATUS

JOB NUMBER: 17905 ISSUE DATE: 23 MARCH 2018 SCALE: AS INDICATED SHEET TITLE: CODE ANALYSIS PLAN SHEET NUMBER:

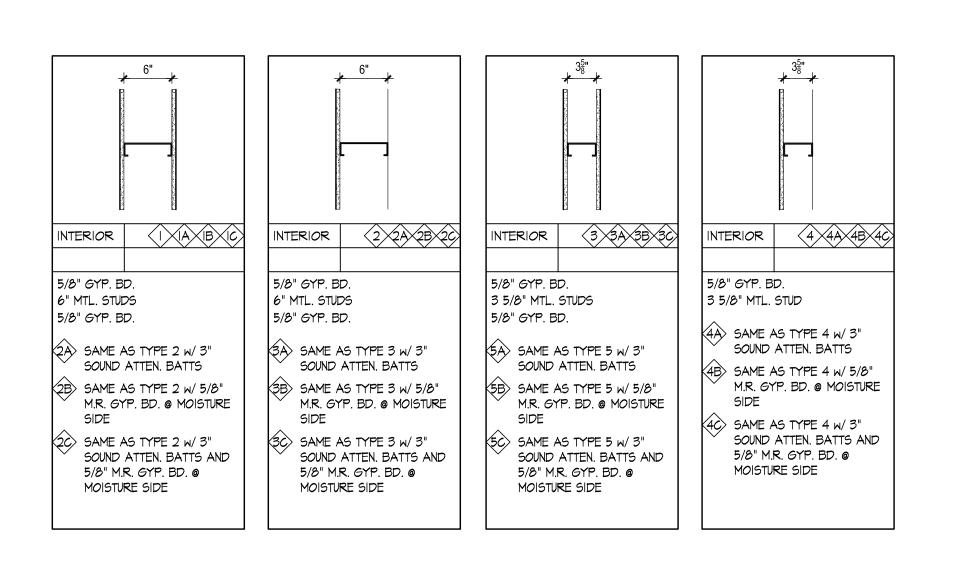

3 INTERIOR PARTITION SCHEDULE



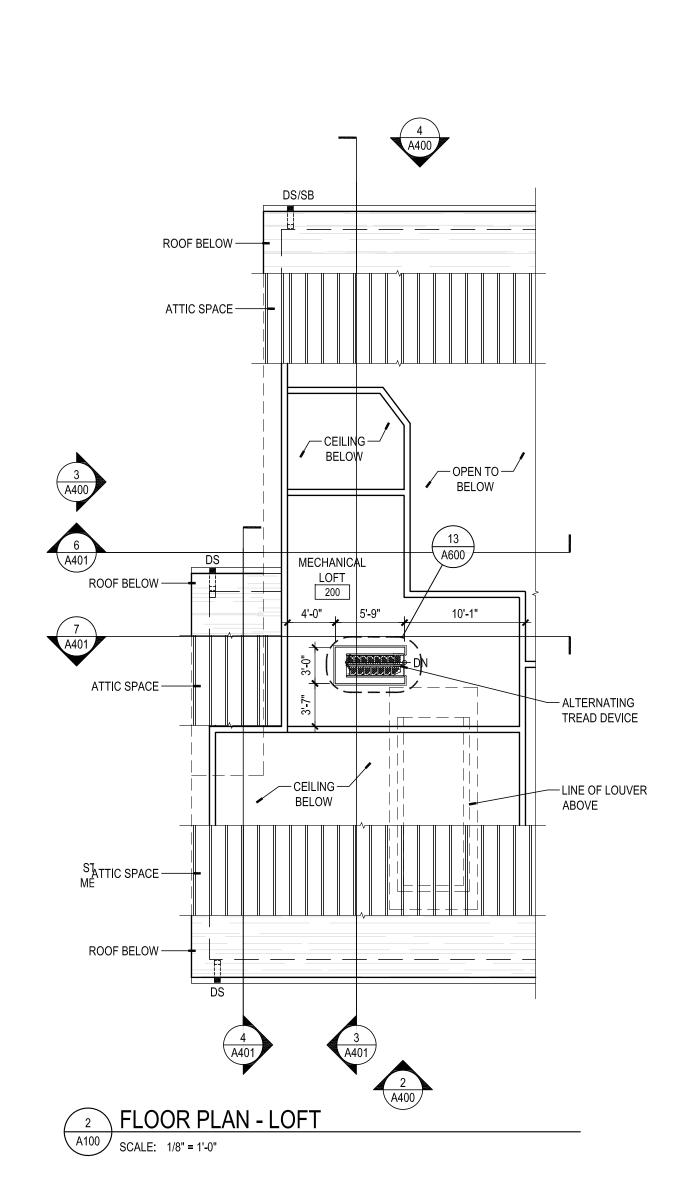

GENERAL PLAN NOTES

- CONTRACTOR AND ALL SUB-CONTRACTORS SHALL REVIEW ALL DRAWINGS AND FAMILIARIZE THEMSELVES WITH THE BUILDING, CONDITIONS, DETAILS AND ALL FACTORS WHICH WILL AFFECT THE WORK TO BE ACCOMPLISHED.
- ANY DISCREPANCIES ON THE DRAWINGS NOTED BY THE CONTRACTOR SHALL BE BROUGHT TO
- ALL WORK SHALL BE DONE IN ACCORDANCE WITH LOCAL, STATE AND FEDERAL REGULATIONS APPLICABLE TO THE PROJECT.

THE OWNER/ARCHITECT'S ATTENTION FOR RESOLUTION PRIOR TO BID SUBMISSION.

- REFER TO AND COORDINATE WITH CIVIL, STRUCTURAL, ELECTRICAL AND MECHANICAL DRAWINGS AND SPECIFICATIONS FOR ADDITIONAL WORK REQUIRED BUT NOT INDICATED ON
- WHERE REQUIRED, SLOPE FLOORS TO DRAIN(S) MINIMUM 1/8" PER FOOT FOR POSITIVE DRAINAGE AND COORDINATE ALL FLOOR DRAINS WITH PLUMBING DRAWINGS.

MYERSVILLE

COMMUNITY LIBRARY

PROJECT INFORMATION

PROJECT TITLE

PROJECT ADDRESS 8 HARP PLACE MYERSVILLE, MD 21773

PROJECT OWNER FREDERICK COUNTY, **MARYLAND** DEPARTMENT OF PUBLIC **WORKS**

PROJECT TEAM

NOELKER AND HULL ASSOCIATES, INC.

ARCHITECTS

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STRUCTURAL ENGINEER ABEL CONSULTING ENGINEERS 9055 COMPRINT COURT, SUITE 370 | GAITHERSBURG, MD | 20878 P: 301.258.8884 | F: 301.258.9457

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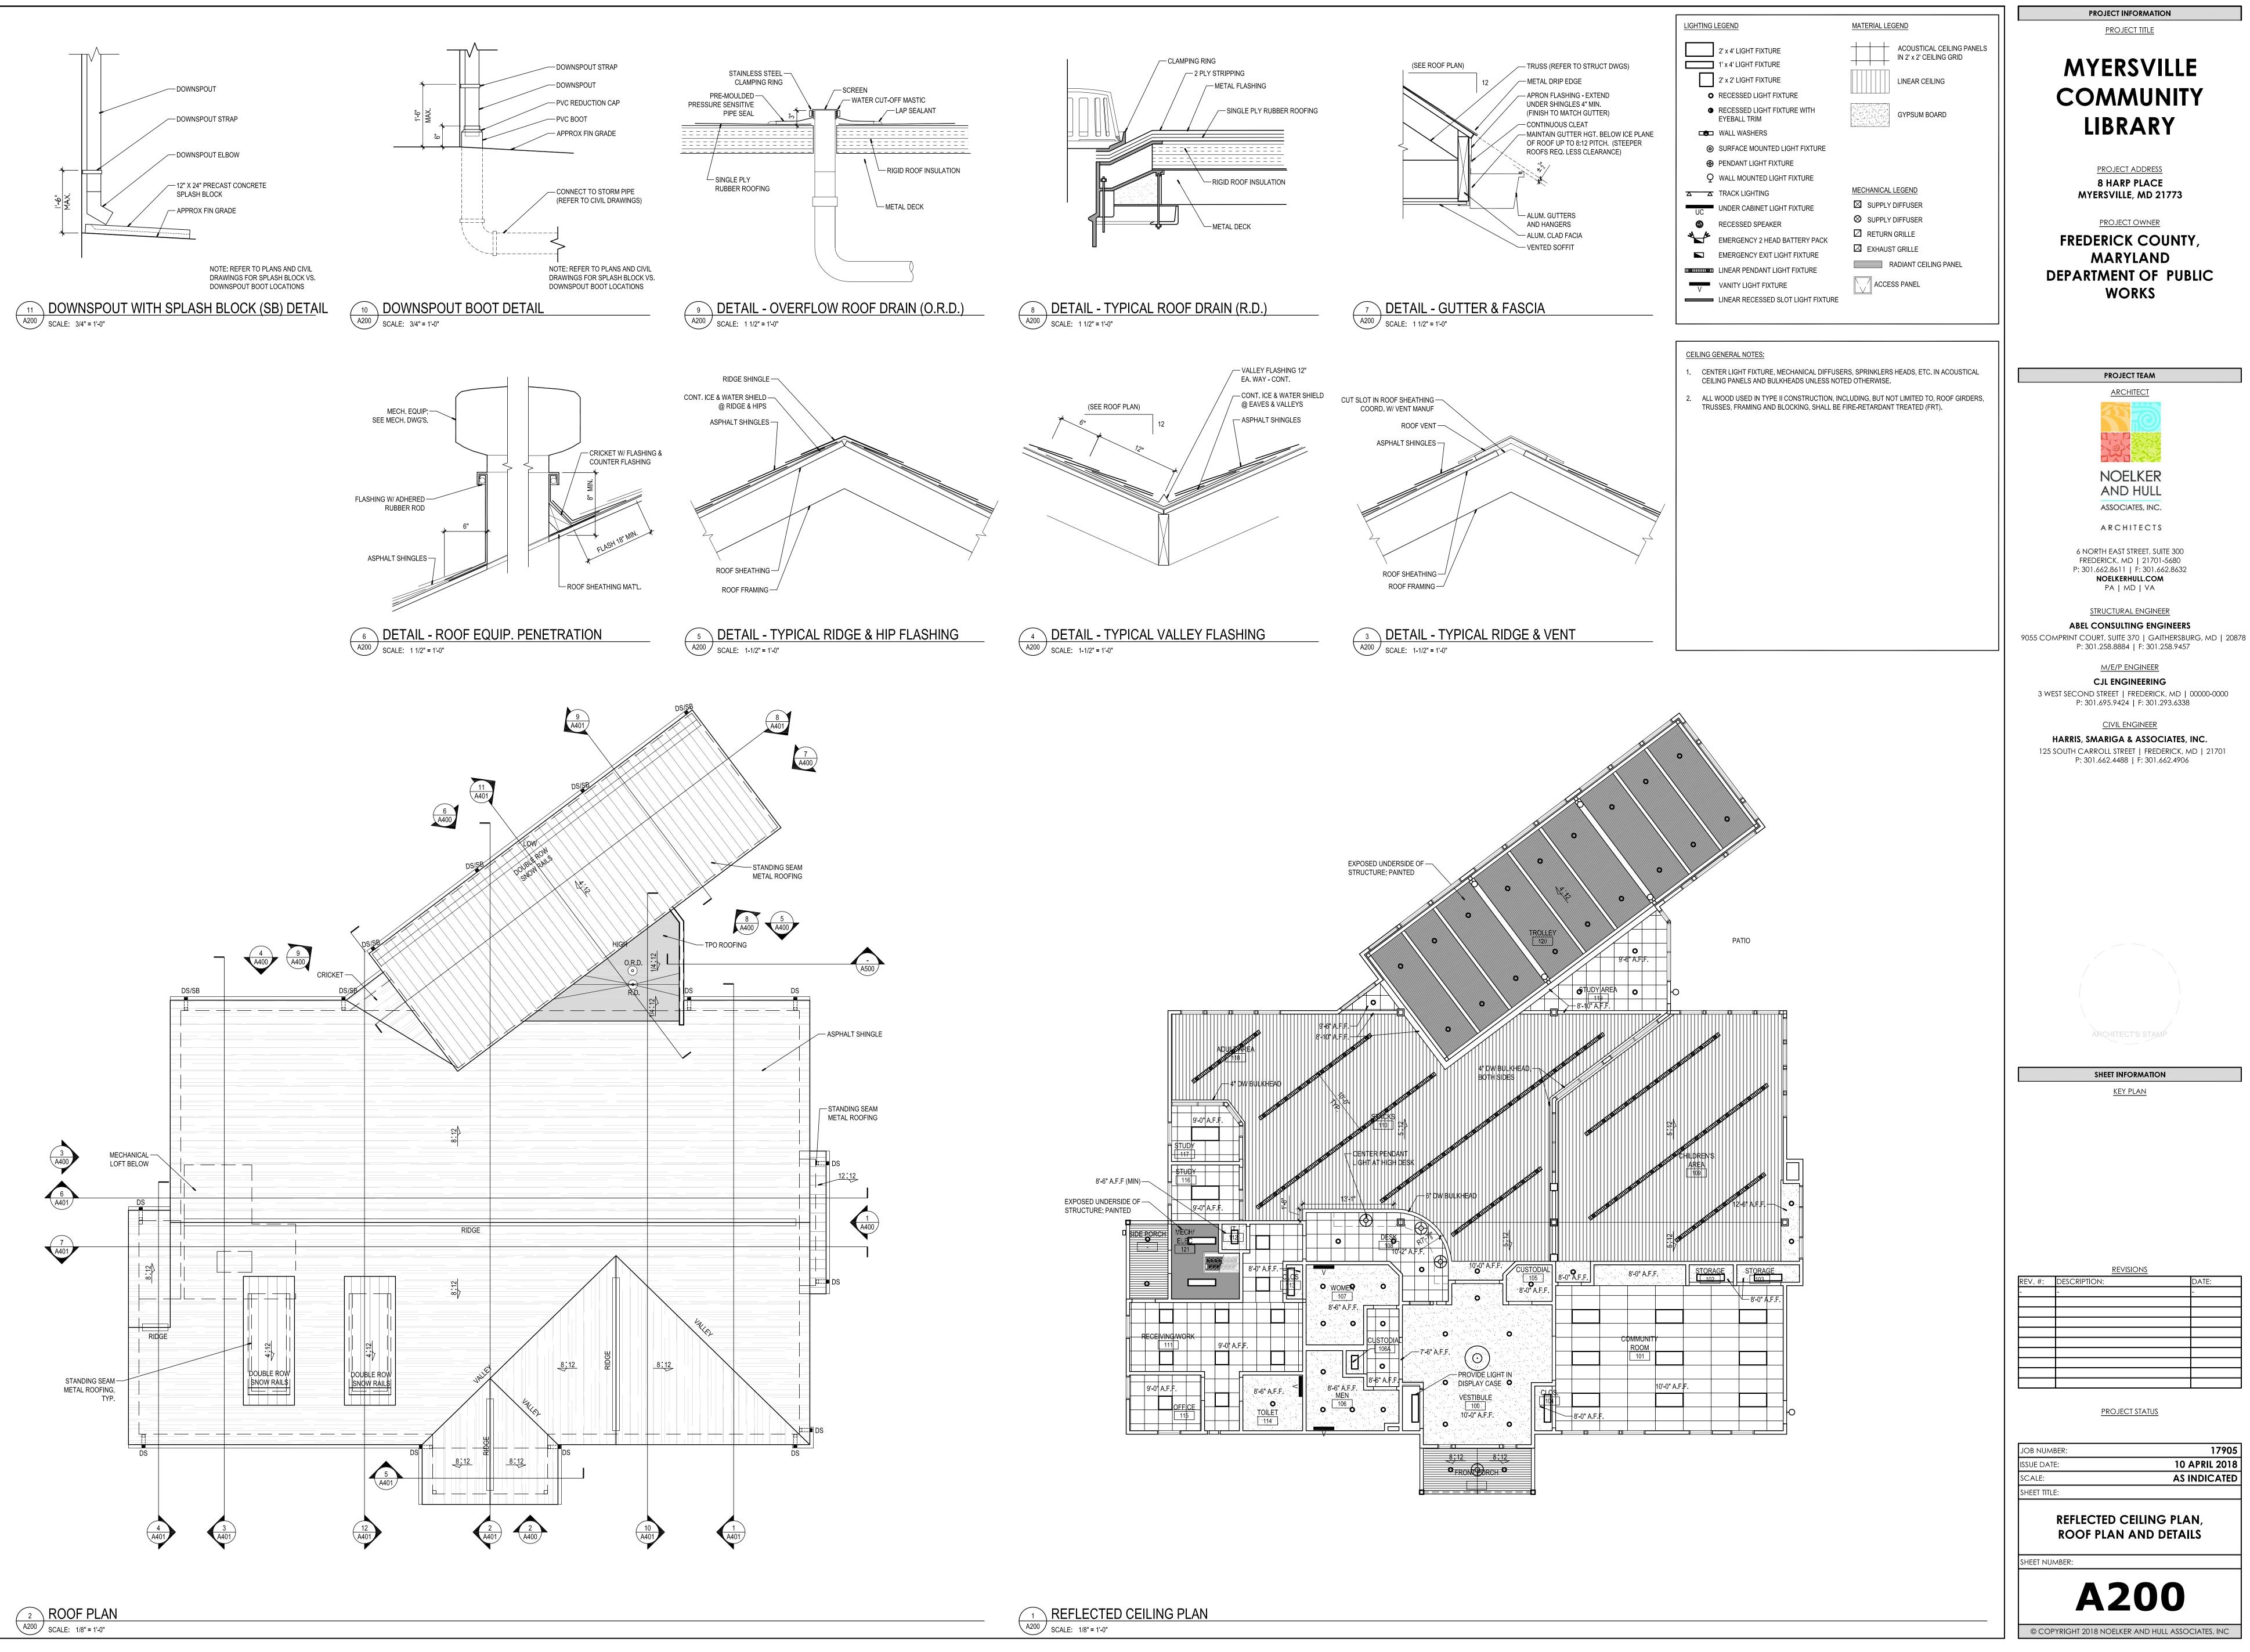
PROJECT STATUS

JOB NUMBER: 17905 10 APRIL 2018 AS INDICATED SHEET TITLE:

FLOOR PLANS

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SHEET NUMBER:



MYERSVILLE COMMUNITY **LIBRARY**

> PROJECT ADDRESS **8 HARP PLACE** MYERSVILLE, MD 21773

PROJECT OWNER FREDERICK COUNTY, **MARYLAND** DEPARTMENT OF PUBLIC **WORKS**


> PROJECT TEAM **NOELKER** AND HULL ASSOCIATES, INC.

ARCHITECTS 6 NORTH EAST STREET, SUITE 300 FREDERICK, MD | 21701-5680 P: 301.662.8611 | F: 301.662.8632 NOELKERHULL.COM

PA | MD | VA STRUCTURAL ENGINEER ABEL CONSULTING ENGINEERS

M/E/P ENGINEER CJL ENGINEERING

CIVIL ENGINEER HARRIS, SMARIGA & ASSOCIATES, INC. 125 SOUTH CARROLL STREET | FREDERICK, MD | 21701 P: 301.662.4488 | F: 301.662.4906

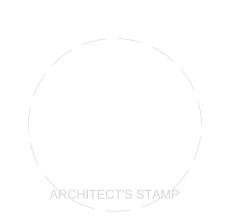


SHEET INFORMATION KEY PLAN

REV. #: DESCRIPTION:

PROJECT STATUS

17905 10 APRIL 2018 AS INDICATED REFLECTED CEILING PLAN, **ROOF PLAN AND DETAILS**

A200

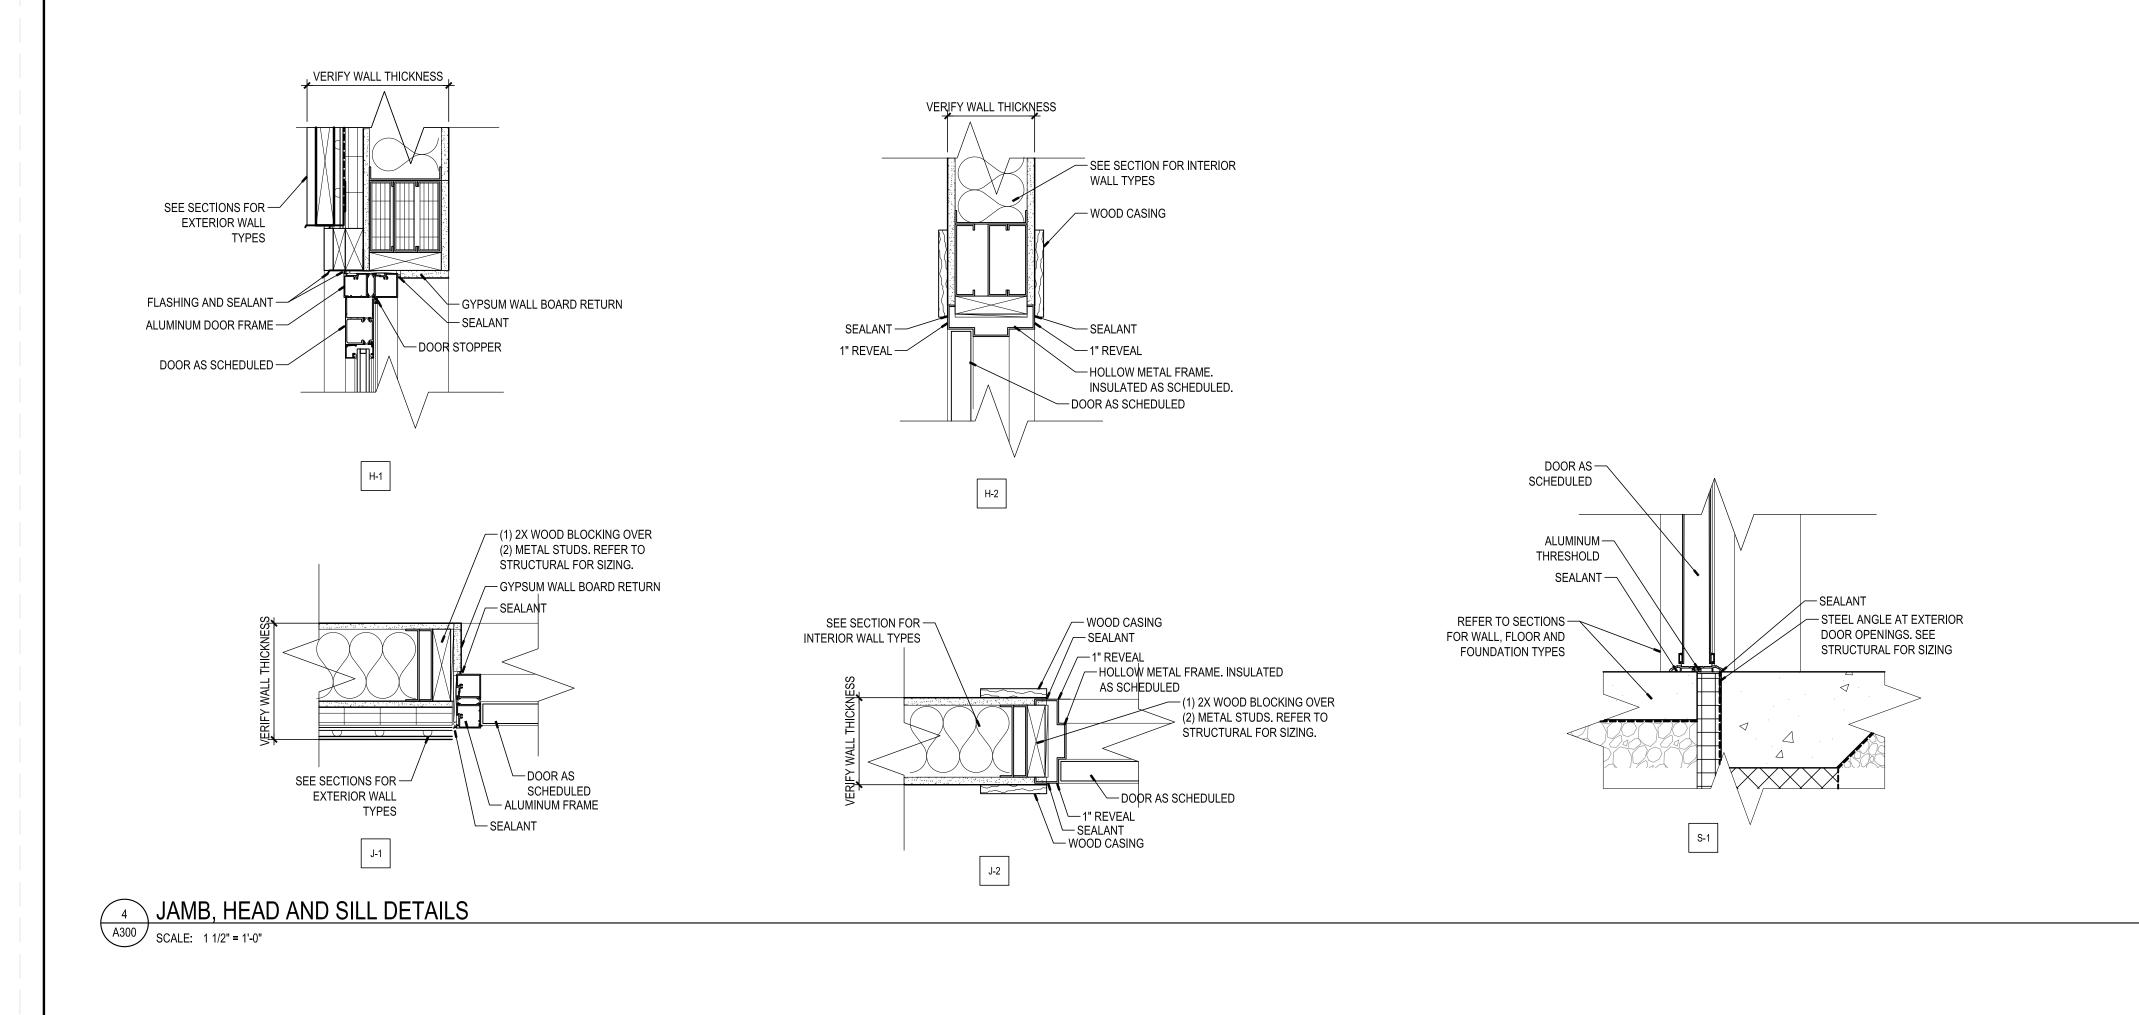

SCHEDULE

- HOLLOW METAL

FRAME SYSTEM

SCHEDULE

F-2

SCHEDULE

SCHEDULE

D 24 X 24 LOUVER

2 DOOR TYPES

A300 SCALE: 1/4" = 1'-0"

SCHEDULE

SEE SCHEDULE

F-4

- ALUMINUM

STOREFRONT SYSTEM

F-5

— HOLLOW METAL FRAME SYSTEM

— ALUMINUM STOREFRONT SYSTEM

3 FRAME TYPES

A300 SCALE: 1/4" = 1'-0"

HARDWARE SCHEDULE

- HW-1 2 EXIT DEVICES w/ REMOVABLE CENTER MULLION + STRIKES 2 EXTERIOR LEVER TRIM SETS, 1 WITH CYLINDER 2 CONTINUOUS GEARED HINGES 2 AUTOMATIC DOOR OPERATORS (ENTER/EXIT) WEATHERSTRIPPING/THRESHOLD
- HW-2 1 RIM EXIT DEVICE
 2 EXTERIOR LEVER TRIM SETS, 1 WITH CYLINDER
 1 CONTINUOUS GEARED HINGE
 1 CLOSER
 WEATHERSTRIPPING/THRESHOLD
- HW-3 1 ENTRANCE LEVER LOCKSET
 1 ELECTRIC STRIKE
 1 CONTINUOUS GEARED HINGE
 1 CLOSER
 WEATHERSTRIPPING/THRESHOLD
 CARD READER ROUGH-IN
 1 PEEPHOLE
- HW-4 1 ENTRANCE LEVER LOCKSET (SHELTER IN PLACE)
 1 CONTINUOUS GEARED HINGE
 1 CLOSER
 WEATHERSTRIPPING/THRESHOLD
- HW-5 2 EXIT DEVICES w/ REMOVABLE CENTER MULLION + STRIKES 2 ENTRANCE LEVER TRIM SETS, 1 WITH CYLINDER 6 HINGES 2 AUTOMATIC DOOR OPERATORS (ENTER/EXIT)
- HW-5A 2 EXIT DEVICES w/ REMOVABLE CENTER MULLION + STRIKES 2 ENTRANCE LEVER TRIM SETS, 1 WITH CYLINDER 6 HINGES 2 CLOSERS W/ HOLD-OPENS
- HW-6 1 ENTRANCE LEVER LOCKSET (SHELTER IN PLACE), ACTIVE LEAF 6 HINGES 1 SET CONCEALED FLUSHBOLTS AND STRIKES, INACTIVE LEAF
- HW-7 1 ENTRANCE LEVER LOCKSET (SHELTER IN PLACE) 3 HINGES HW-8 1 PUSH/PULL SET
- HW-8 1 PUSH/PULL SET 3 HINGES 1 CLOSER
- 1 AUXILIARY DEADLOCK

 HW-9 1 PRIVACY LEVER LOCKSET
 3 HINGES
- 3 HINGES
 1 CLOSER
 HW-10 1 ENTRANCE LEVER LOCKSET (SHELTER IN PLACE)
- 3 HINGES

 HW-11 1 PASSAGE LEVER LATCHSET
 3 HINGES

G	GLAZING TYPE KEY								
TAG NO.	TAG NO. DESCRIPTION								
(G-1)	INSULATED GLASS - TEMPERED								
G-2	INSULATED GLASS - ANNEALED								
G -3	CLEAR TEMPERED GLASS								
G-4	CLEAR ANNEALED GLASS								
G-5)	FIRE GLASS								
G-6)	DECORATIVE LAMINATED ACRYLIC								

						DOOR	SC	HEDL	JLE			
			DOOR DA	ATA				FI	RAME DA	TA		DEMARKO
MARK	TYPE	SIZE	MAT'L	GLAZING	RATING	HARDWARE	TYPE	MAT'L	HEAD	JAMB	SILL	REMARKS
100	С	(2) 3'-0" x 7'-0"	ALUM	G-1	-	SET#1	F-1	ALUM	-	-	-	
101A	В	(2) 3'-0" x 7'-0"	WD	G-3	-	SET # 5A	F-1	НМ	-	-	-	
101B	А	3'-0" x 7'-0"	IHM	-	-	SET # 2	F-1	IHM	-	-	-	
101C	В	3'-0" x 7'-0"	WD	G-3	-	SET#7	F-1	НМ	-	-	-	
102	А	(2) 3'-0" x 7'-0"	WD	-	-	SET#6	F-1	НМ	-	-	-	
103	А	(2) 3'-0" x 7'-0"	WD	-	-	SET#6	F-1	НМ	-	-	-	
104	А	(2) 2'-10" x 7'-0"	WD	-	-	SET#6	F-1	НМ	-	-	-	
105	А	3'-0" x 7'-0"	WD	-	-	SET#7	F-1	НМ	-	-	-	
106	А	3'-0" x 7'-0"	WD	-	-	SET#8	F-1	НМ	-	-	-	
106A	А	3'-0" x 7'-0"	WD	-	-	SET#8	F-1	НМ	-	-	-	
107	Α	3'-0" x 7'-0"	WD	-	-	SET#8	F-1	НМ	-	-	-	
110	С	(2) 3'-0" x 7'-0"	WD	G-3	-	SET # 5	F-2	НМ	-	-	-	
111A	В	3'-0" x 7'-0"	WD	G-3	-	SET#7	F-1	НМ	-	-	-	
111B	Α	3'-0" x 7'-0"	IHM	-	-	SET # 3	F-1	IHM	-	-	-	PROVIDE ELECTRIC STRIKE FOR CARD READER
112	D	3'-0" x 7'-0"	НМ	-	-	SET#7	F-1	НМ	-	-	-	
113	Α	3'-0" x 7'-0"	WD	-	-	SET#7	F-1	НМ	-	-	-	
114	Α	3'-0" x 7'-0"	WD	-	-	SET # 9	F-1	НМ	-	-	-	
115	В	3'-0" x 7'-0"	WD	G-3	-	SET # 10	F-1	НМ	-	-	-	
116	С	3'-0" x 7'-0"	WD	G-3	-	SET # 11	F-3	НМ	-	-	-	
117	С	3'-0" x 7'-0"	WD	G-3	-	SET # 11	F-4	НМ	-	-	-	
119	С	3'-0" x 7'-0"	ALUM	G-1	-	SET#2	F-5	ALUM	-	-	-	
120	С	3'-0" x 7'-0"	ALUM	G-1	-	SET#2	F-6	ALUM	-	-	-	
121	Α	3'-0" x 7'-0"	IHM	-	-	SET#4	F-1	IHM	-	-	-	

		-		
	ABBR	EVIATIO	DNS	NOTES
ACW	ALUMINUM CLAD WOOD	НМ	HOLLOW METAL	1. DOOR STAIN FINISH TO BE DETERMINED
ALUM	ALUMINUM	IHM	INSULATED HOLLOW METAL	2.
		MWF	MOLDED WOOD FIBER	
		WD	WOOD	

DOOR SCHEDULE

SCALE: NONE

А

В

PROJECT INFORMATION

PROJECT TITLE

MYERSVILLE COMMUNITY LIBRARY

PROJECT ADDRESS

8 HARP PLACE
MYERSVILLE, MD 21773

FREDERICK COUNTY,
MARYLAND
DEPARTMENT OF PUBLIC
WORKS

PROJECT TEAM

ARCHITECT

NOELKER AND HULL ASSOCIATES, INC.

ARCHITECTS

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STRUCTURAL ENGINEER

ABEL CONSULTING ENGINEERS

9055 COMPRINT COURT, SUITE 370 | GAITHERSBURG, MD | 20878

M/E/P ENGINEER

CJL ENGINEERING

3 WEST SECOND STREET | FREDERICK, MD | 00000-0000

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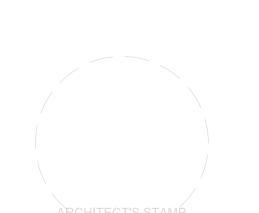
P: 301.662.4488 | F: 301.662.4906

P: 301.258.8884 | F: 301.258.9457

CIVIL ENGINEER

HARRIS, SMARIGA & ASSOCIATES, INC.

125 SOUTH CARROLL STREET | FREDERICK, MD | 21701



SHEET INFORMATION

KEY PLAN


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/. #:	DESCRIPTION:	DATE:
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PROJECT STATUS

İ	JOB NUMBER:	1790
	ISSUE DATE:	10 APRIL 201
	SCALE:	AS INDICATE
	SHEET TITLE:	

DOOR SCHEDULE

A300

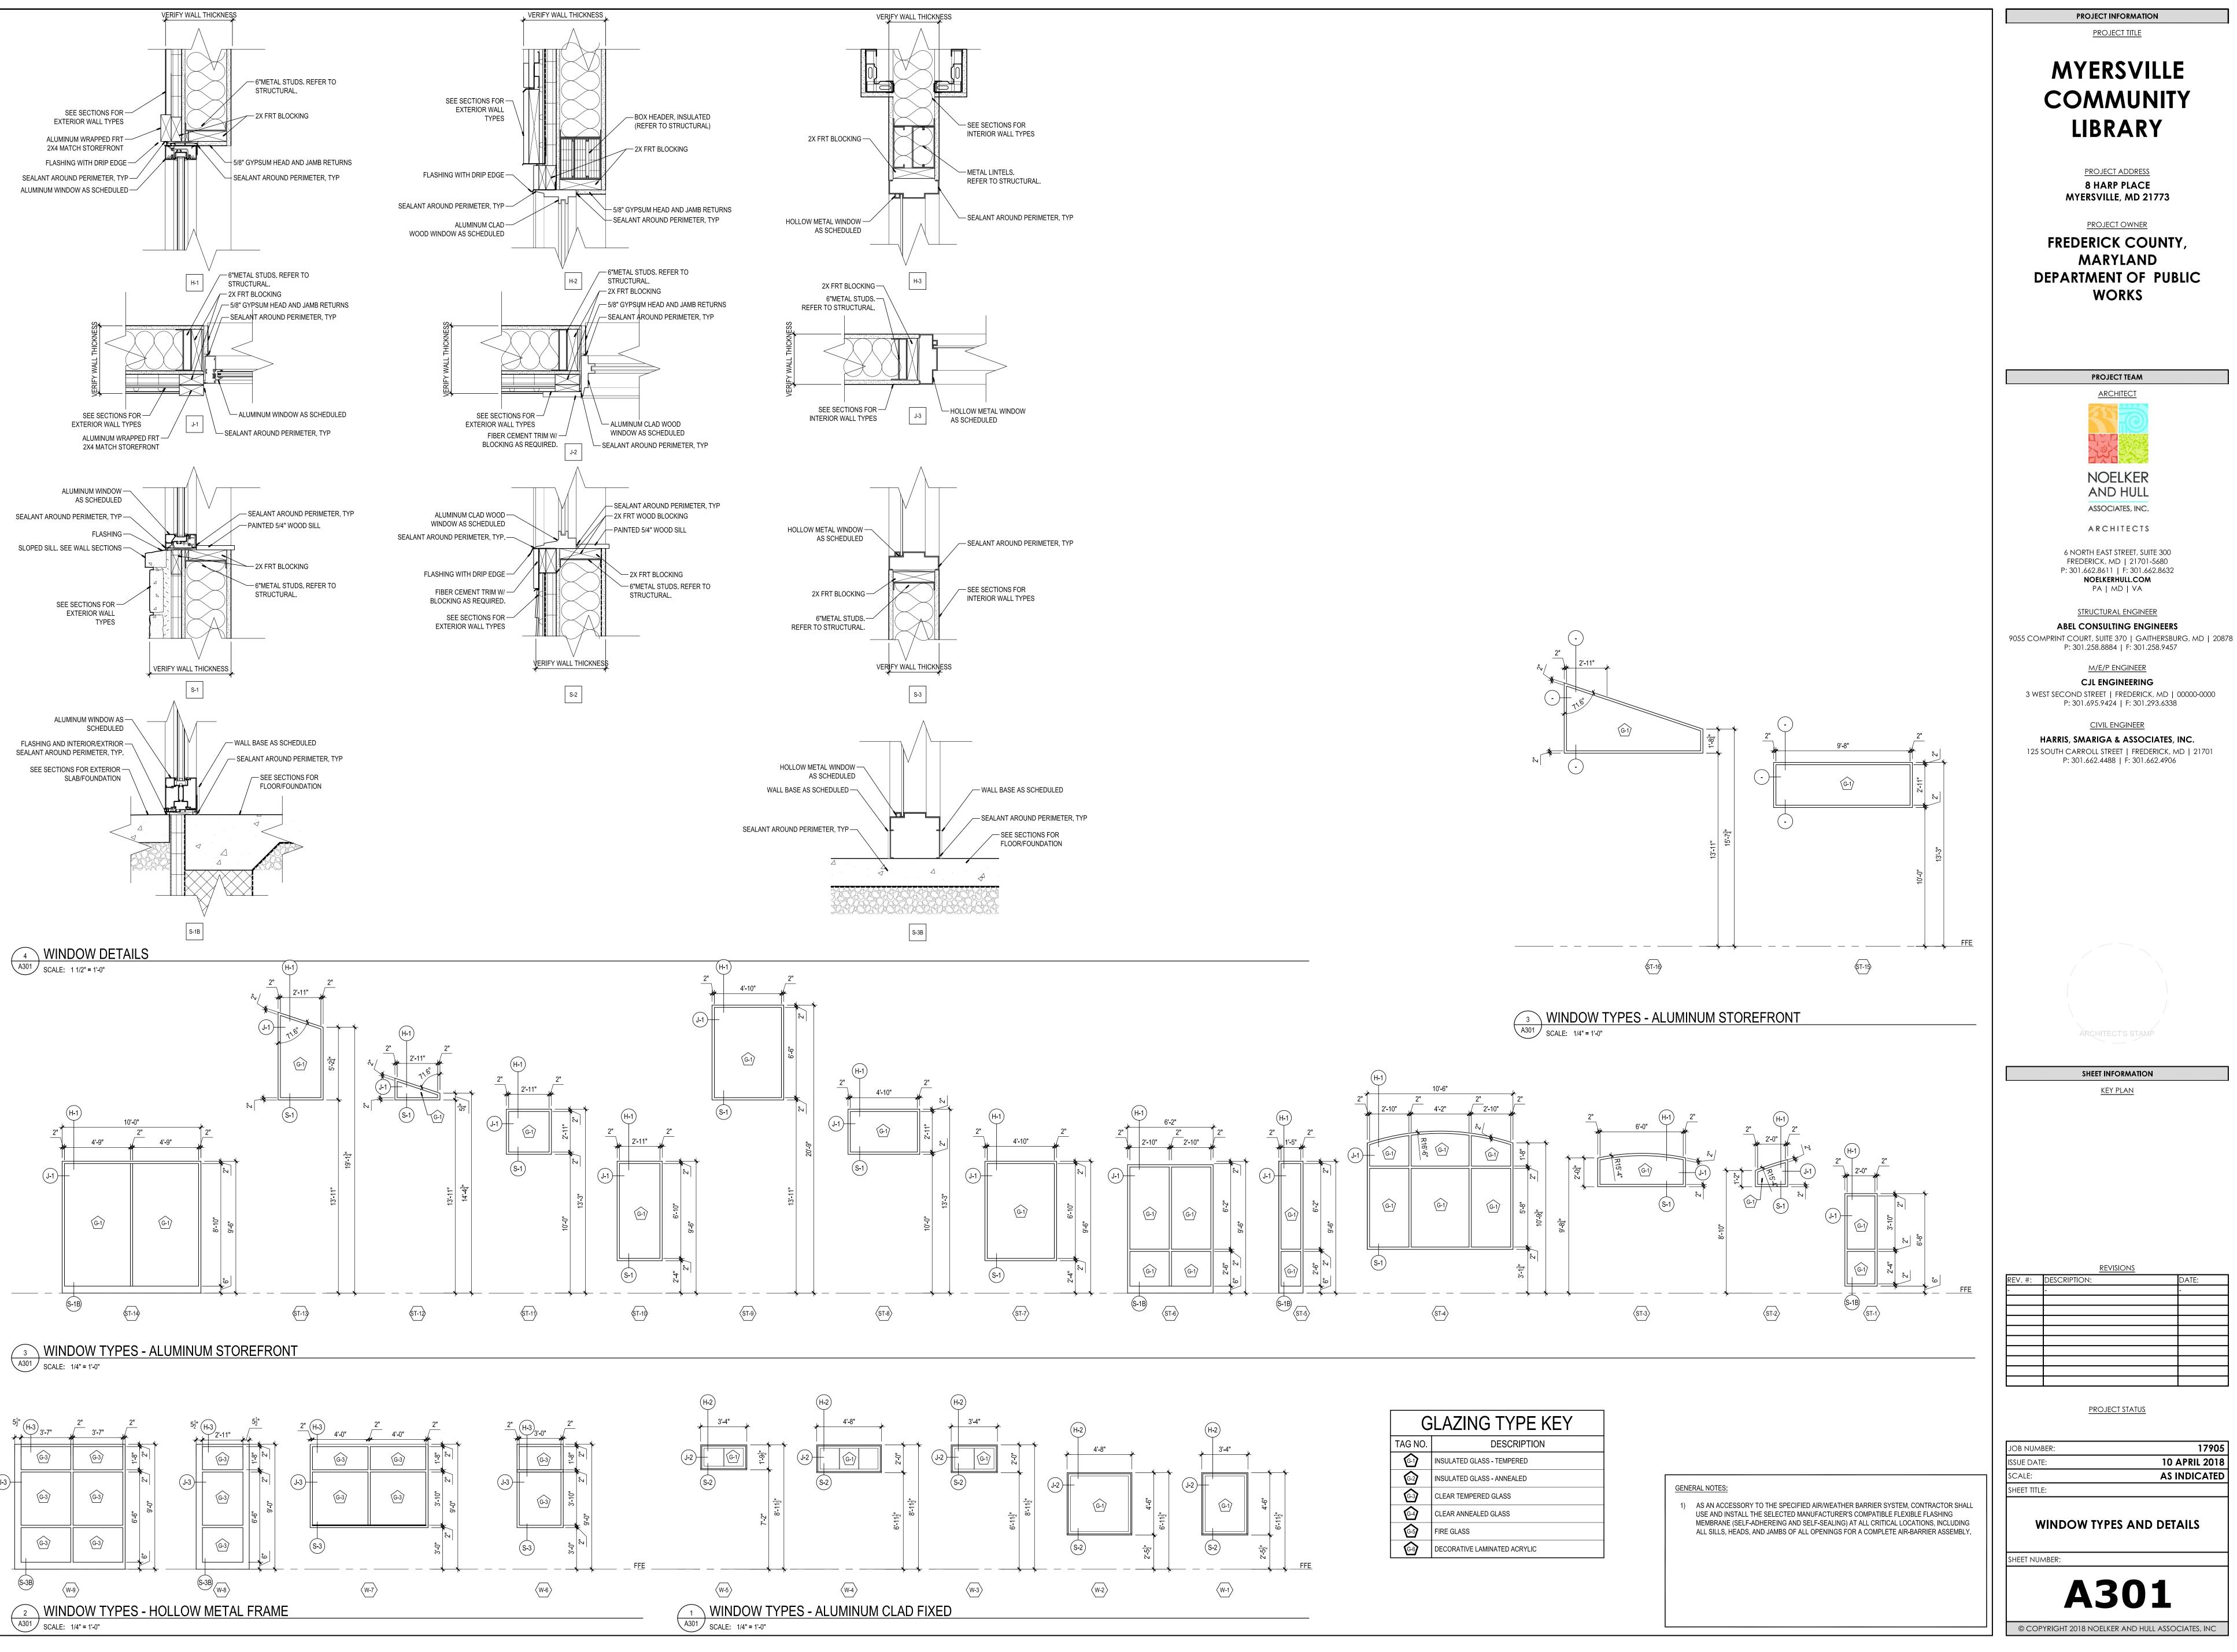

MYERSVILLE COMMUNITY **LIBRARY**

PROJECT ADDRESS **8 HARP PLACE** MYERSVILLE, MD 21773

PROJECT OWNER FREDERICK COUNTY, **MARYLAND** DEPARTMENT OF PUBLIC

WORKS

PROJECT TEAM

NOELKER

AND HULL ASSOCIATES, INC.

ARCHITECTS


6 NORTH EAST STREET, SUITE 300 FREDERICK, MD | 21701-5680 P: 301.662.8611 | F: 301.662.8632

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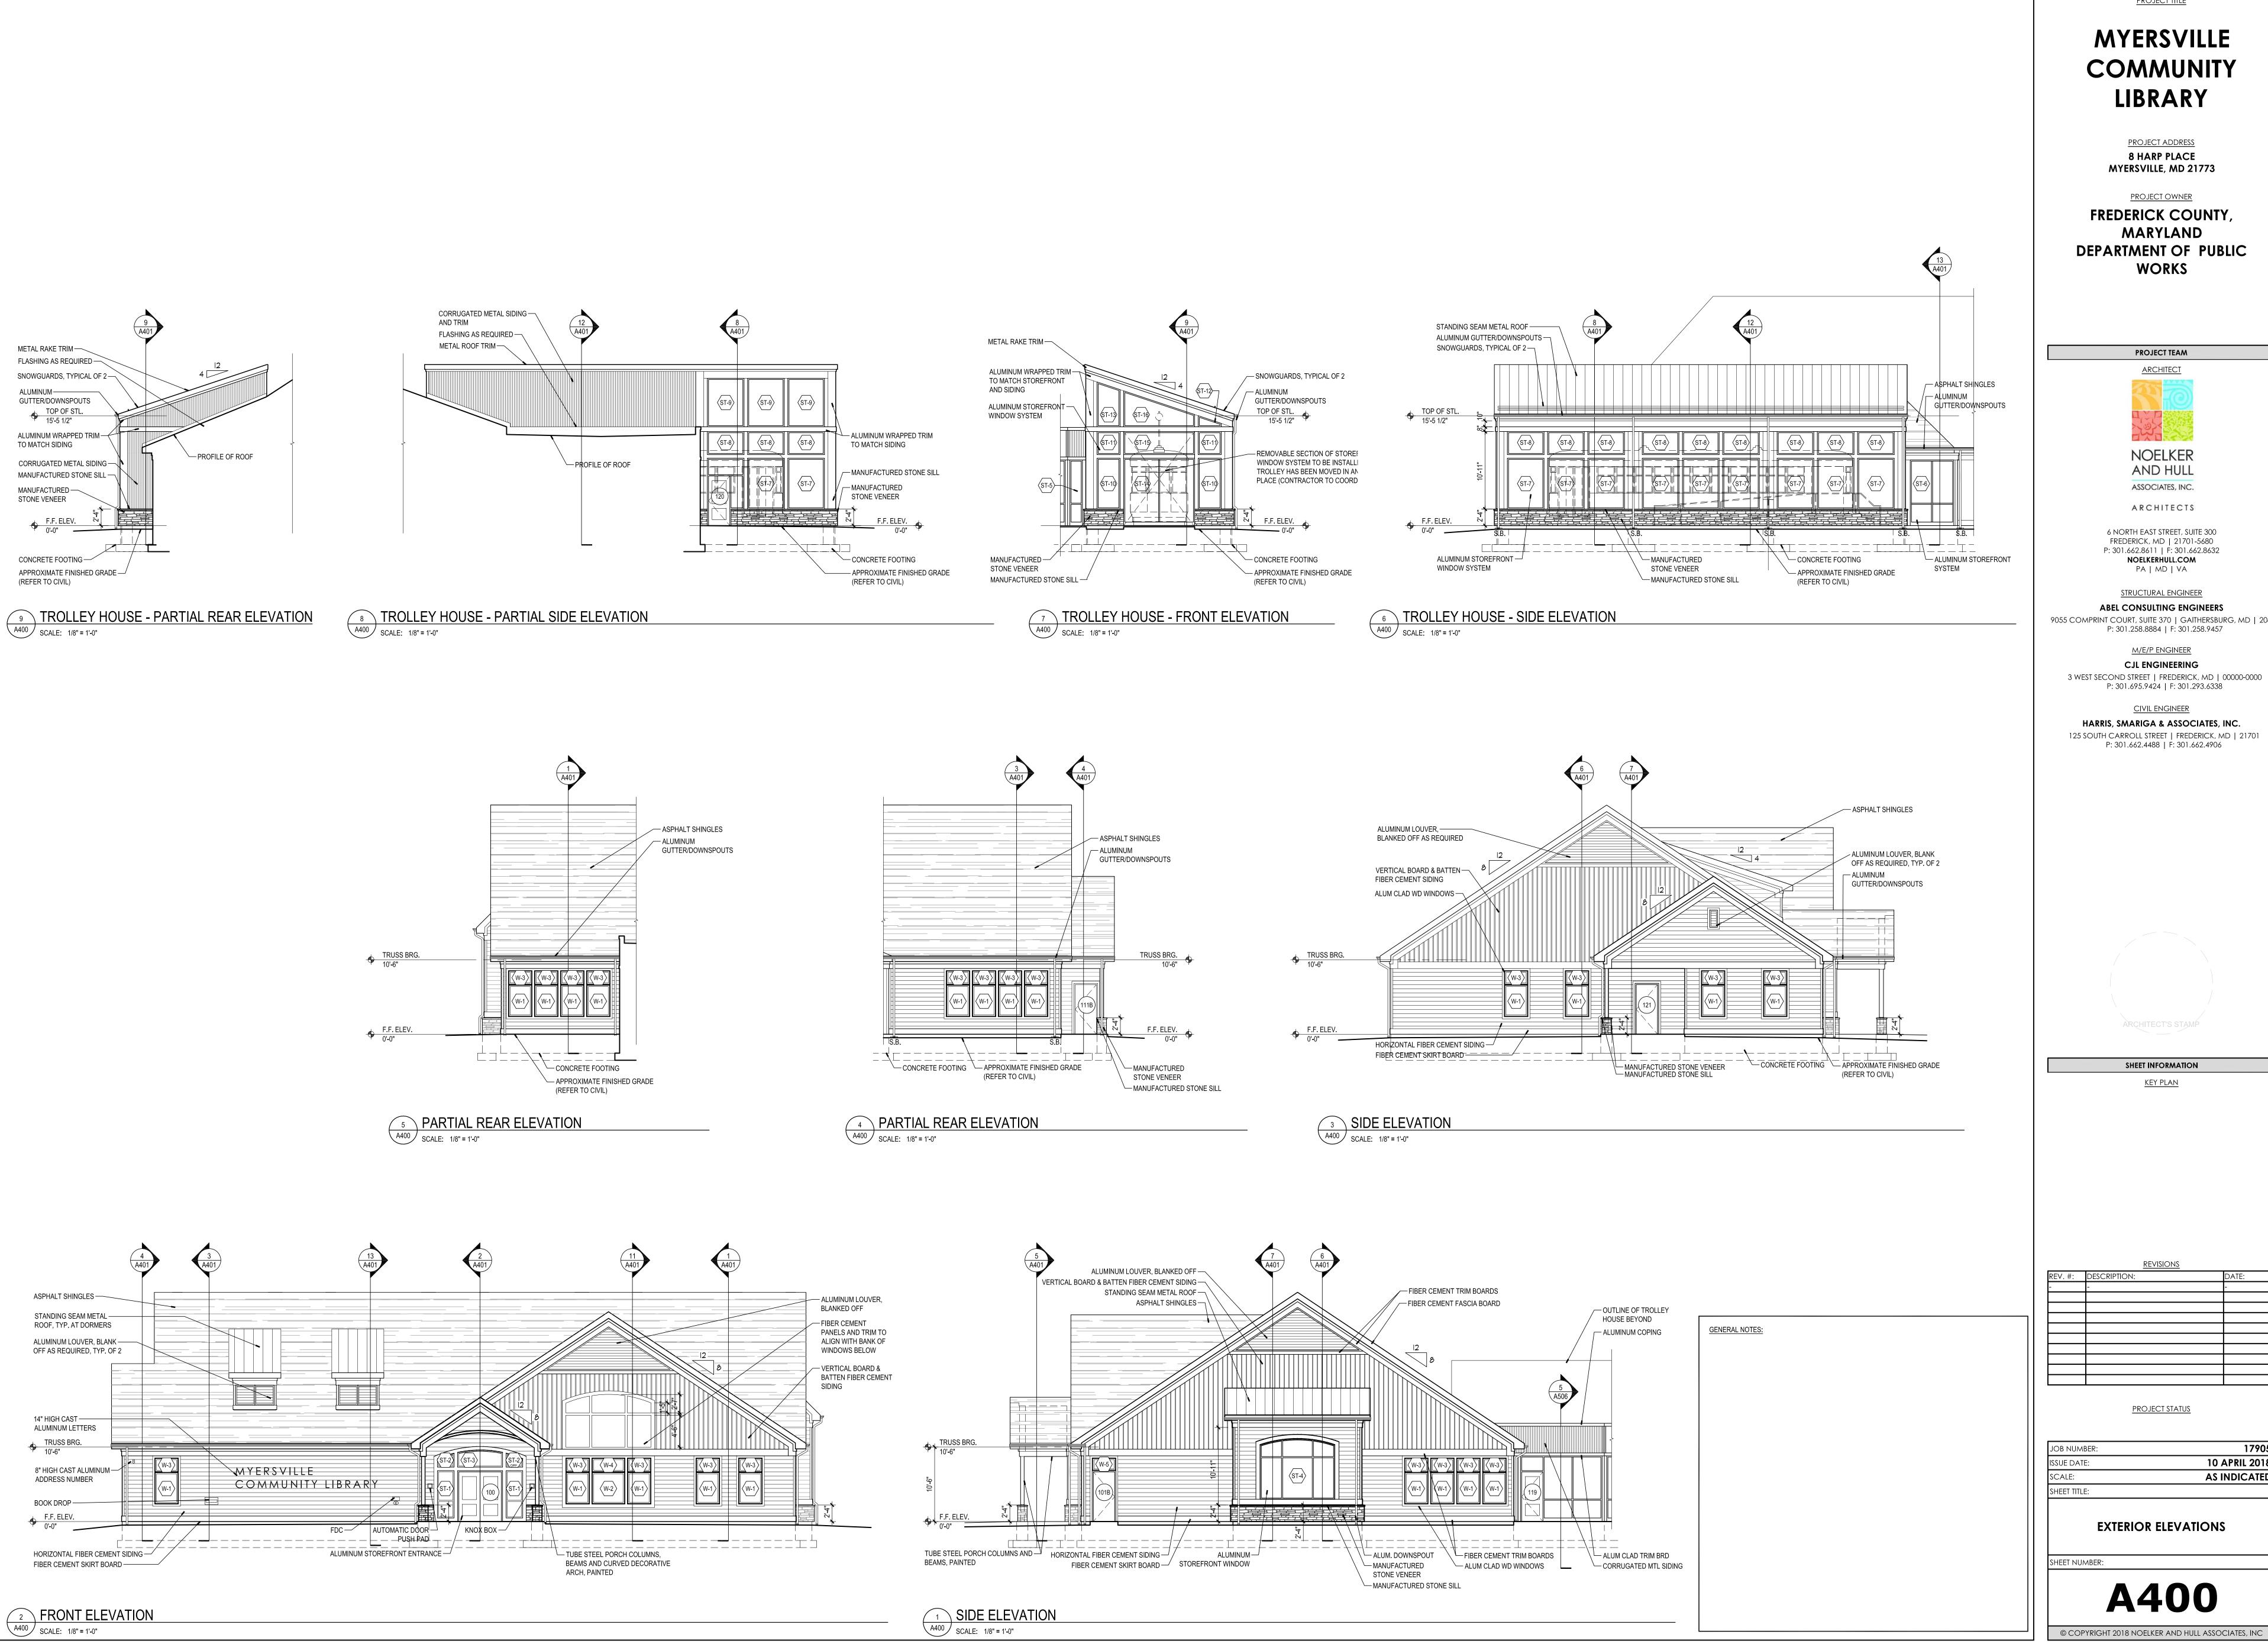


SHEET INFORMATION

<u>KEY PLAN</u>

PROJECT STATUS

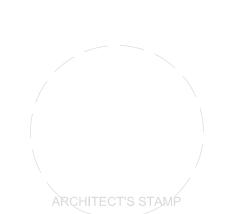17905 10 APRIL 2018 AS INDICATED WINDOW TYPES AND DETAILS



MYERSVILLE COMMUNITY LIBRARY

> PROJECT ADDRESS **8 HARP PLACE** MYERSVILLE, MD 21773

PROJECT OWNER FREDERICK COUNTY, **MARYLAND** DEPARTMENT OF PUBLIC **WORKS**

> PROJECT TEAM **NOELKER** AND HULL


ASSOCIATES, INC. ARCHITECTS

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SHEET INFORMATION KEY PLAN


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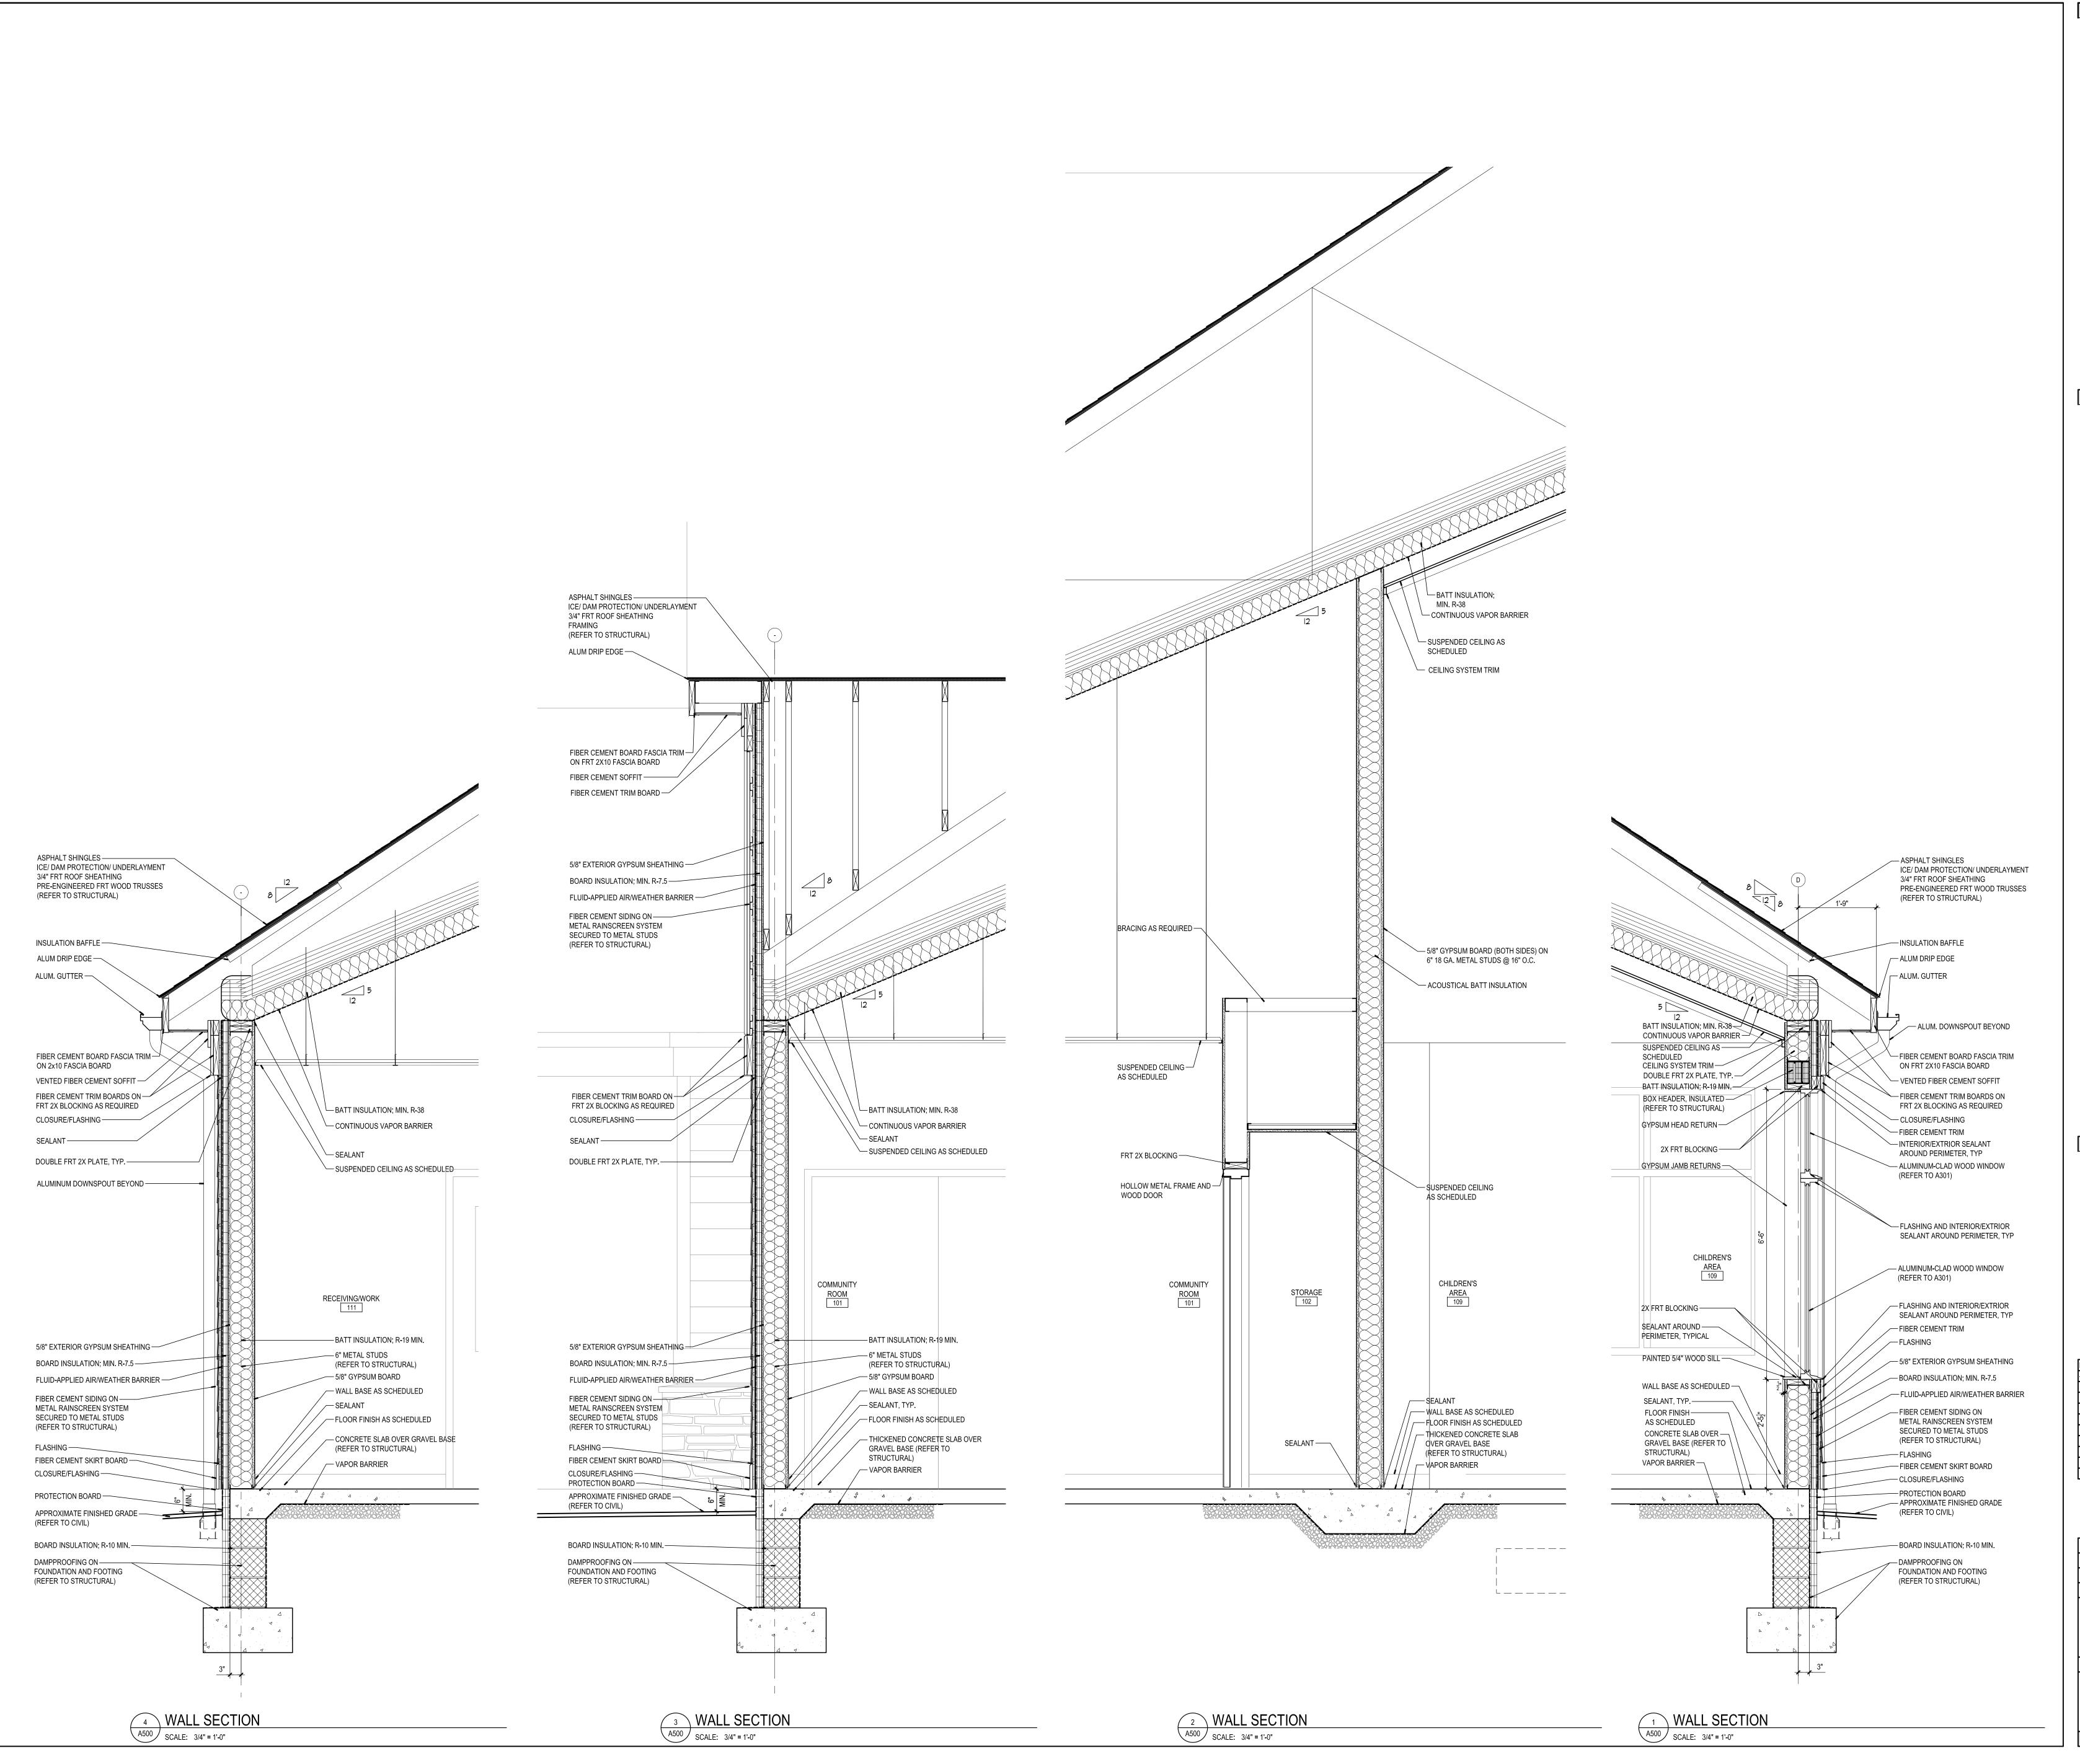
PROJECT STATUS

AS INDICATED **EXTERIOR ELEVATIONS**

17905

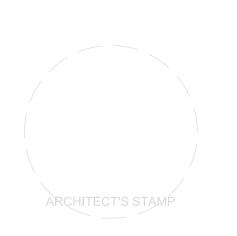10 APRIL 2018



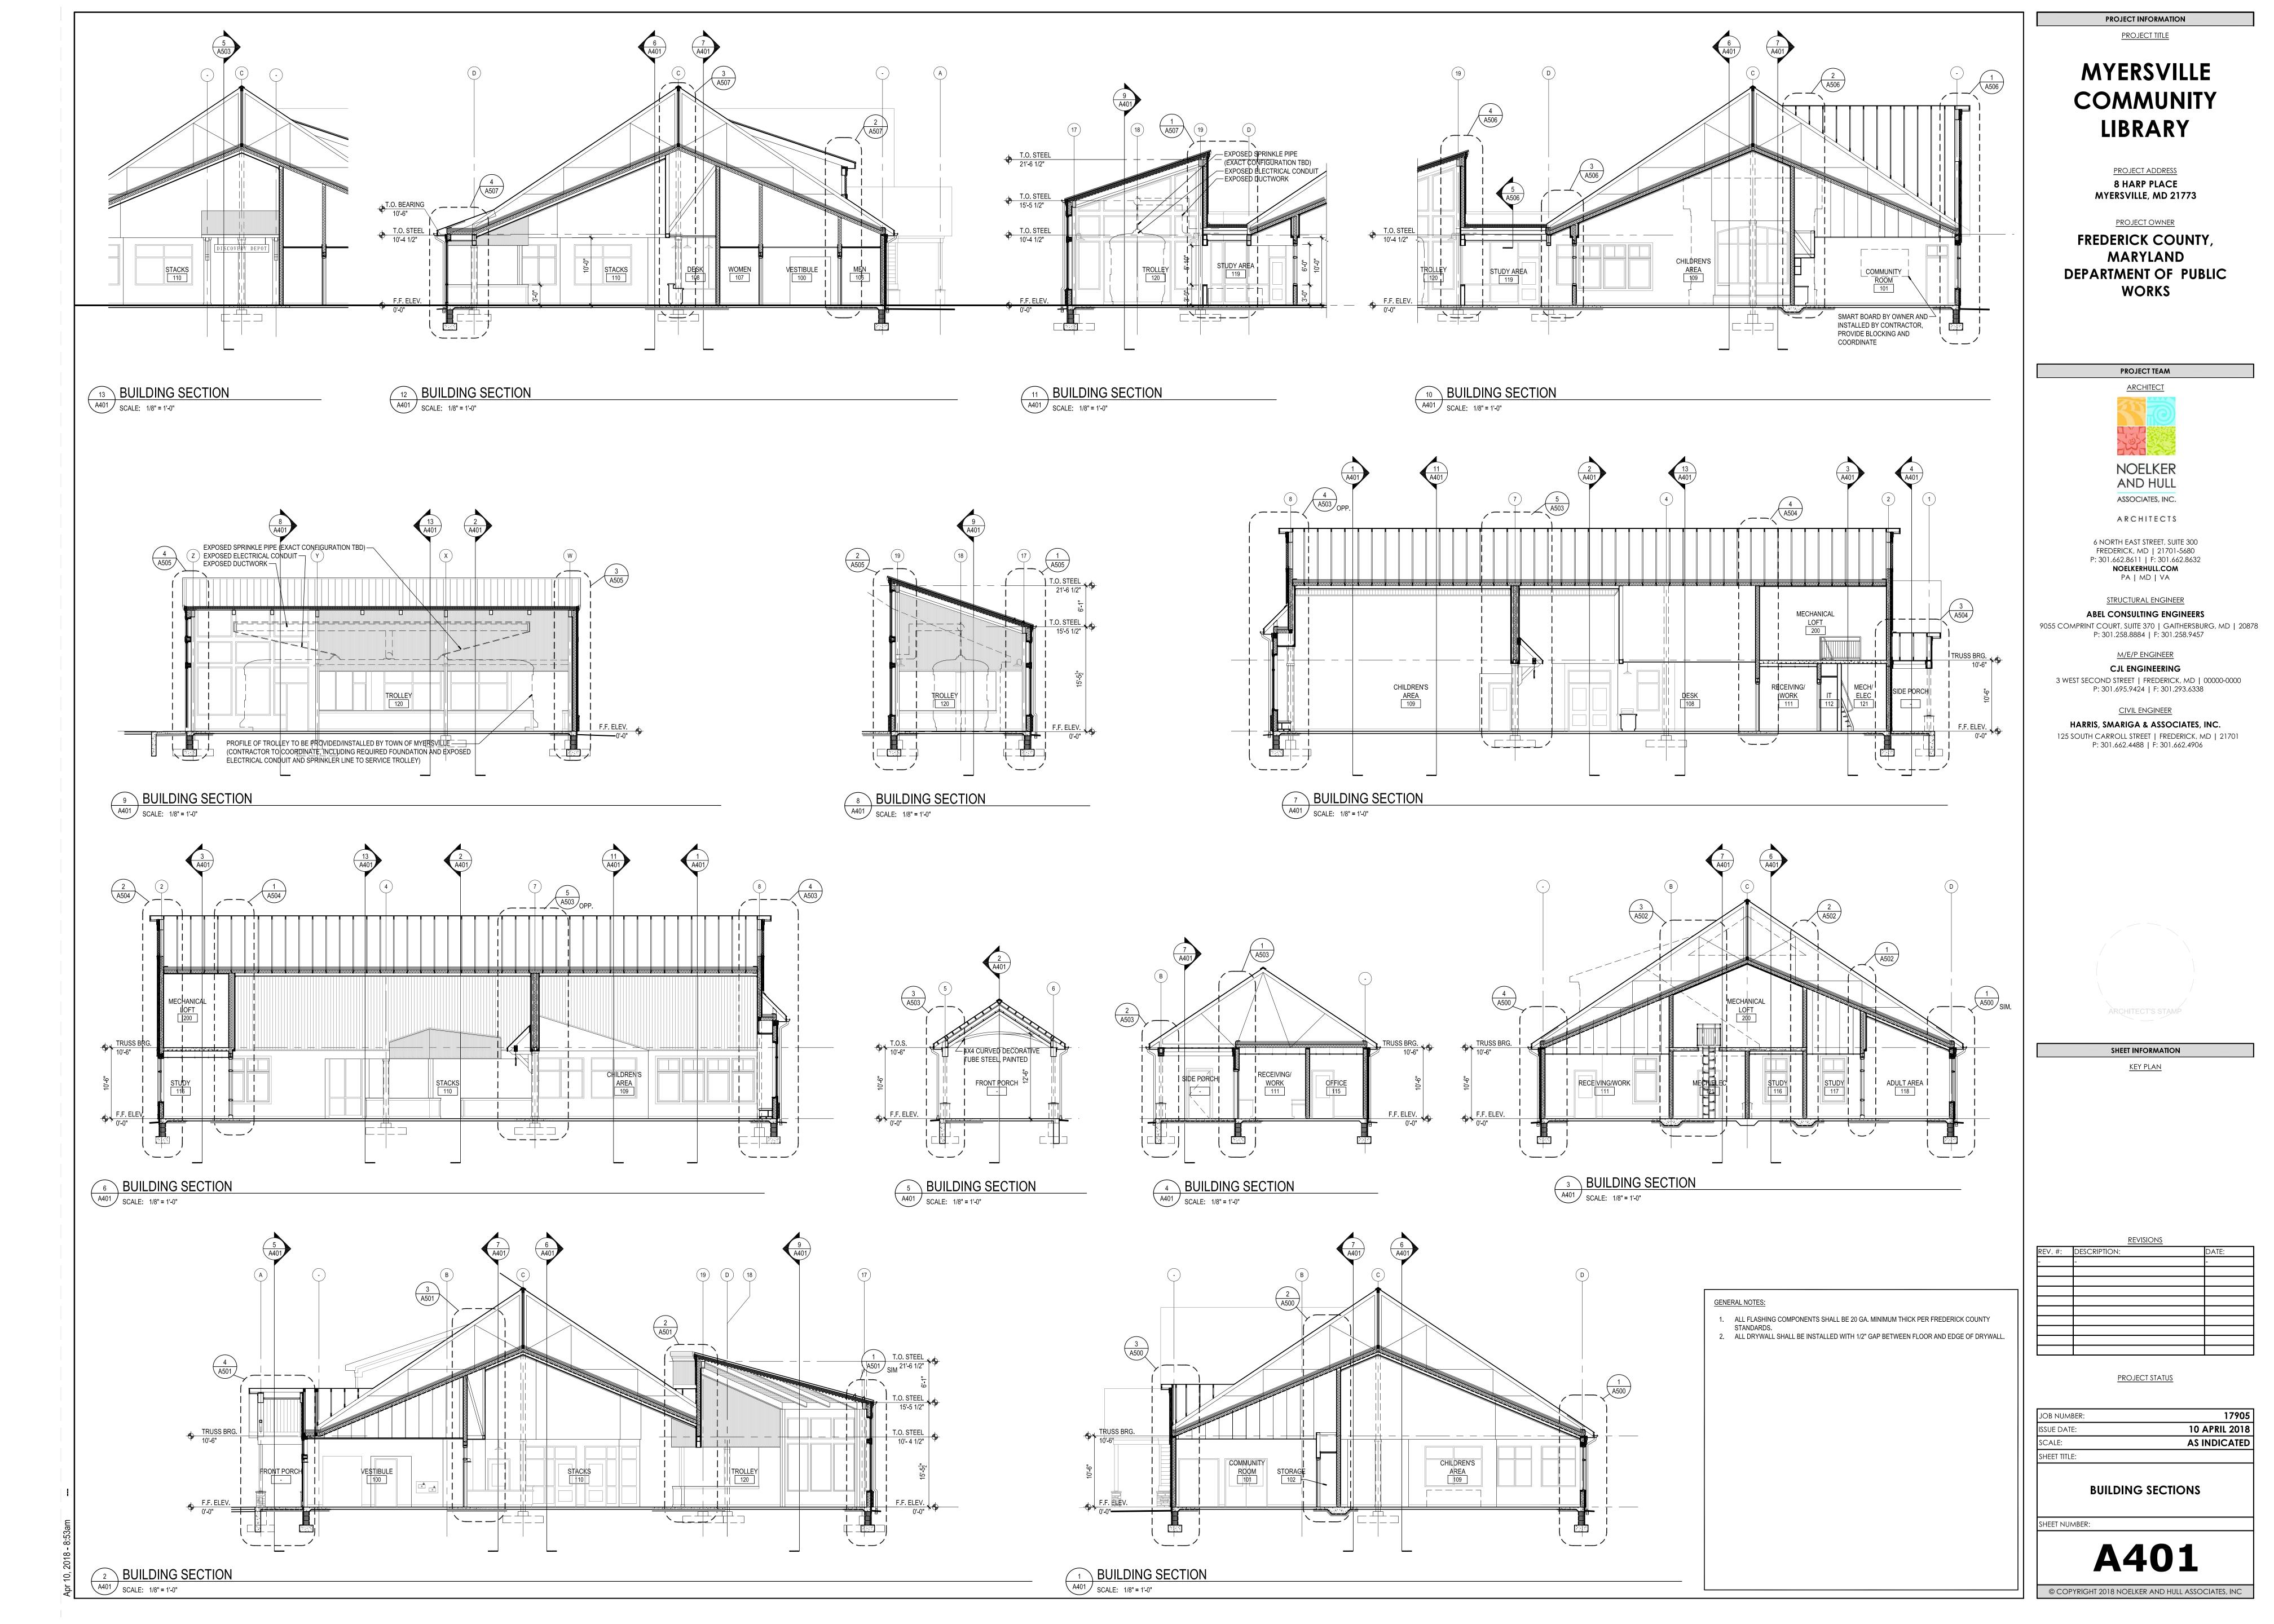

PROJECT INFORMATION PROJECT TITLE

MYERSVILLE COMMUNITY LIBRARY

PROJECT ADDRESS **8 HARP PLACE** MYERSVILLE, MD 21773

PROJECT OWNER FREDERICK COUNTY, **MARYLAND** DEPARTMENT OF PUBLIC **WORKS**

PROJECT TEAM

NOELKER AND HULL ASSOCIATES, INC.

ARCHITECTS


6 NORTH EAST STREET, SUITE 300 FREDERICK, MD | 21701-5680 P: 301.662.8611 | F: 301.662.8632 NOELKERHULL.COM PA | MD | VA

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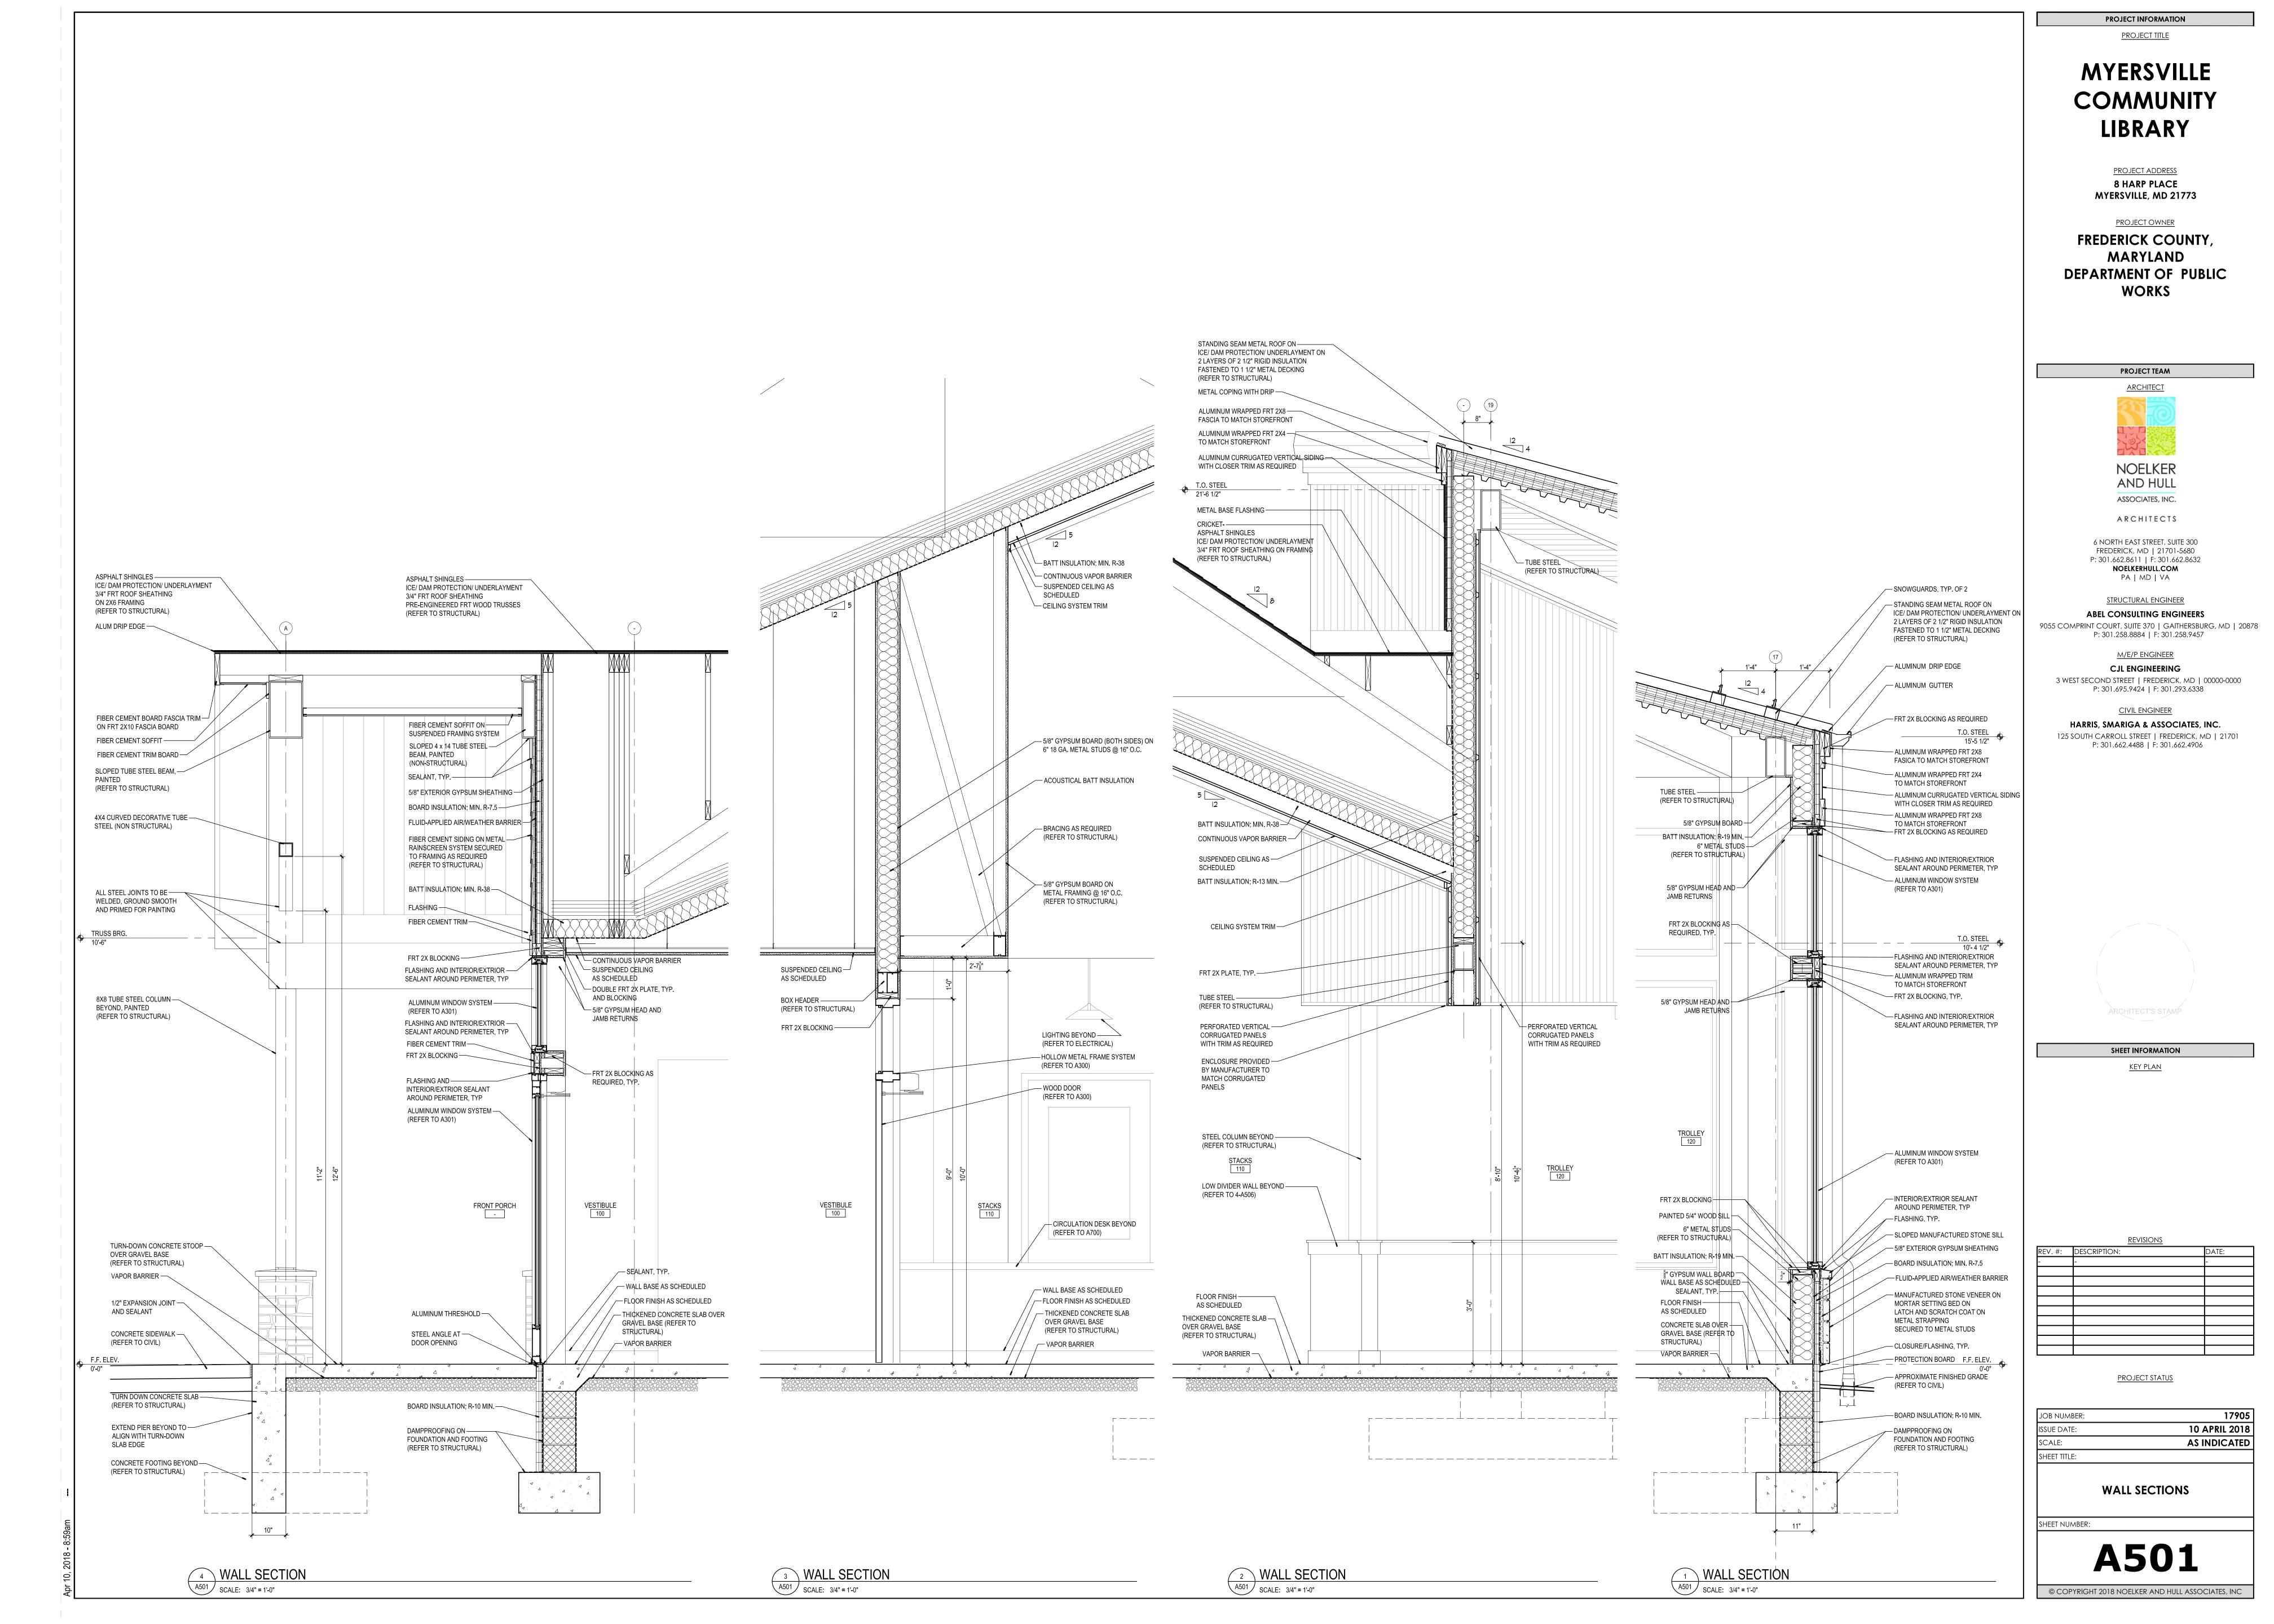
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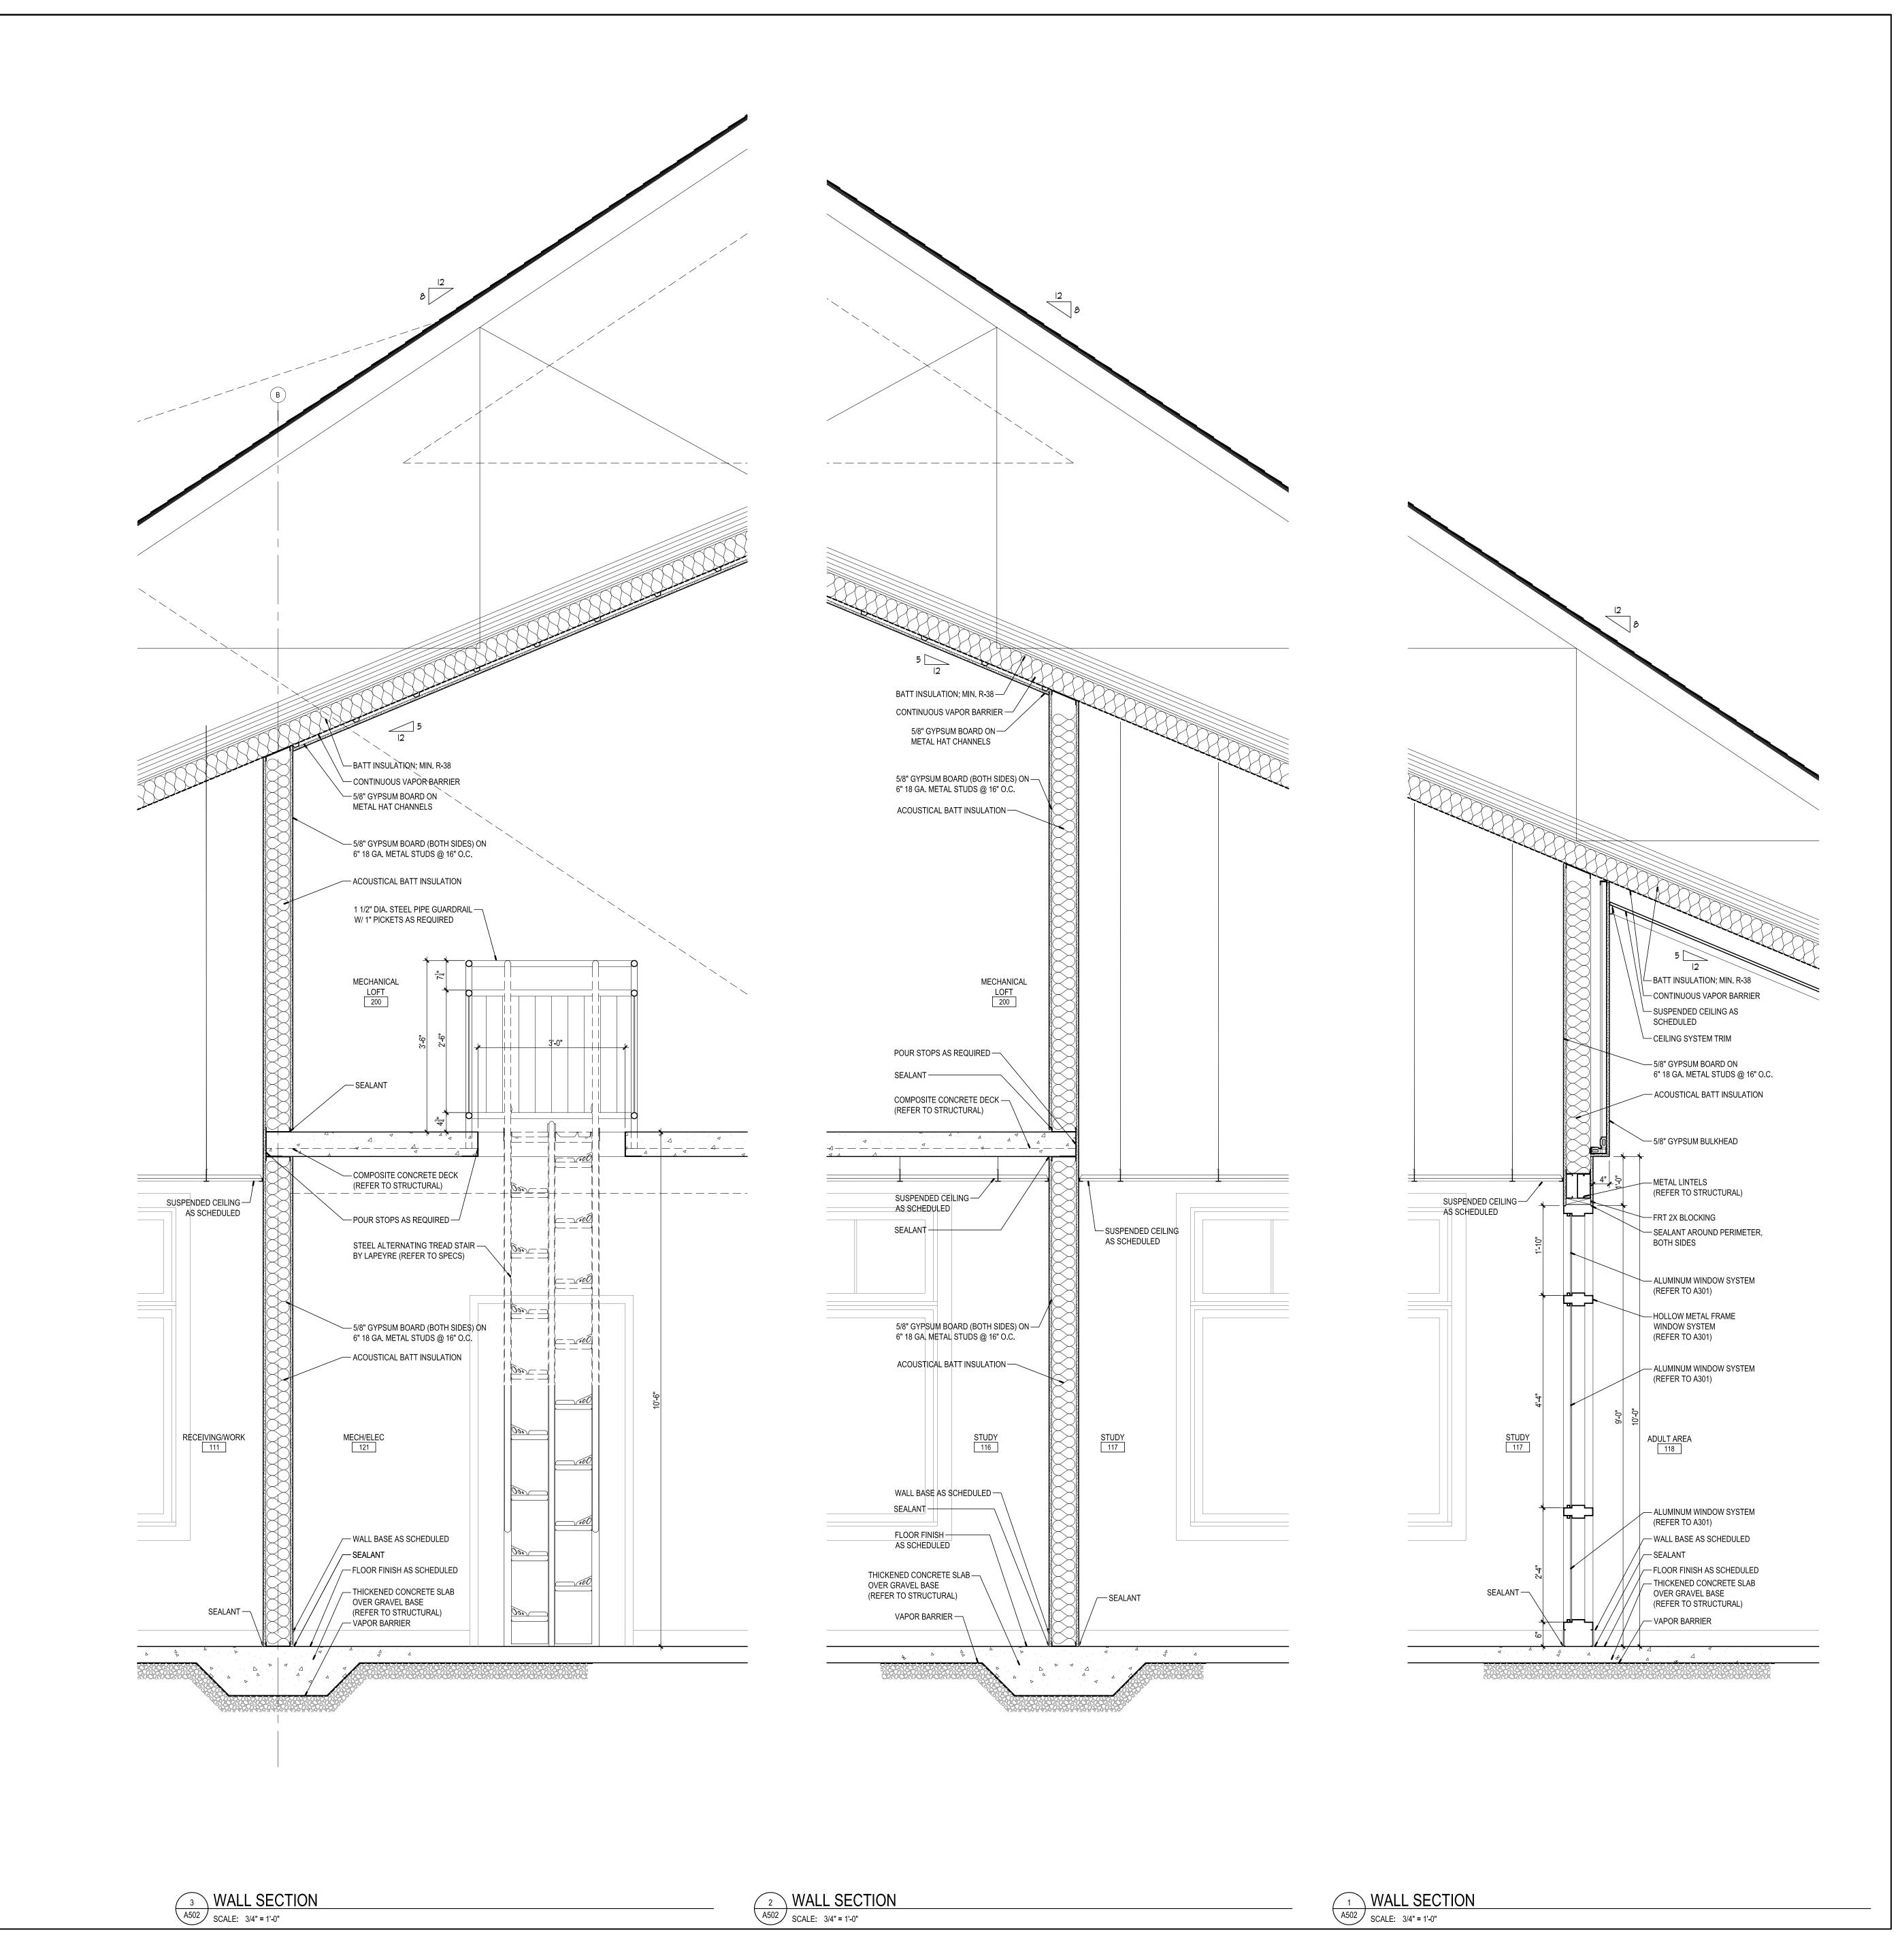
PROJECT STATUS

17905

JOB NUMBER: ISSUE DATE: 10 APRIL 2018 AS INDICATED SCALE: SHEET TITLE: **WALL SECTIONS** SHEET NUMBER:

A500

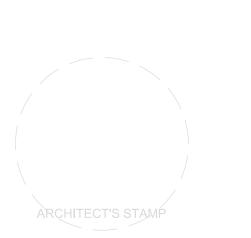



PROJECT TITLE

MYERSVILLE COMMUNITY LIBRARY

PROJECT ADDRESS

8 HARP PLACE
MYERSVILLE, MD 21773

FREDERICK COUNTY,
MARYLAND
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STRUCTURAL ENGINEER


3 WEST SECOND STREET | FREDERICK, MD | 00000-0000 P: 301.695.9424 | F: 301.293.6338

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CJL ENGINEERING



SHEET INFORMATION

KEY PLAN

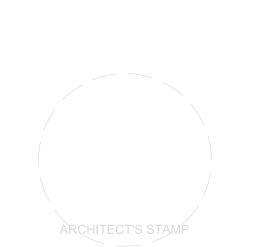
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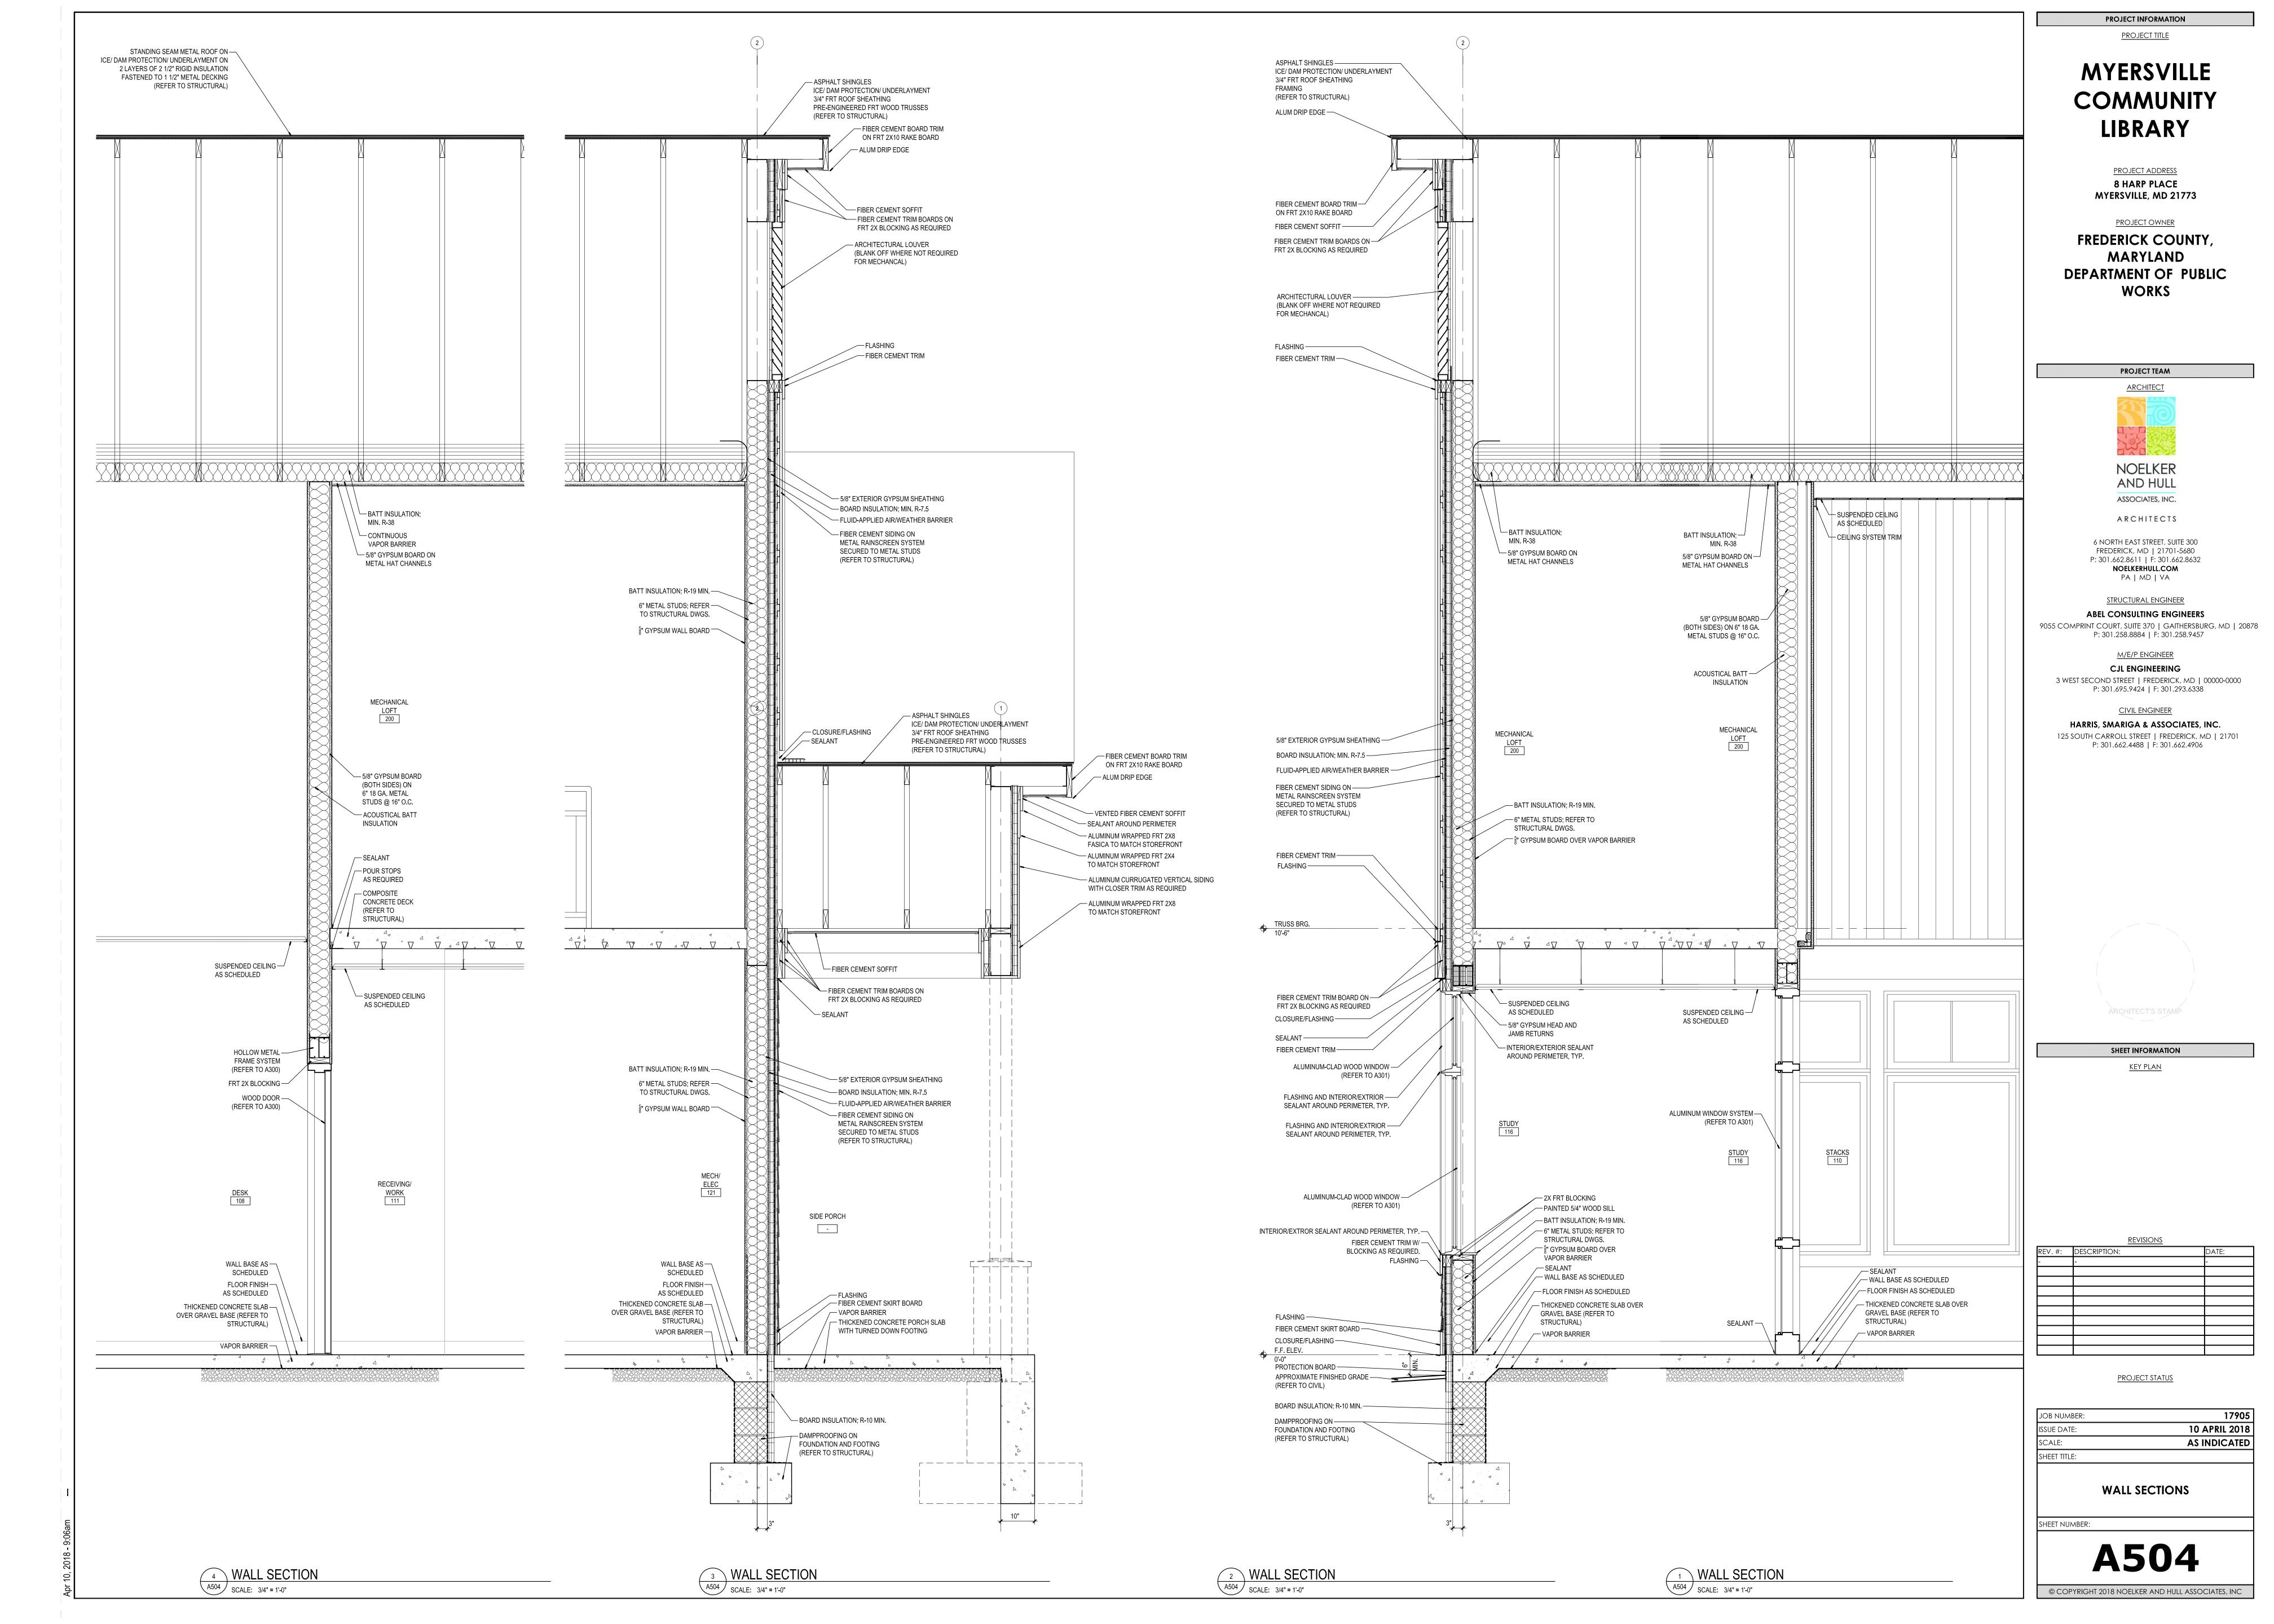
PROJECT STATUS


JOB NUMBER: 17905
ISSUE DATE: 10 APRIL 2018
SCALE: AS INDICATED
SHEET TITLE:


WALL SECTIONS


SHEET NUMBER:



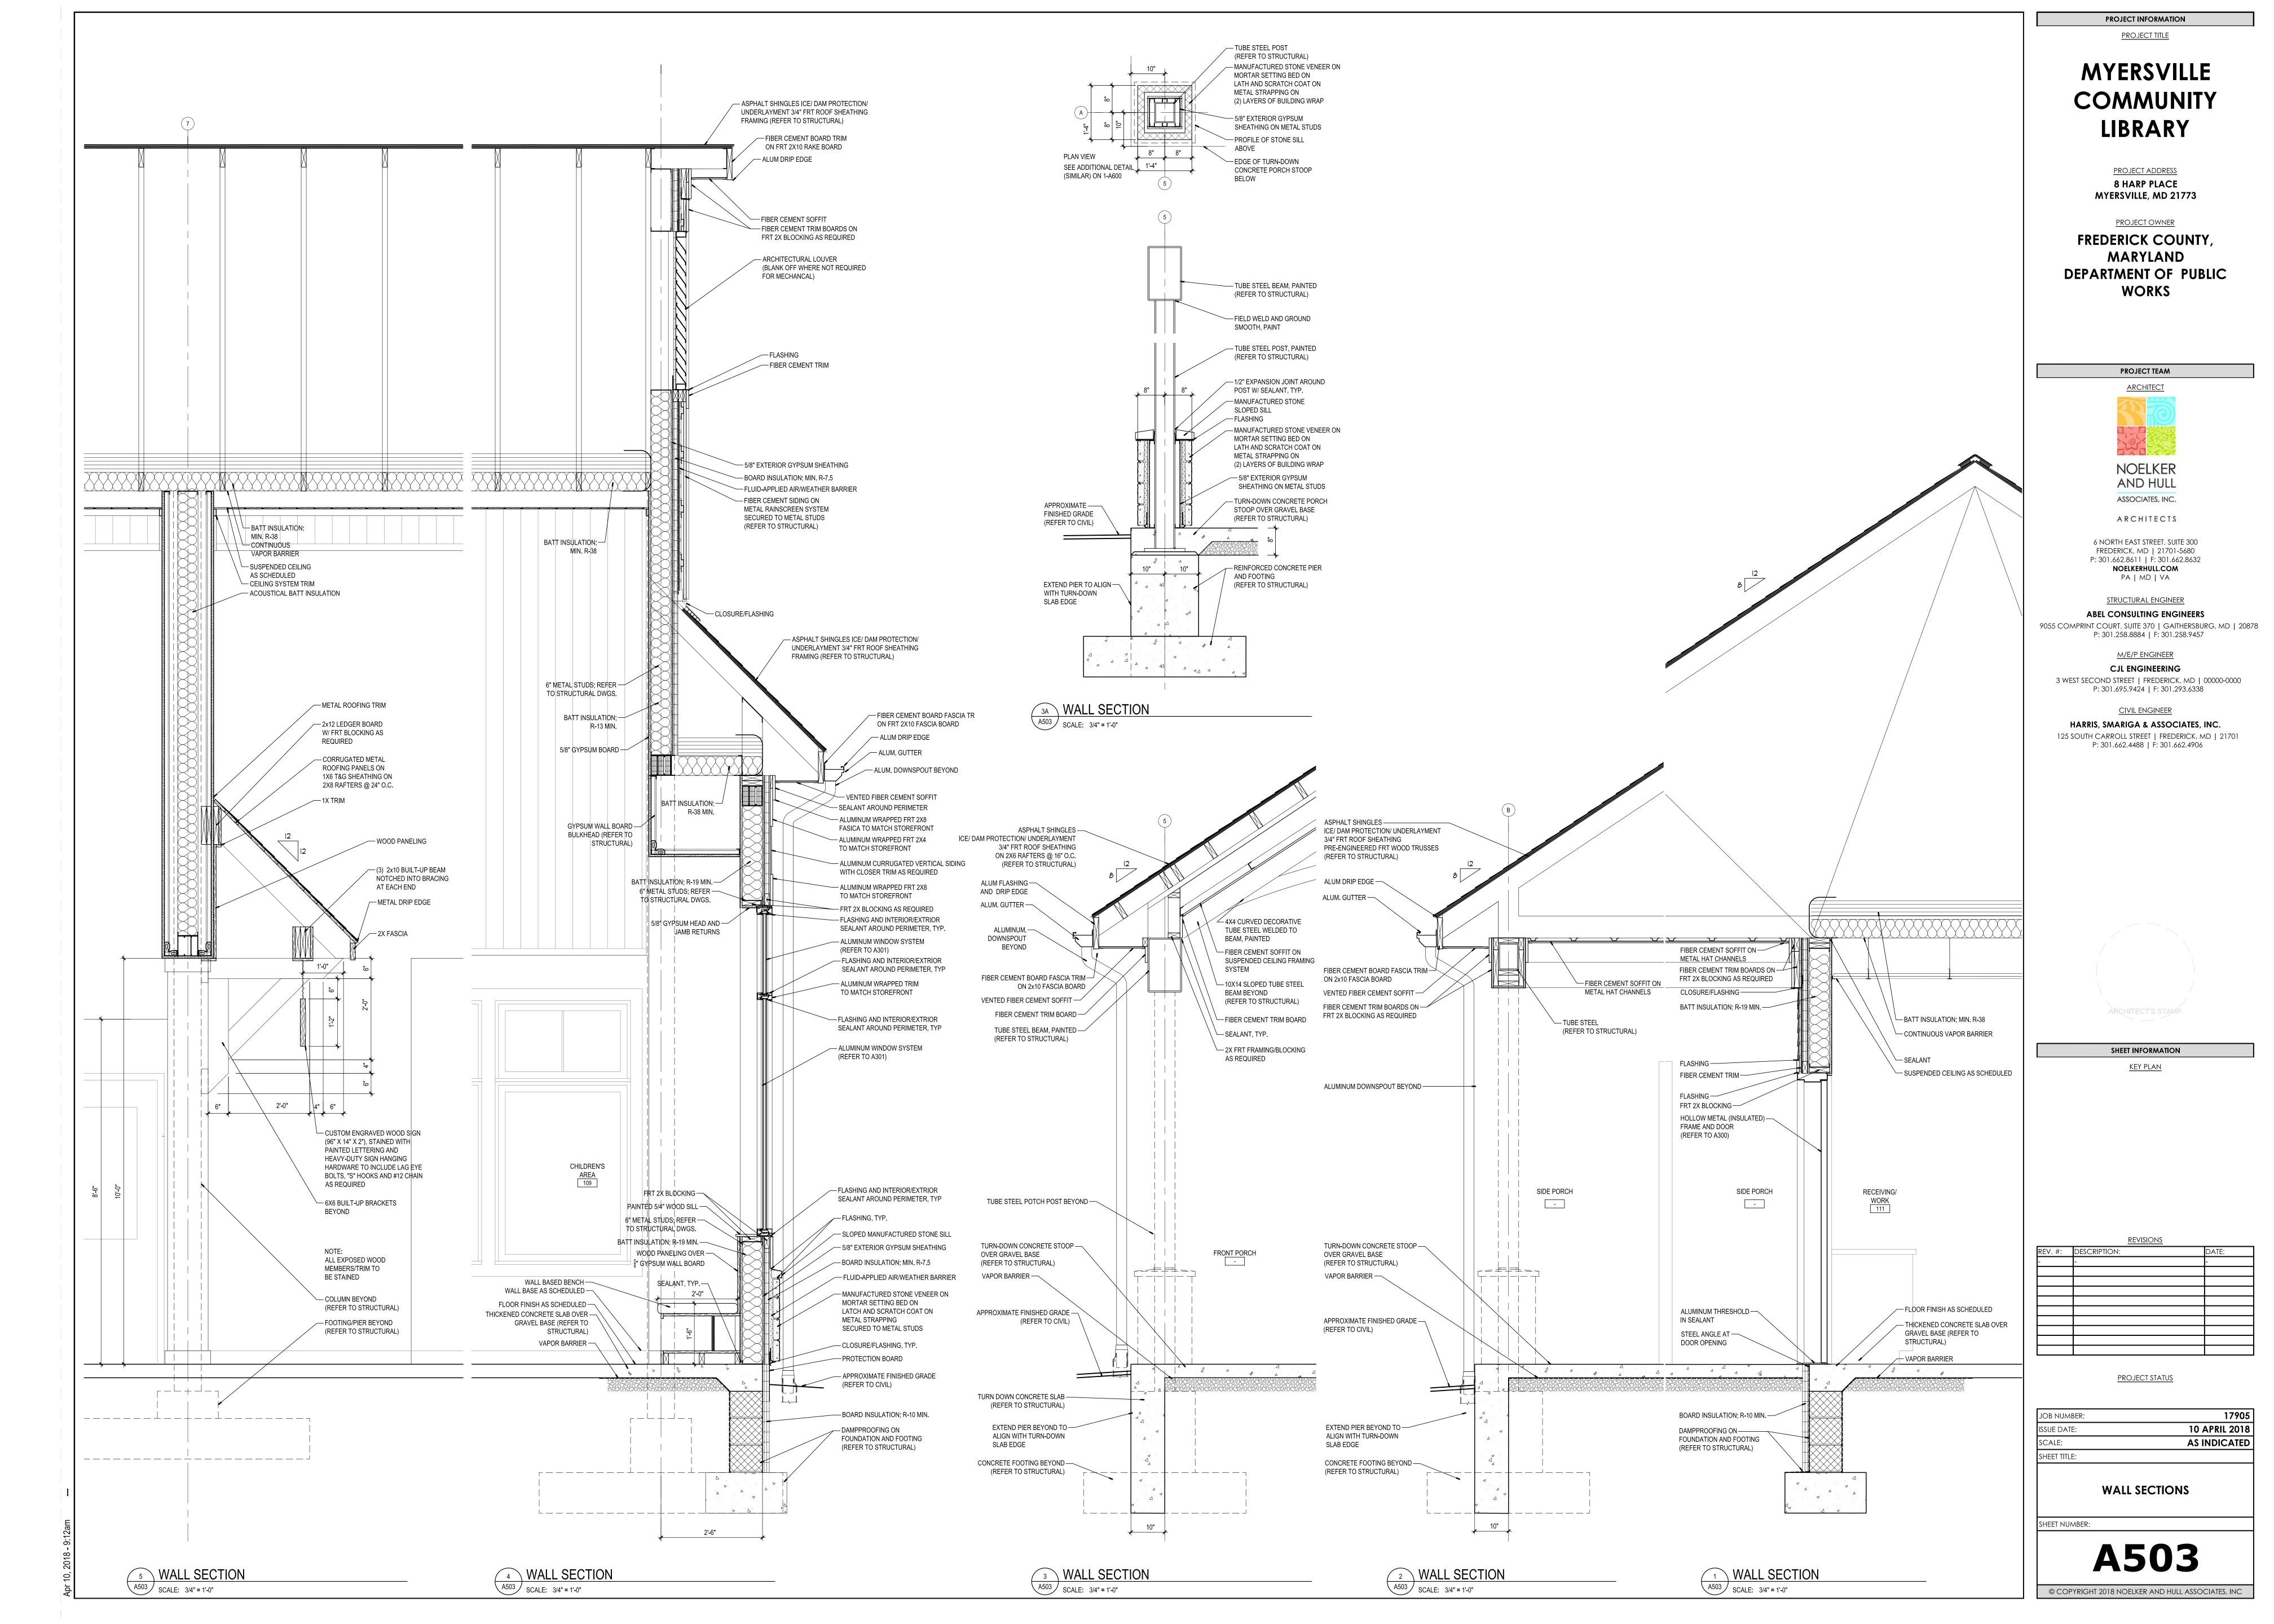

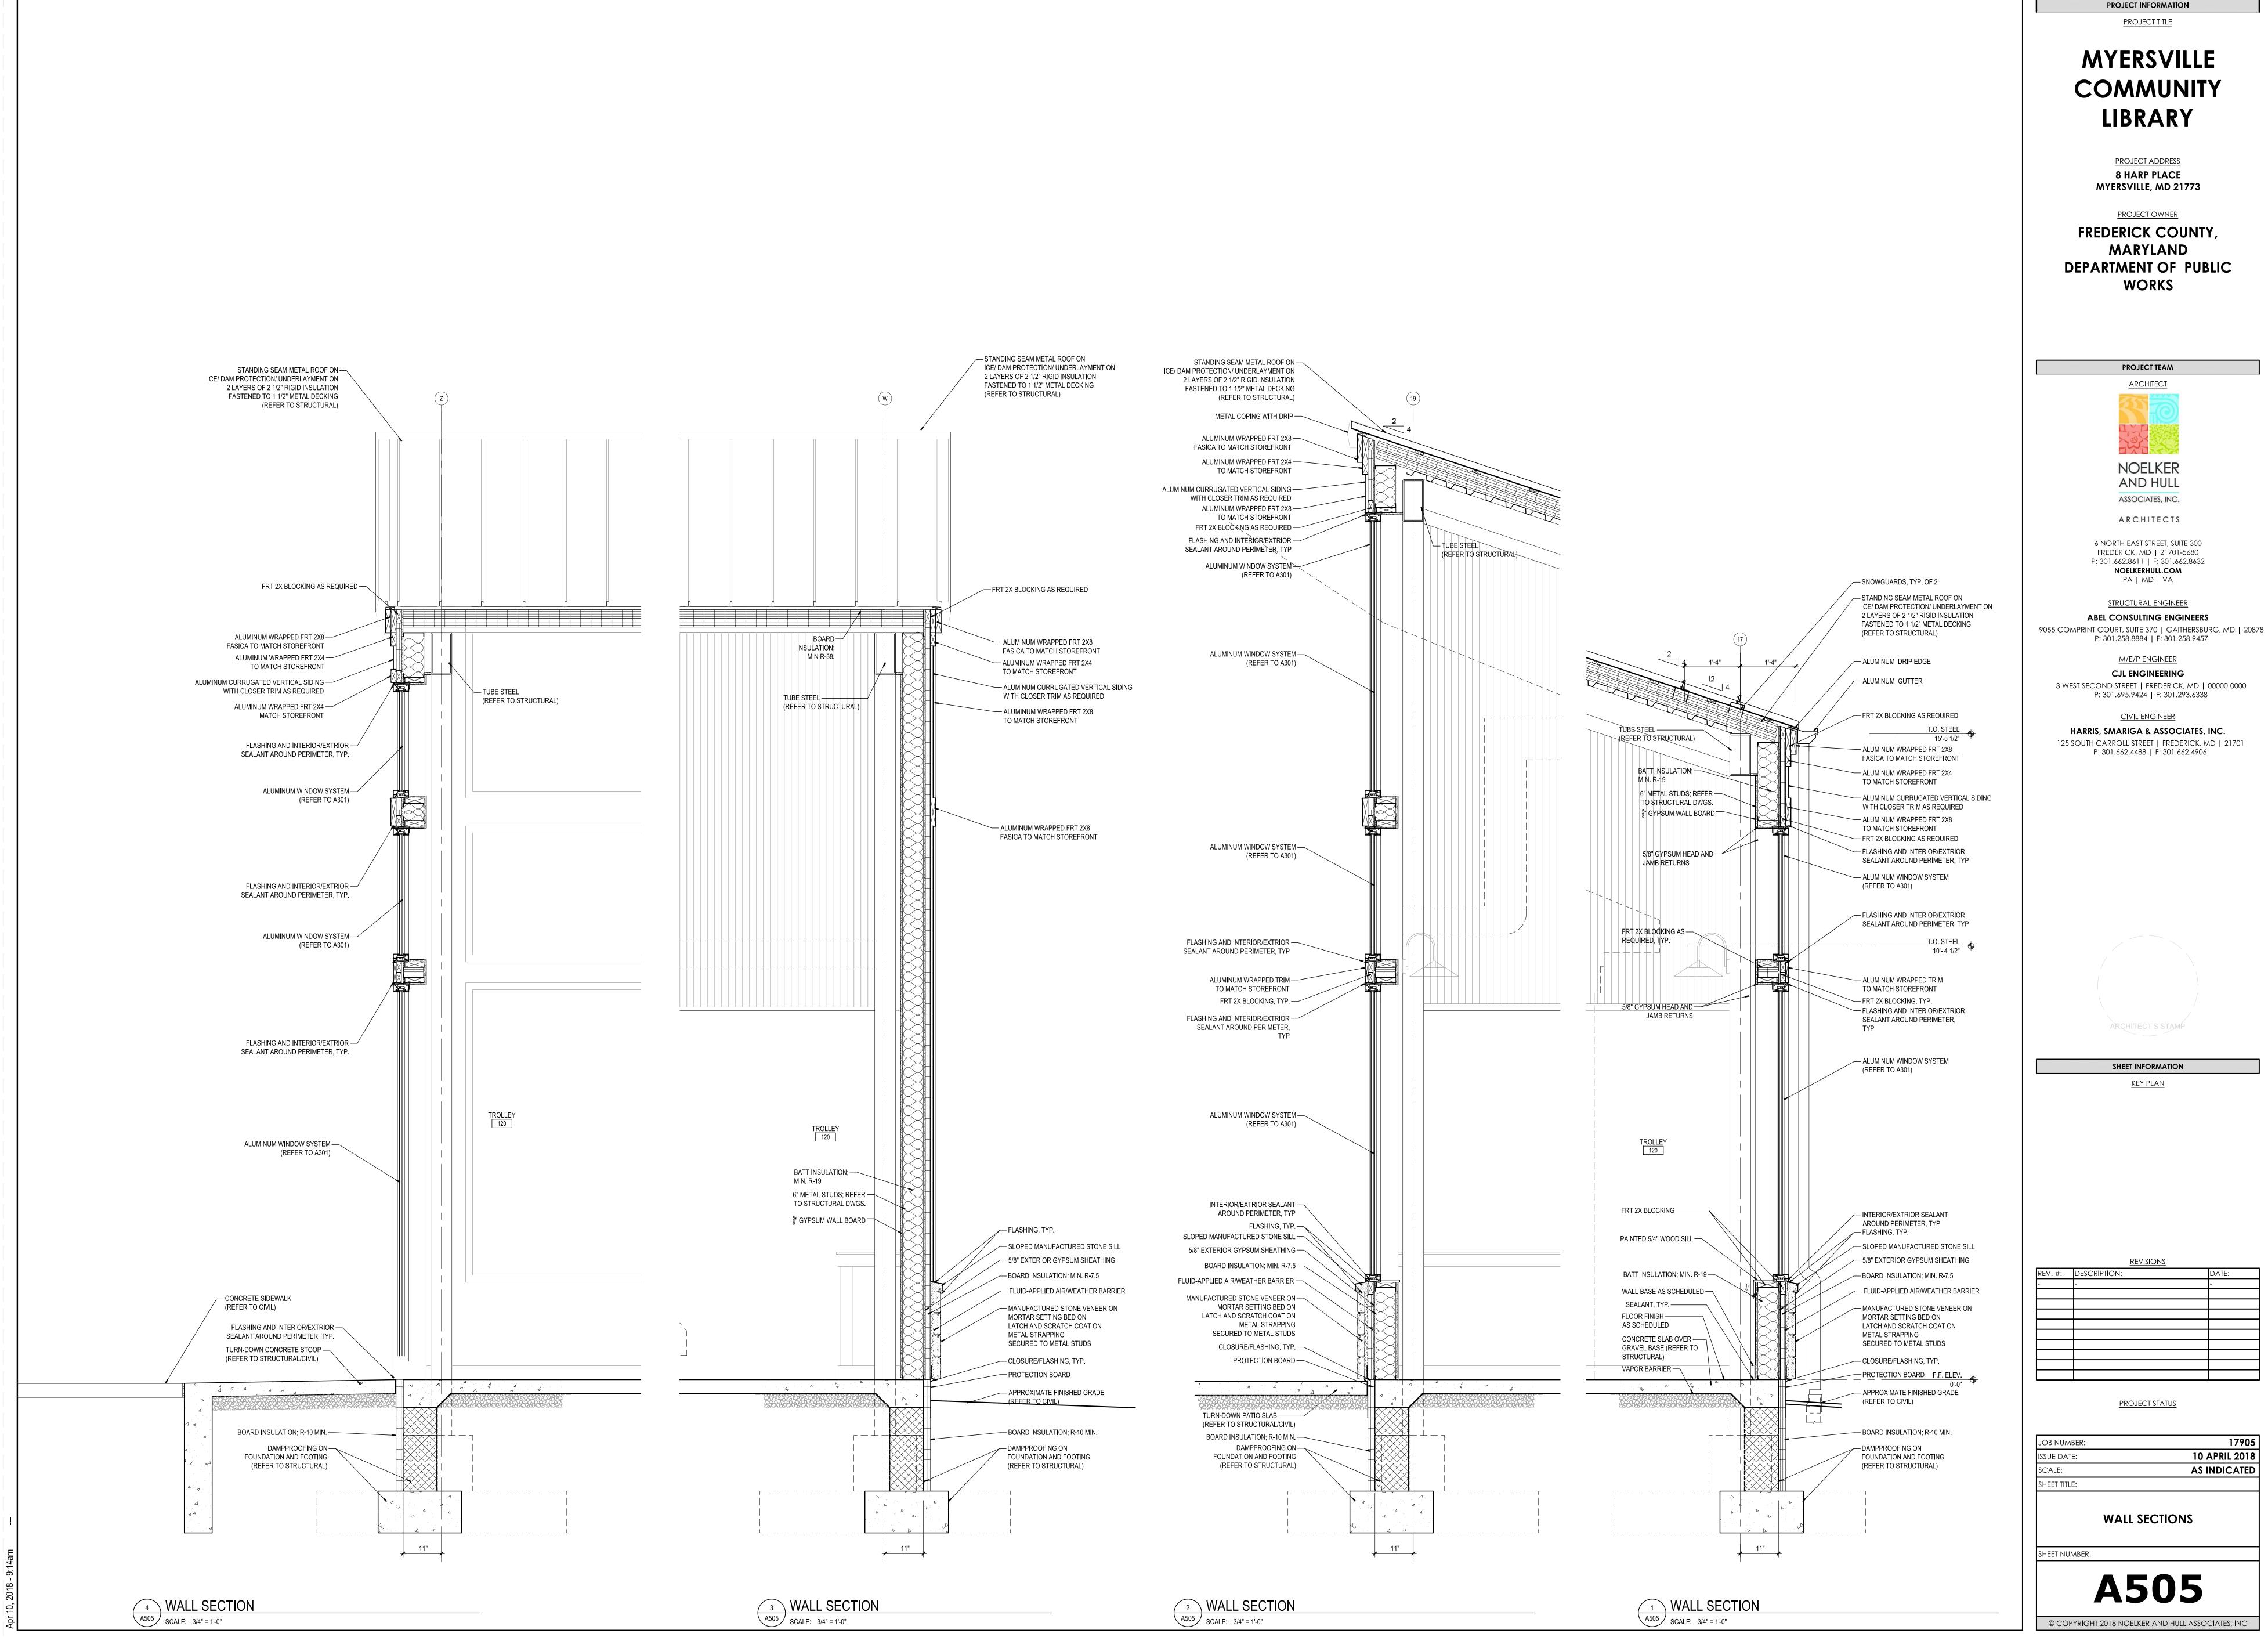

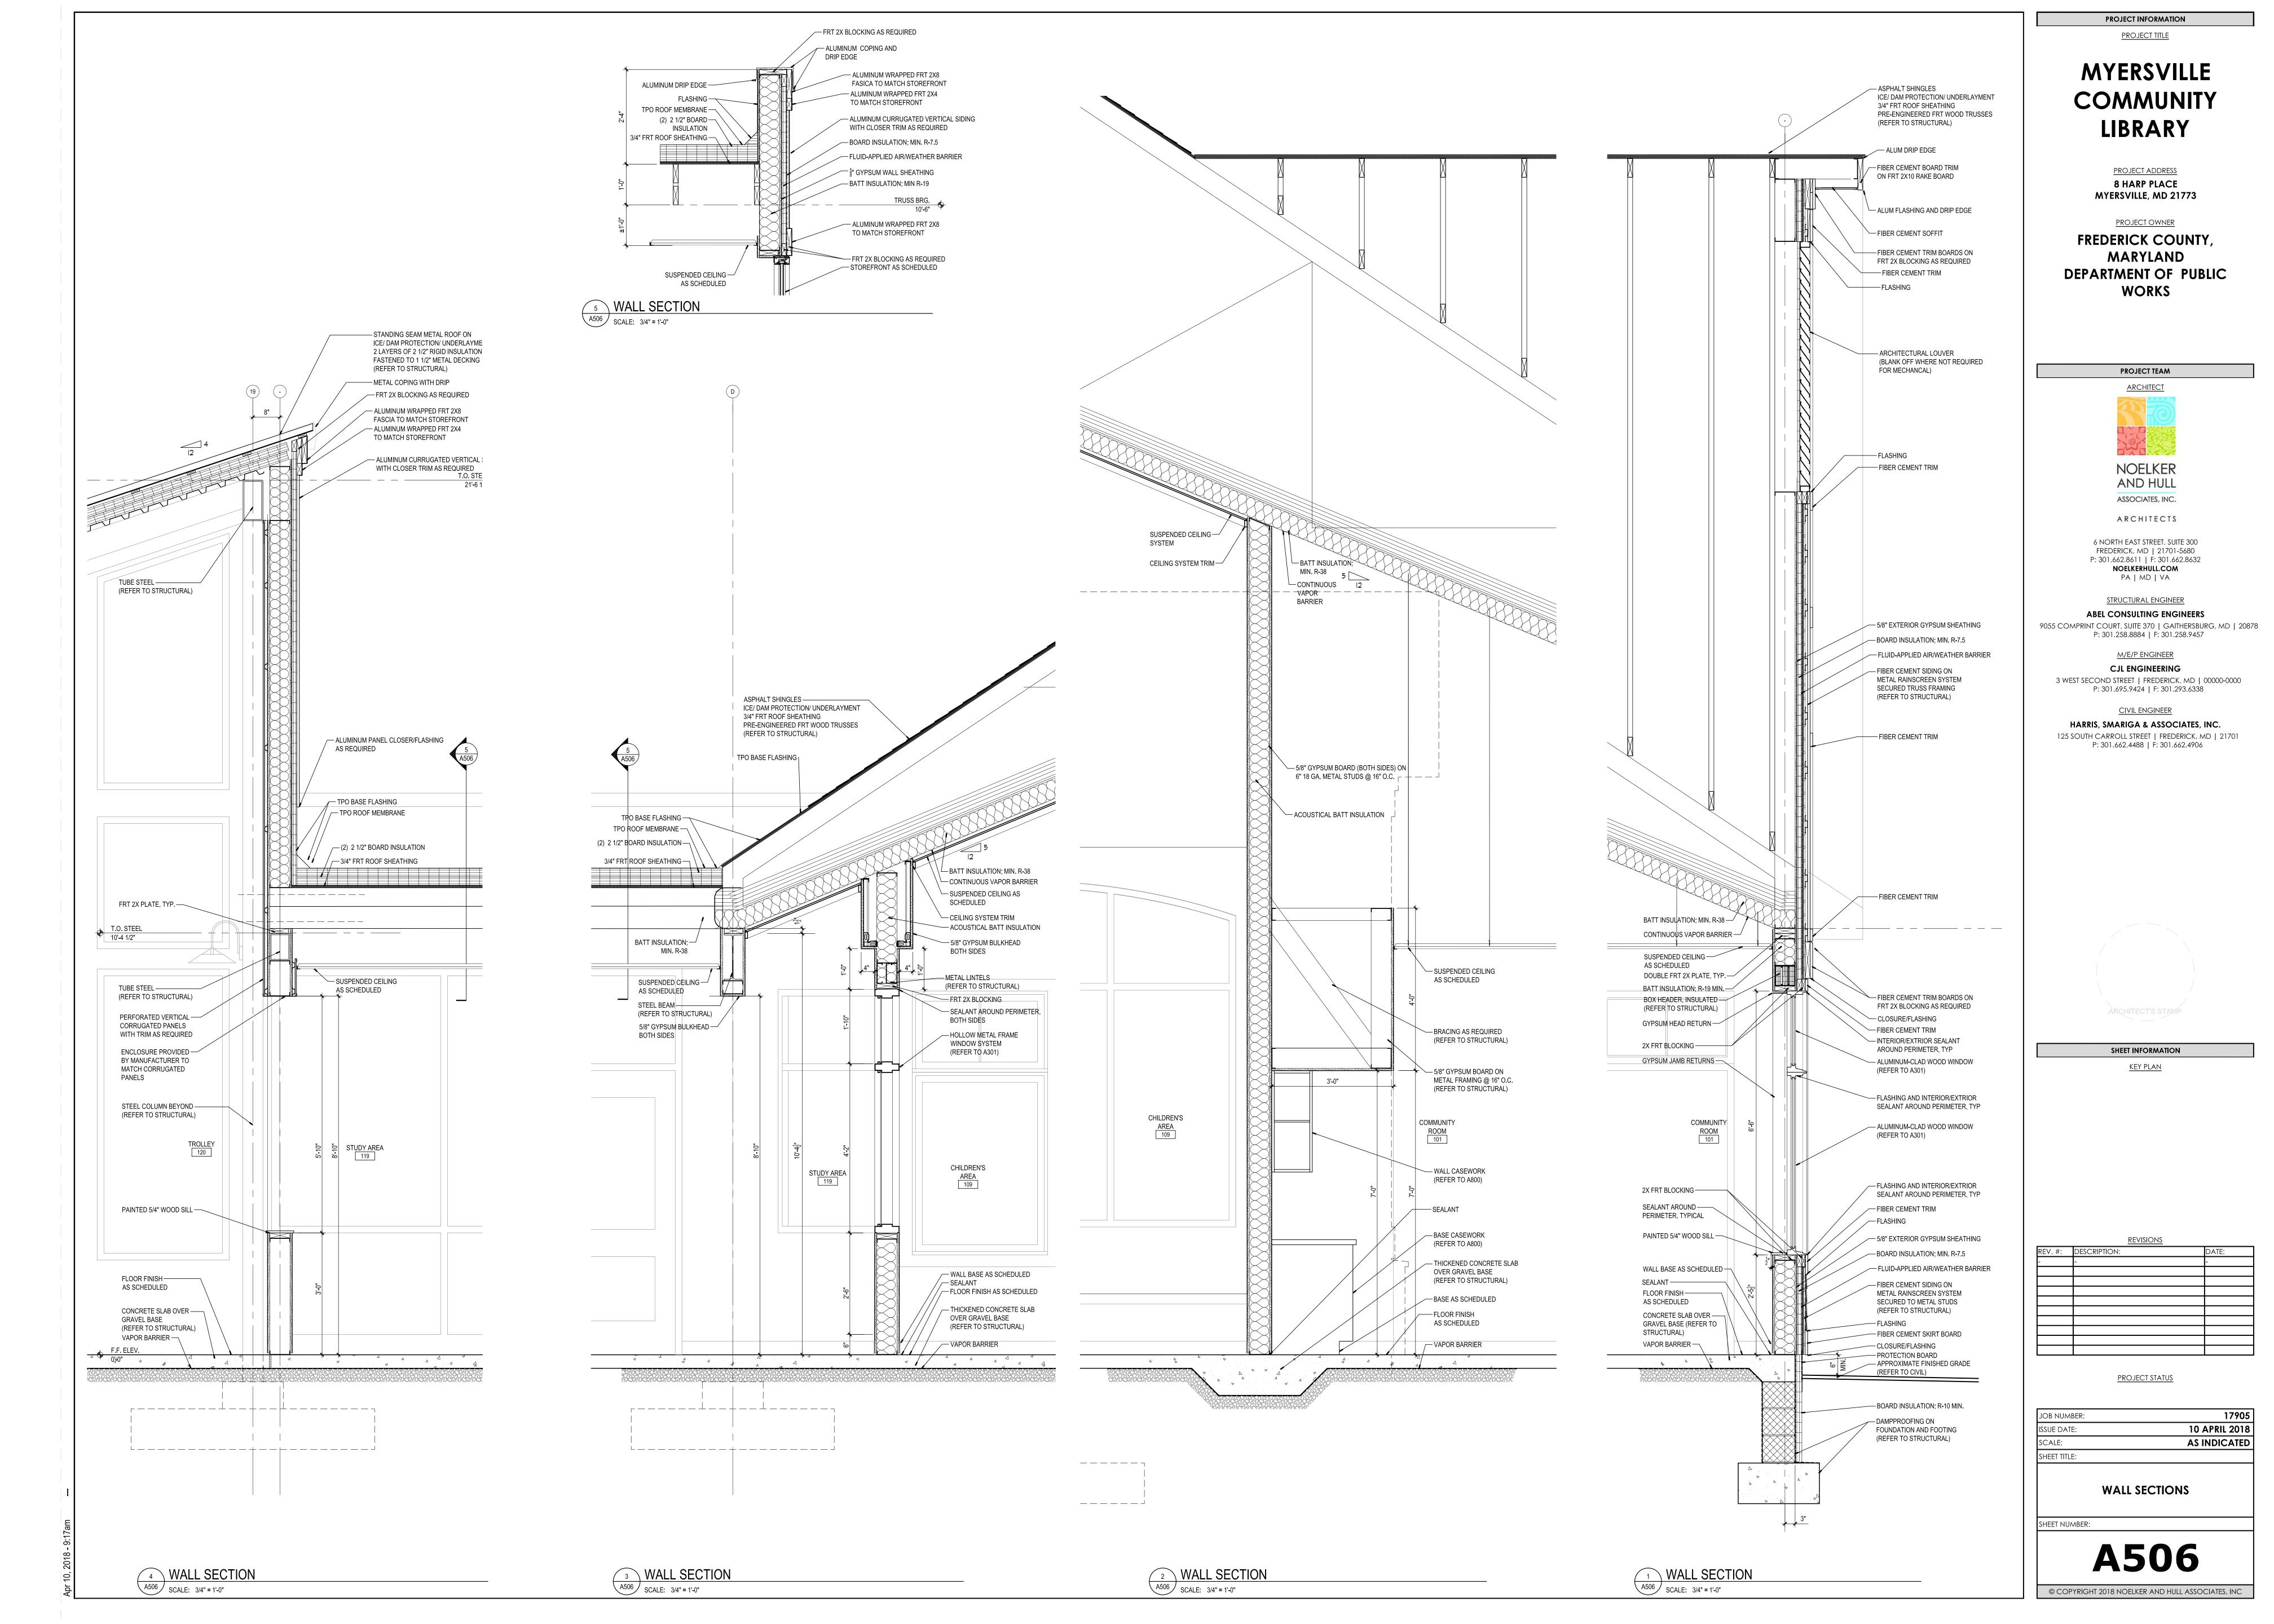

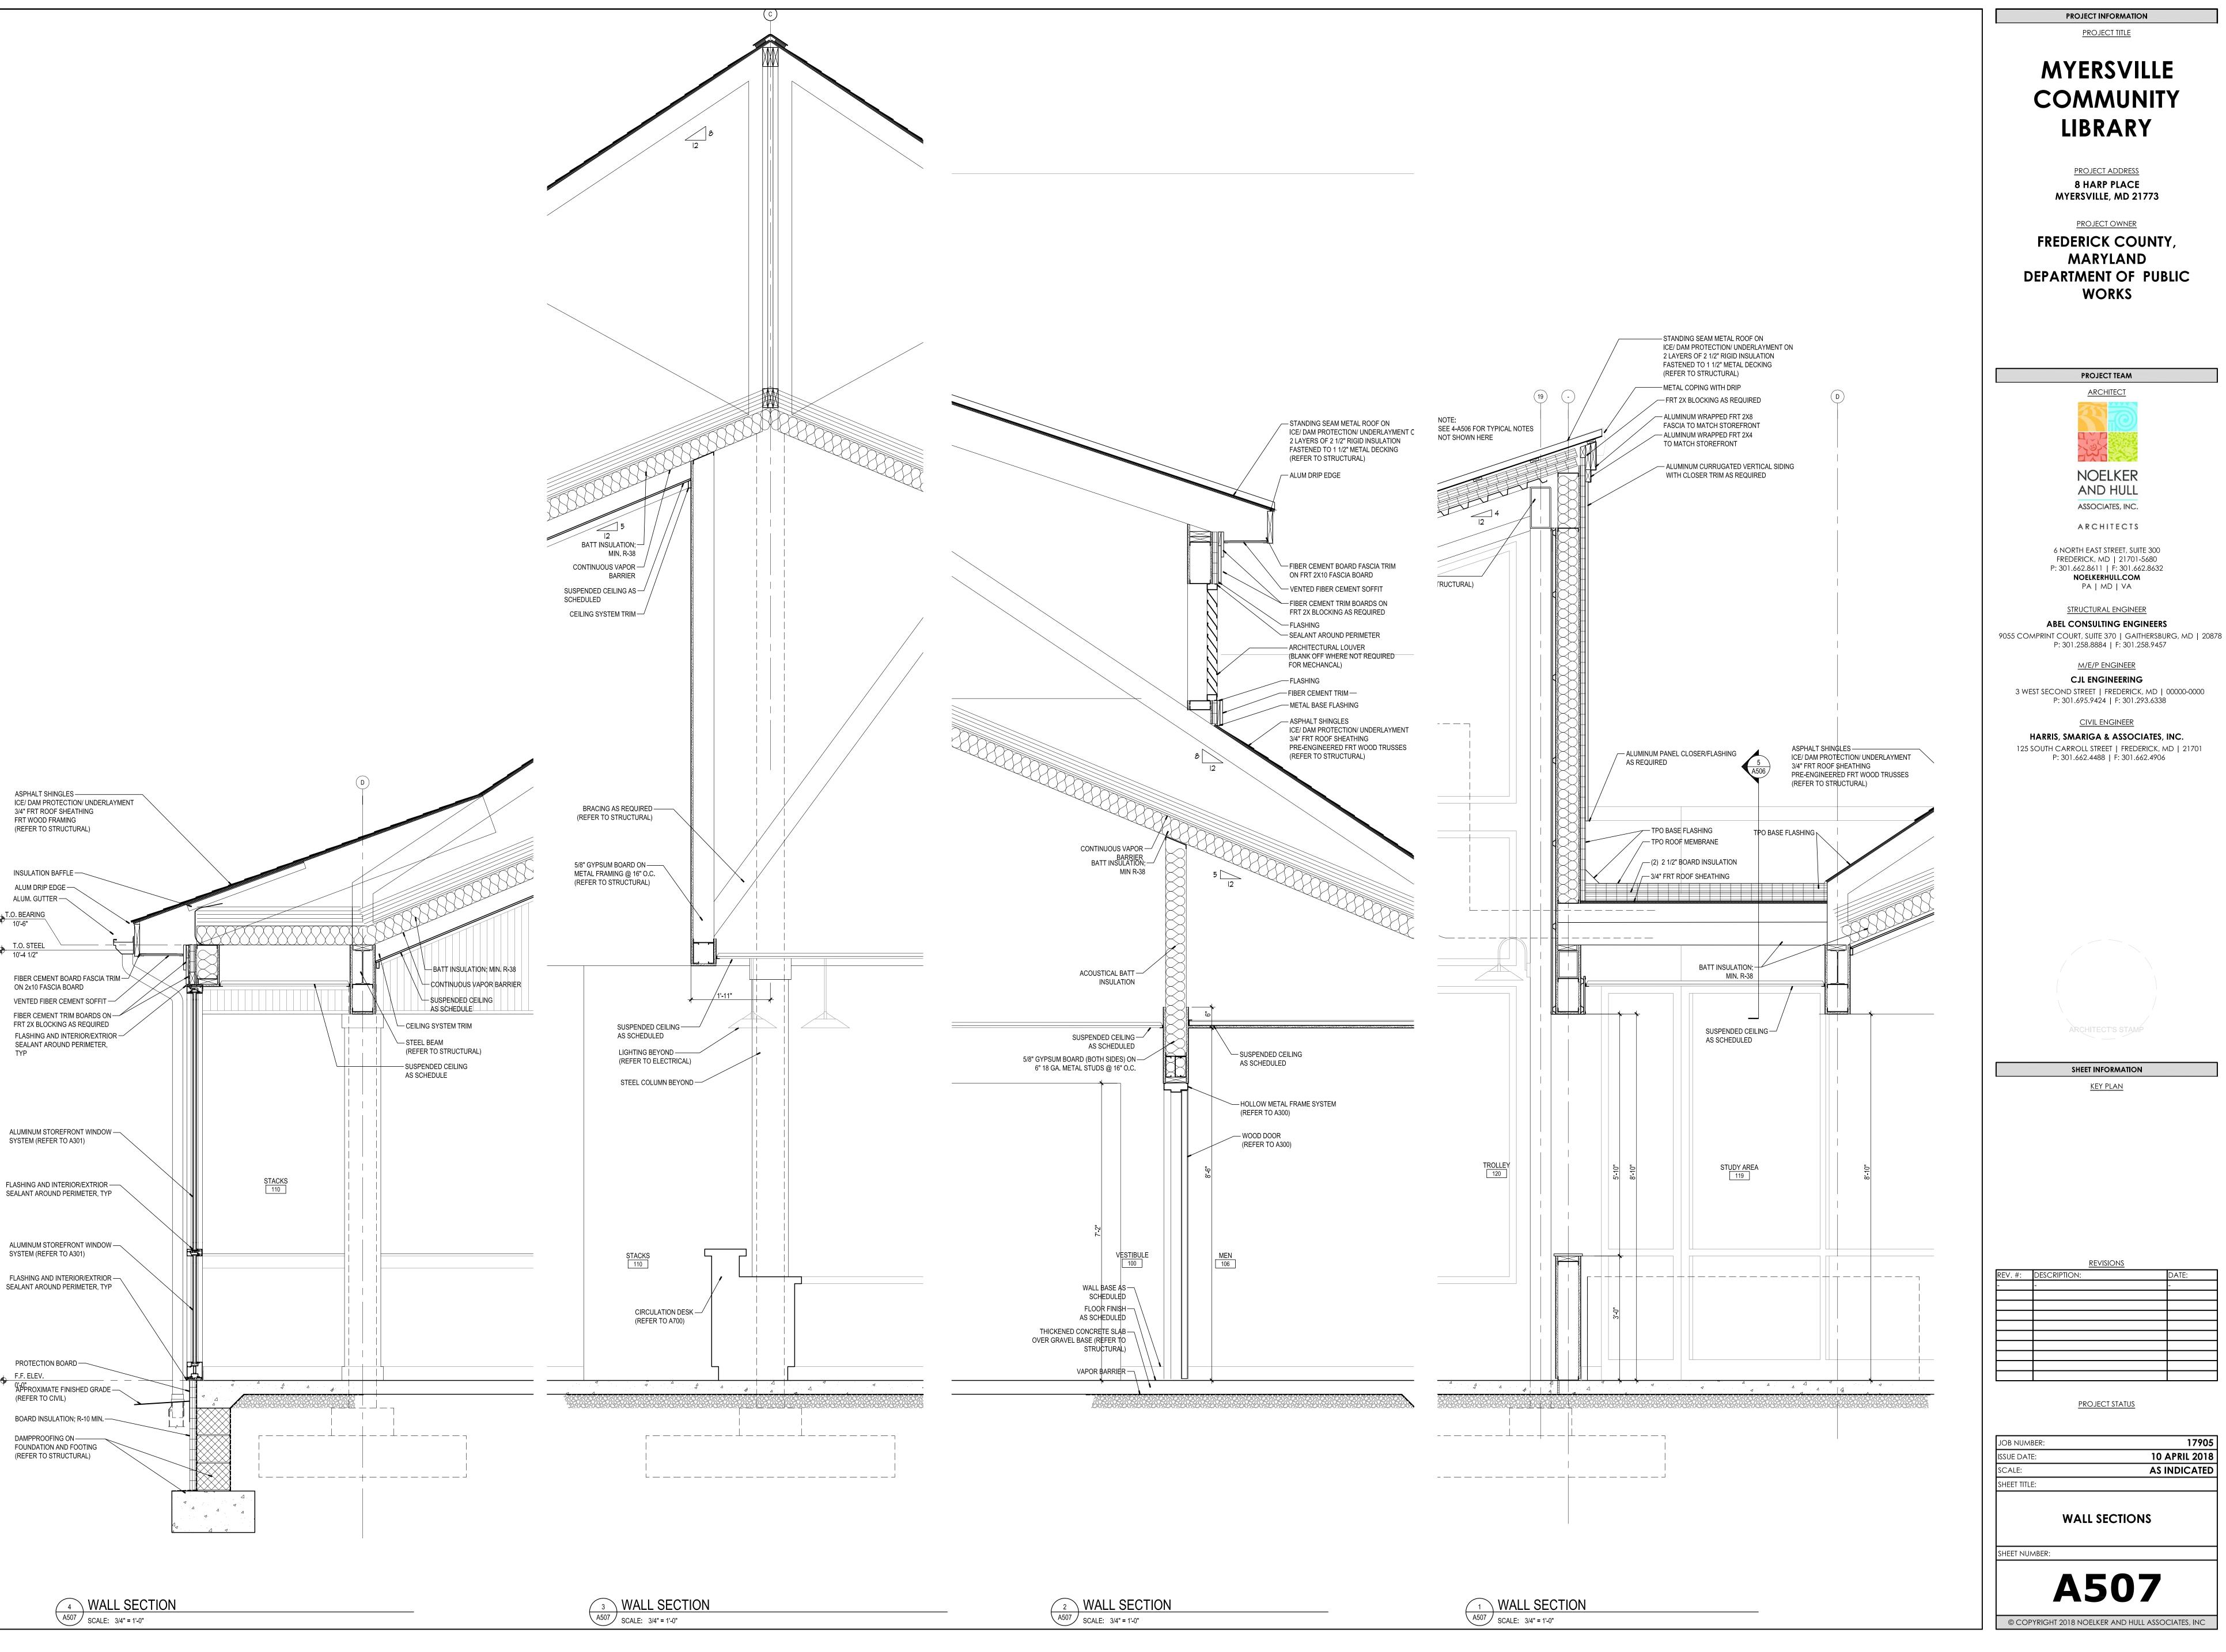

PROJECT TITLE

MYERSVILLE COMMUNITY LIBRARY

PROJECT ADDRESS **8 HARP PLACE** MYERSVILLE, MD 21773

PROJECT OWNER FREDERICK COUNTY, **MARYLAND** DEPARTMENT OF PUBLIC **WORKS**

> PROJECT TEAM **NOELKER** AND HULL

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P: 301.662.8611 | F: 301.662.8632 NOELKERHULL.COM PA | MD | VA STRUCTURAL ENGINEER

M/E/P ENGINEER CJL ENGINEERING 3 WEST SECOND STREET | FREDERICK, MD | 00000-0000

HARRIS, SMARIGA & ASSOCIATES, INC. 125 SOUTH CARROLL STREET | FREDERICK, MD | 21701 P: 301.662.4488 | F: 301.662.4906





SHEET INFORMATION KEY PLAN


PROJECT STATUS


17905 10 APRIL 2018 AS INDICATED WALL SECTIONS

A507

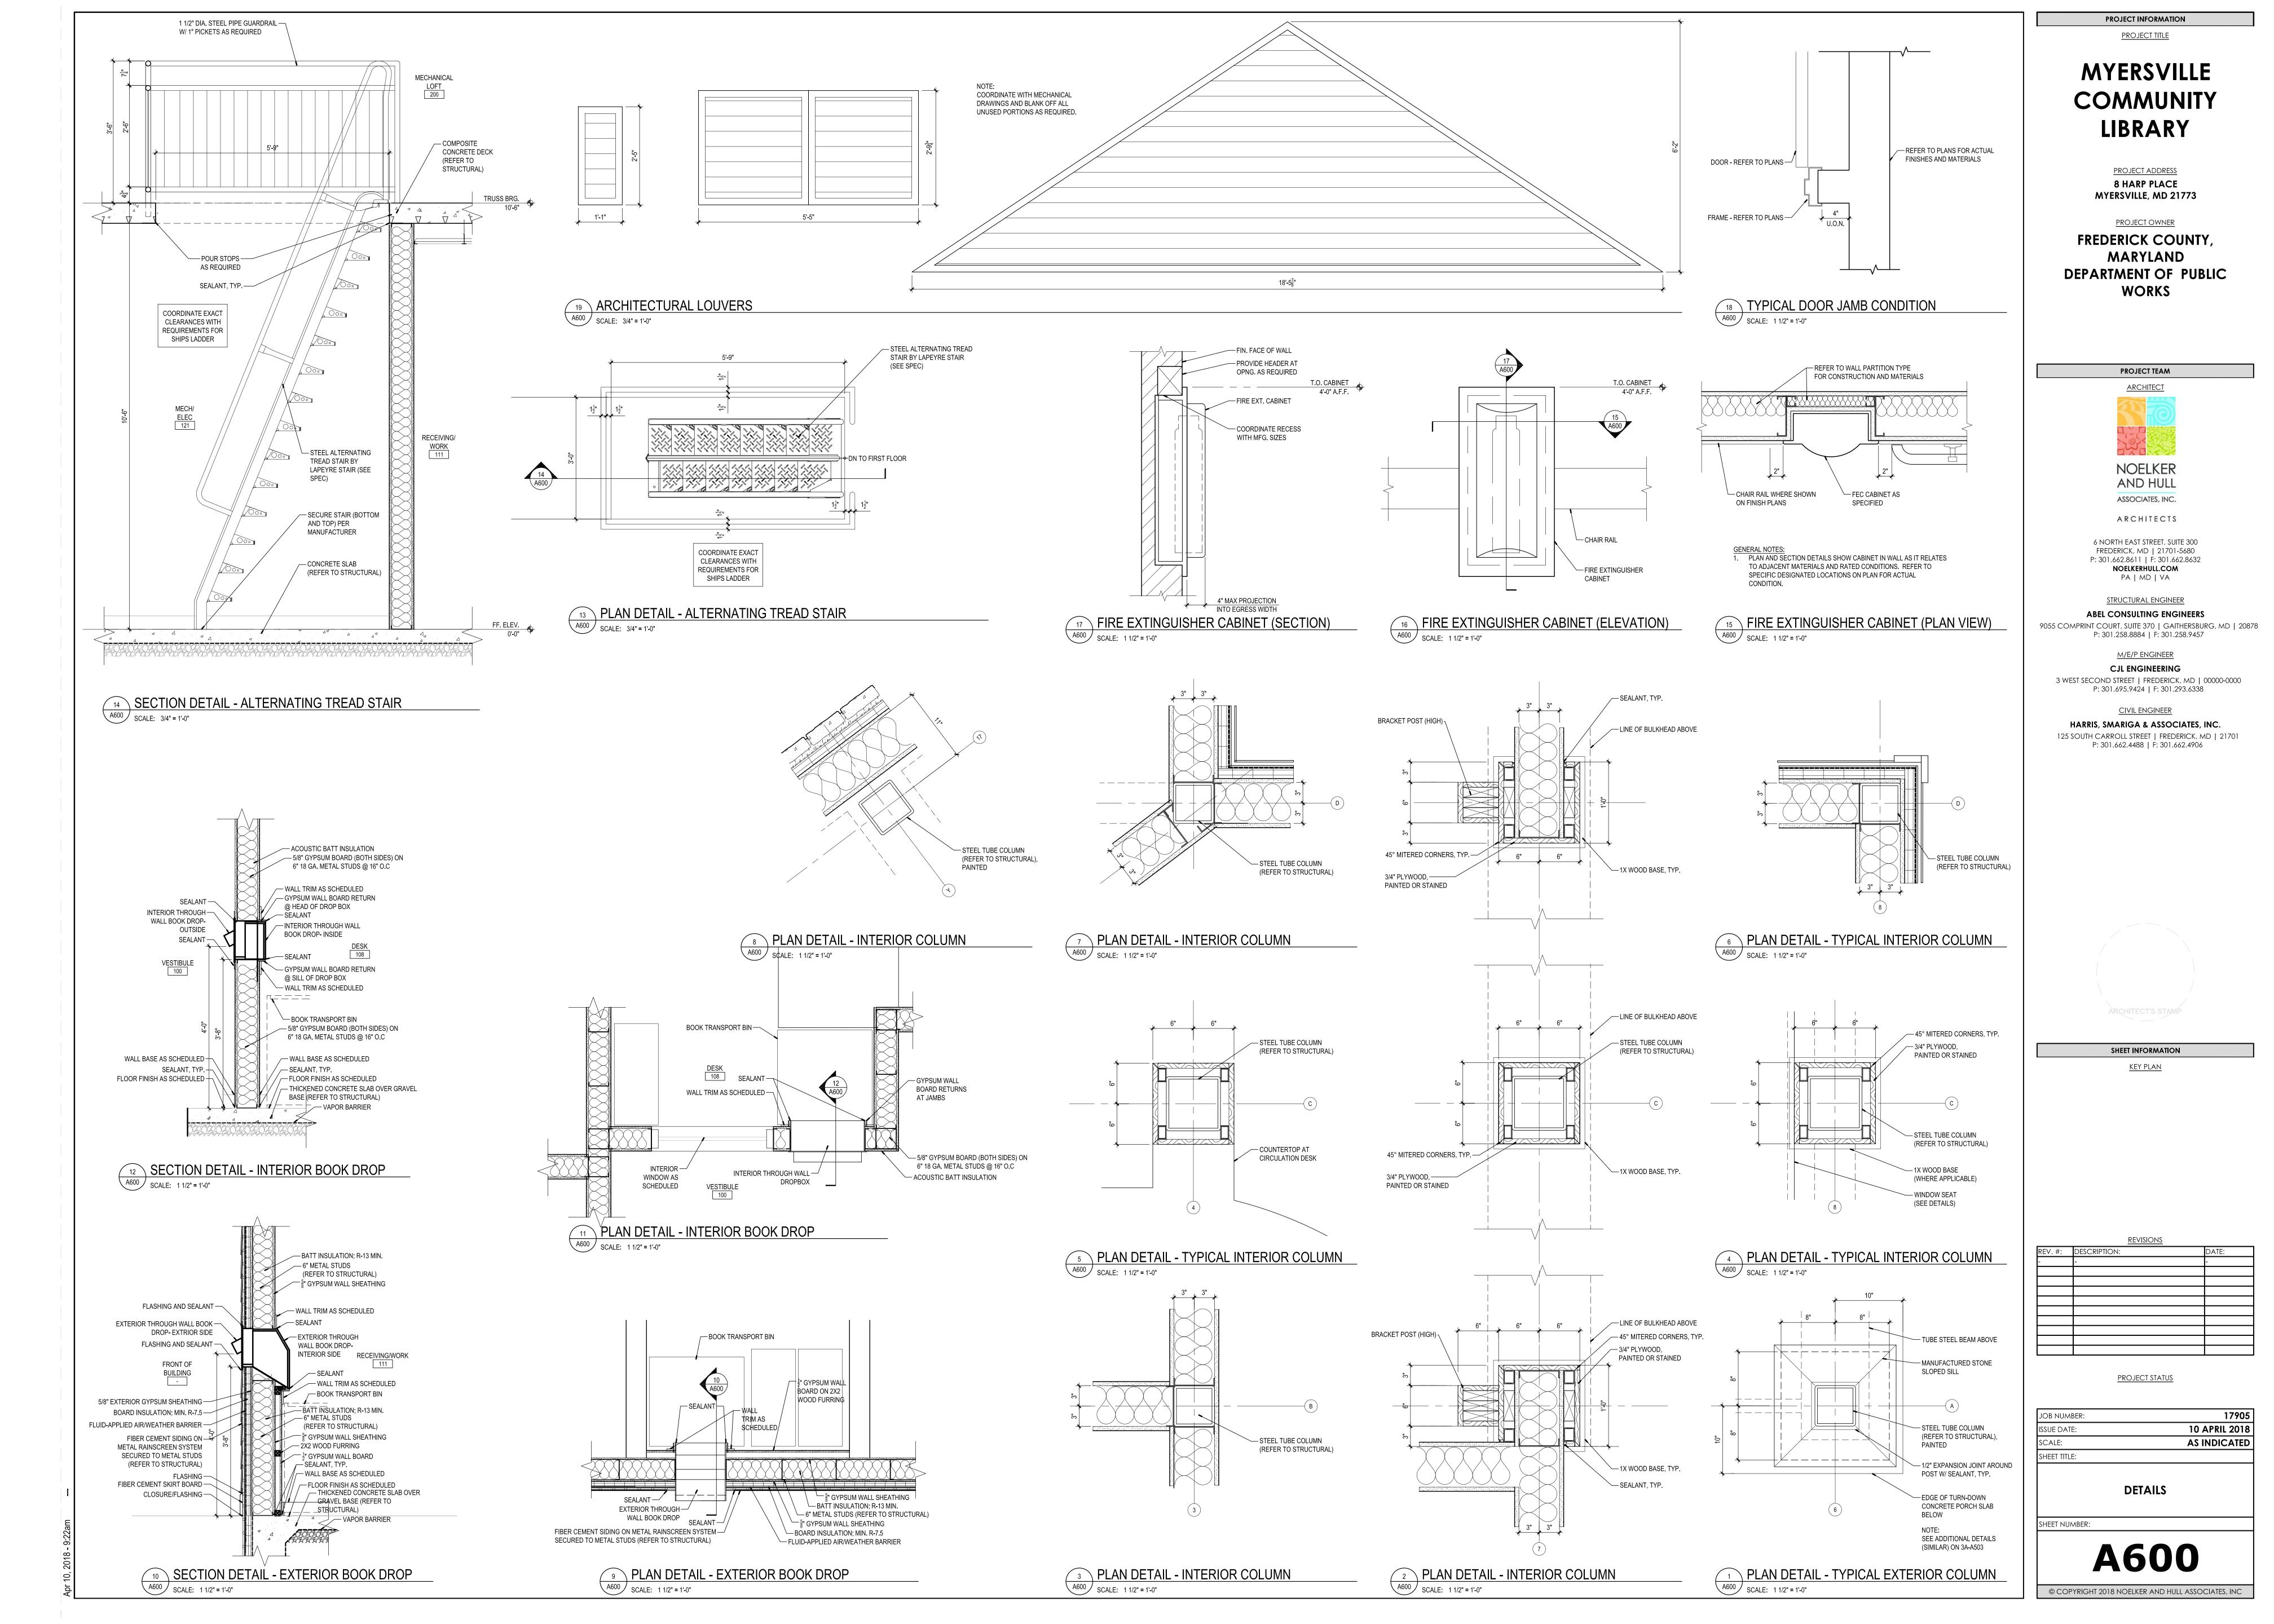

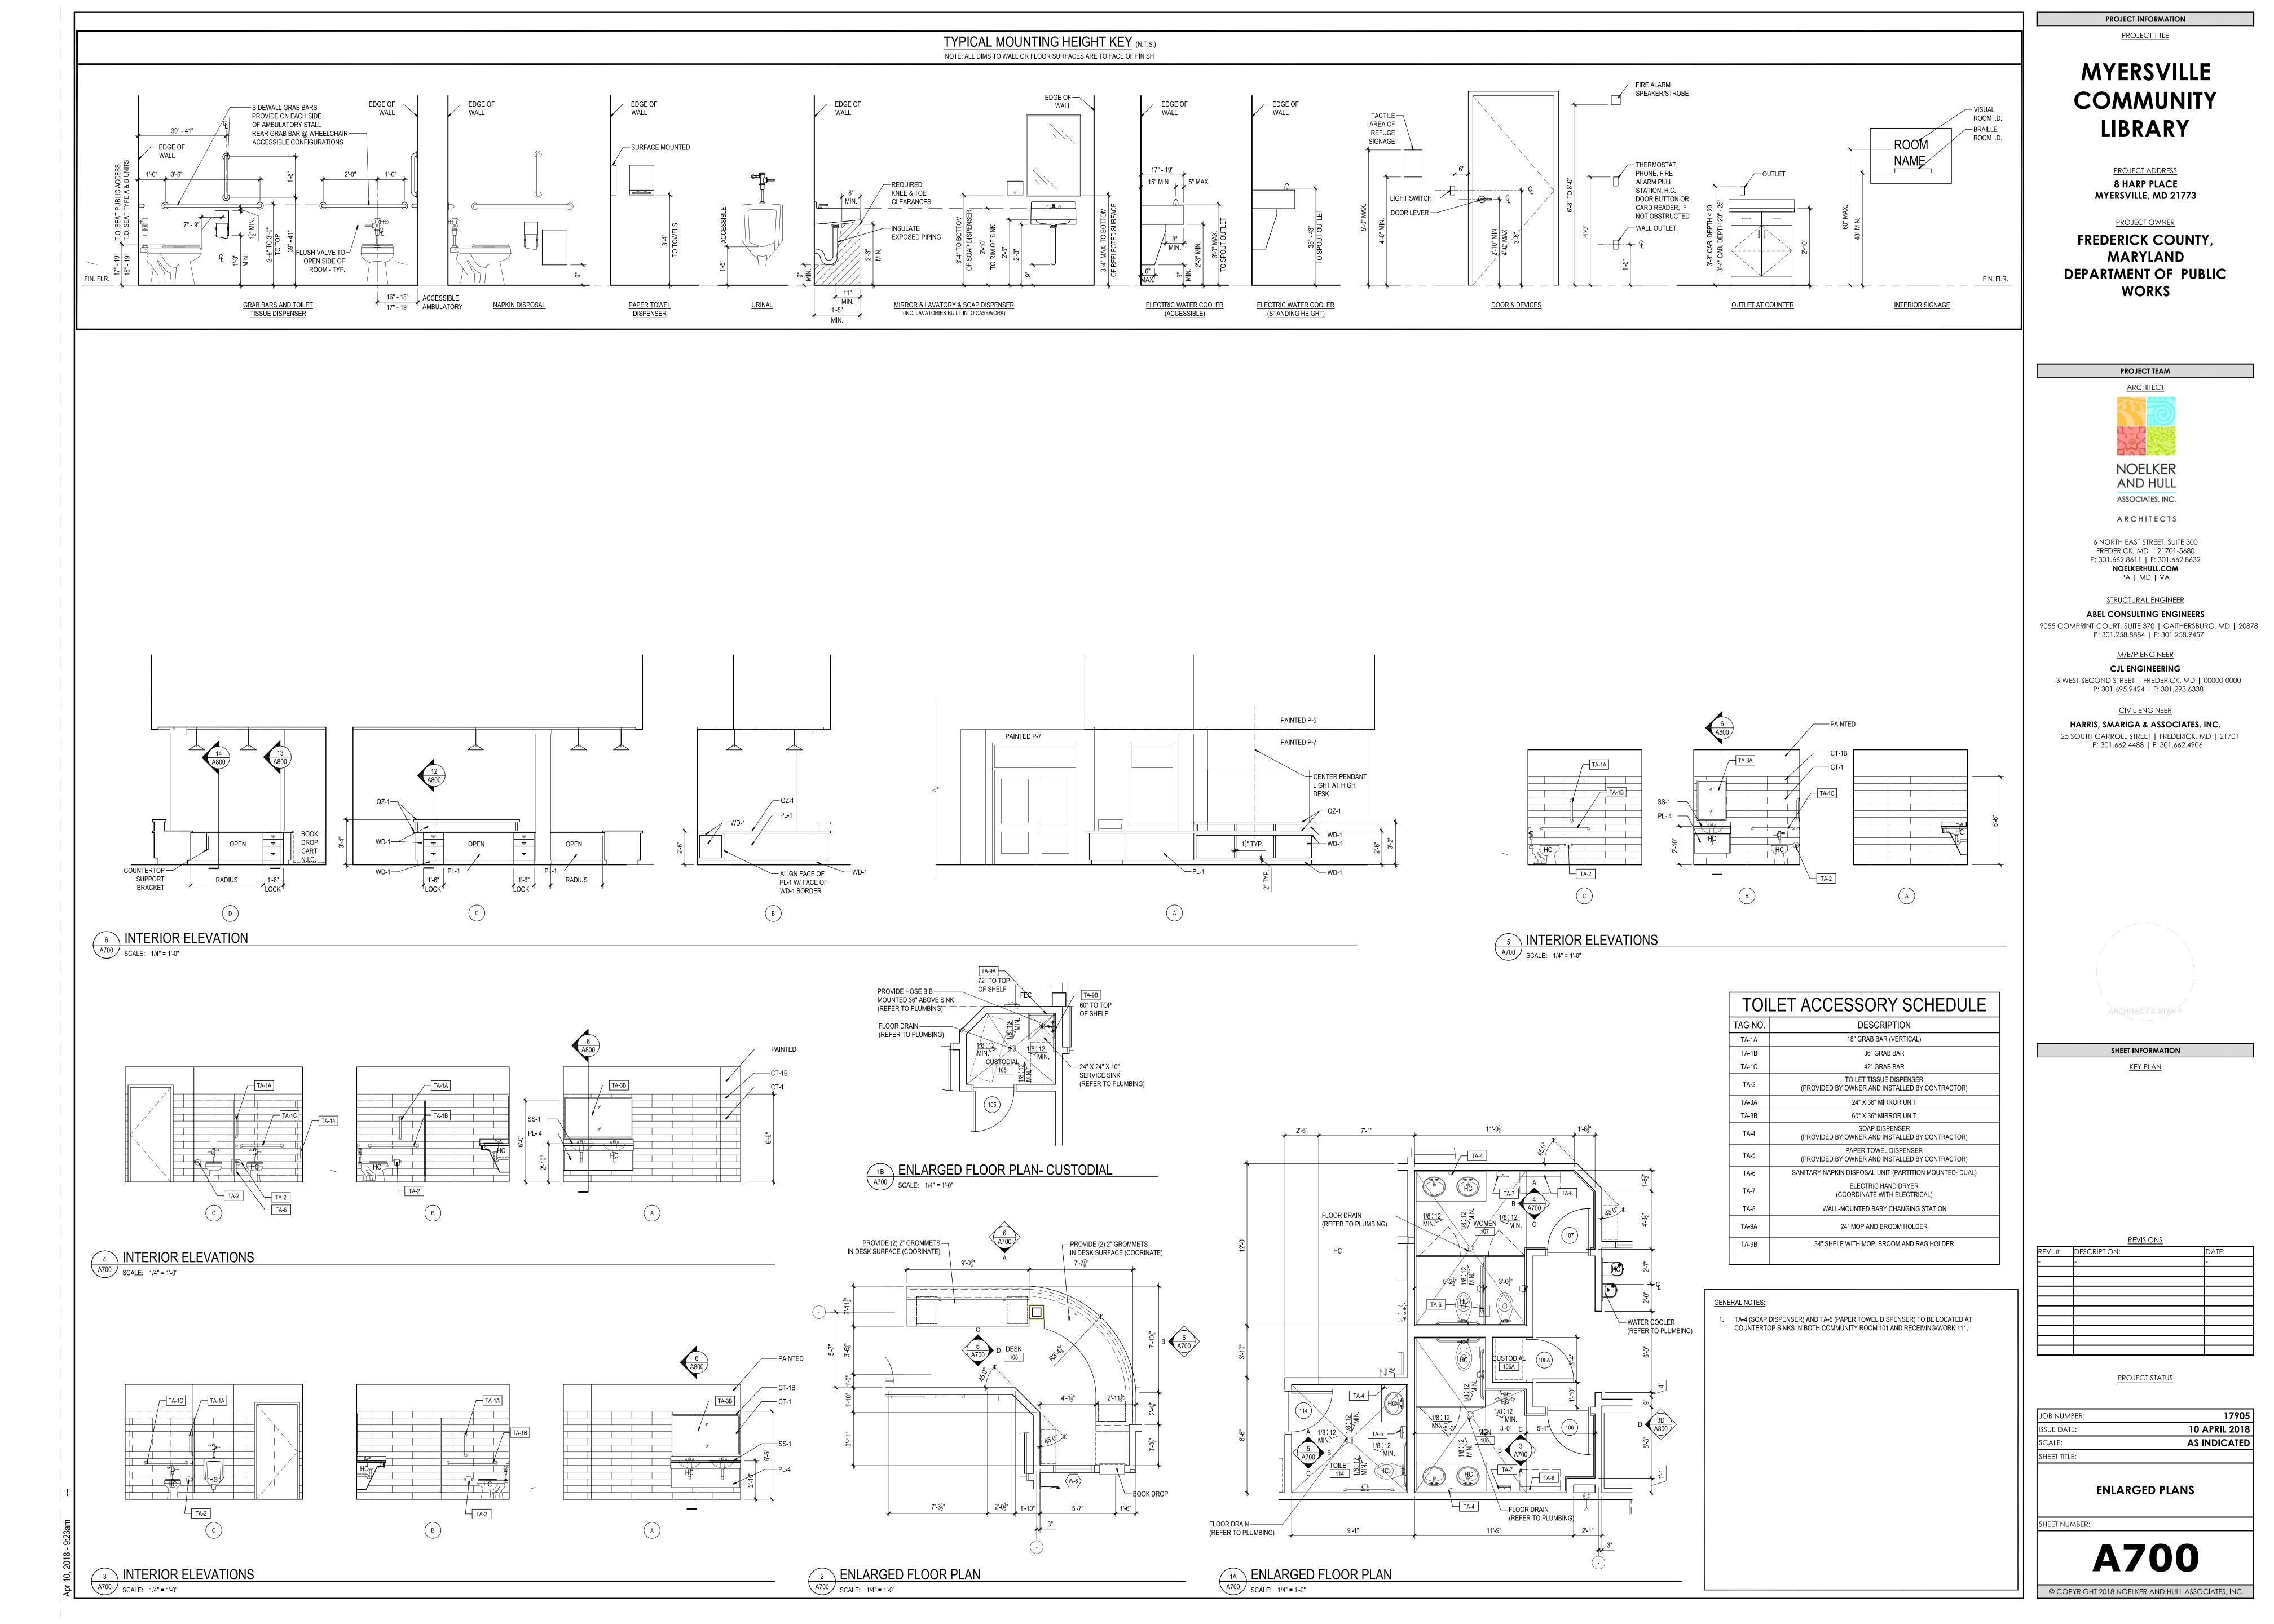

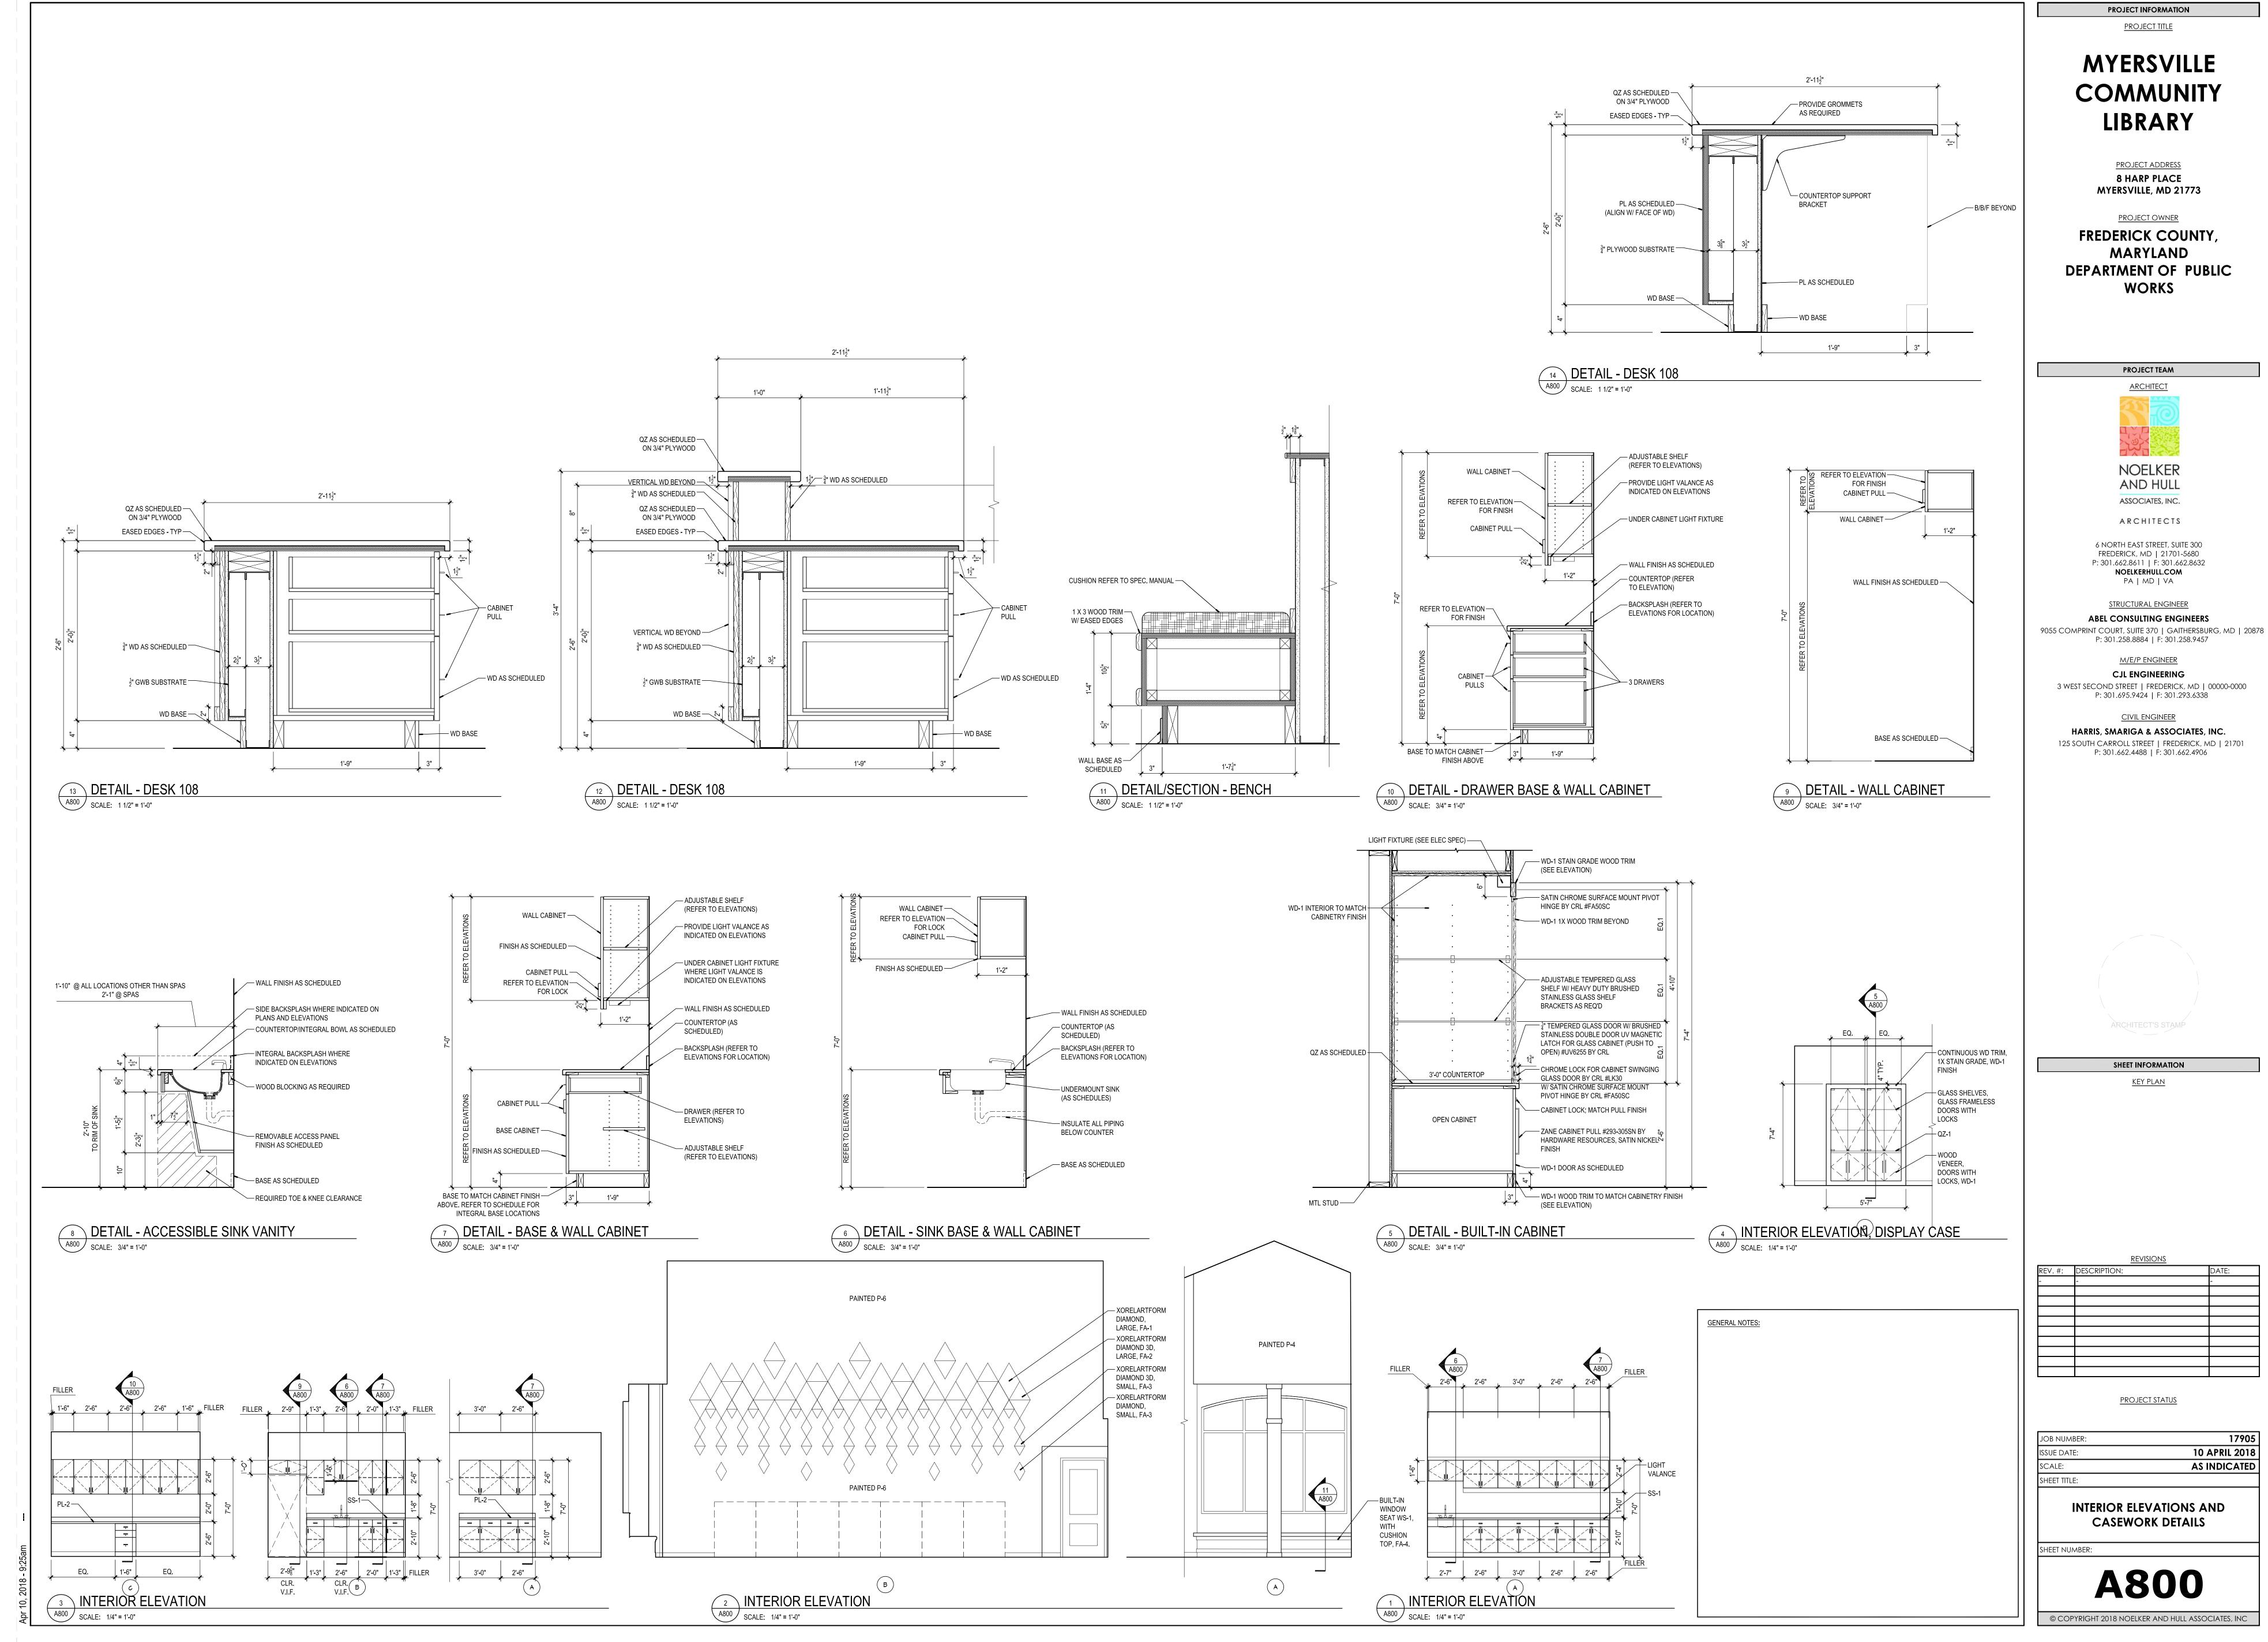

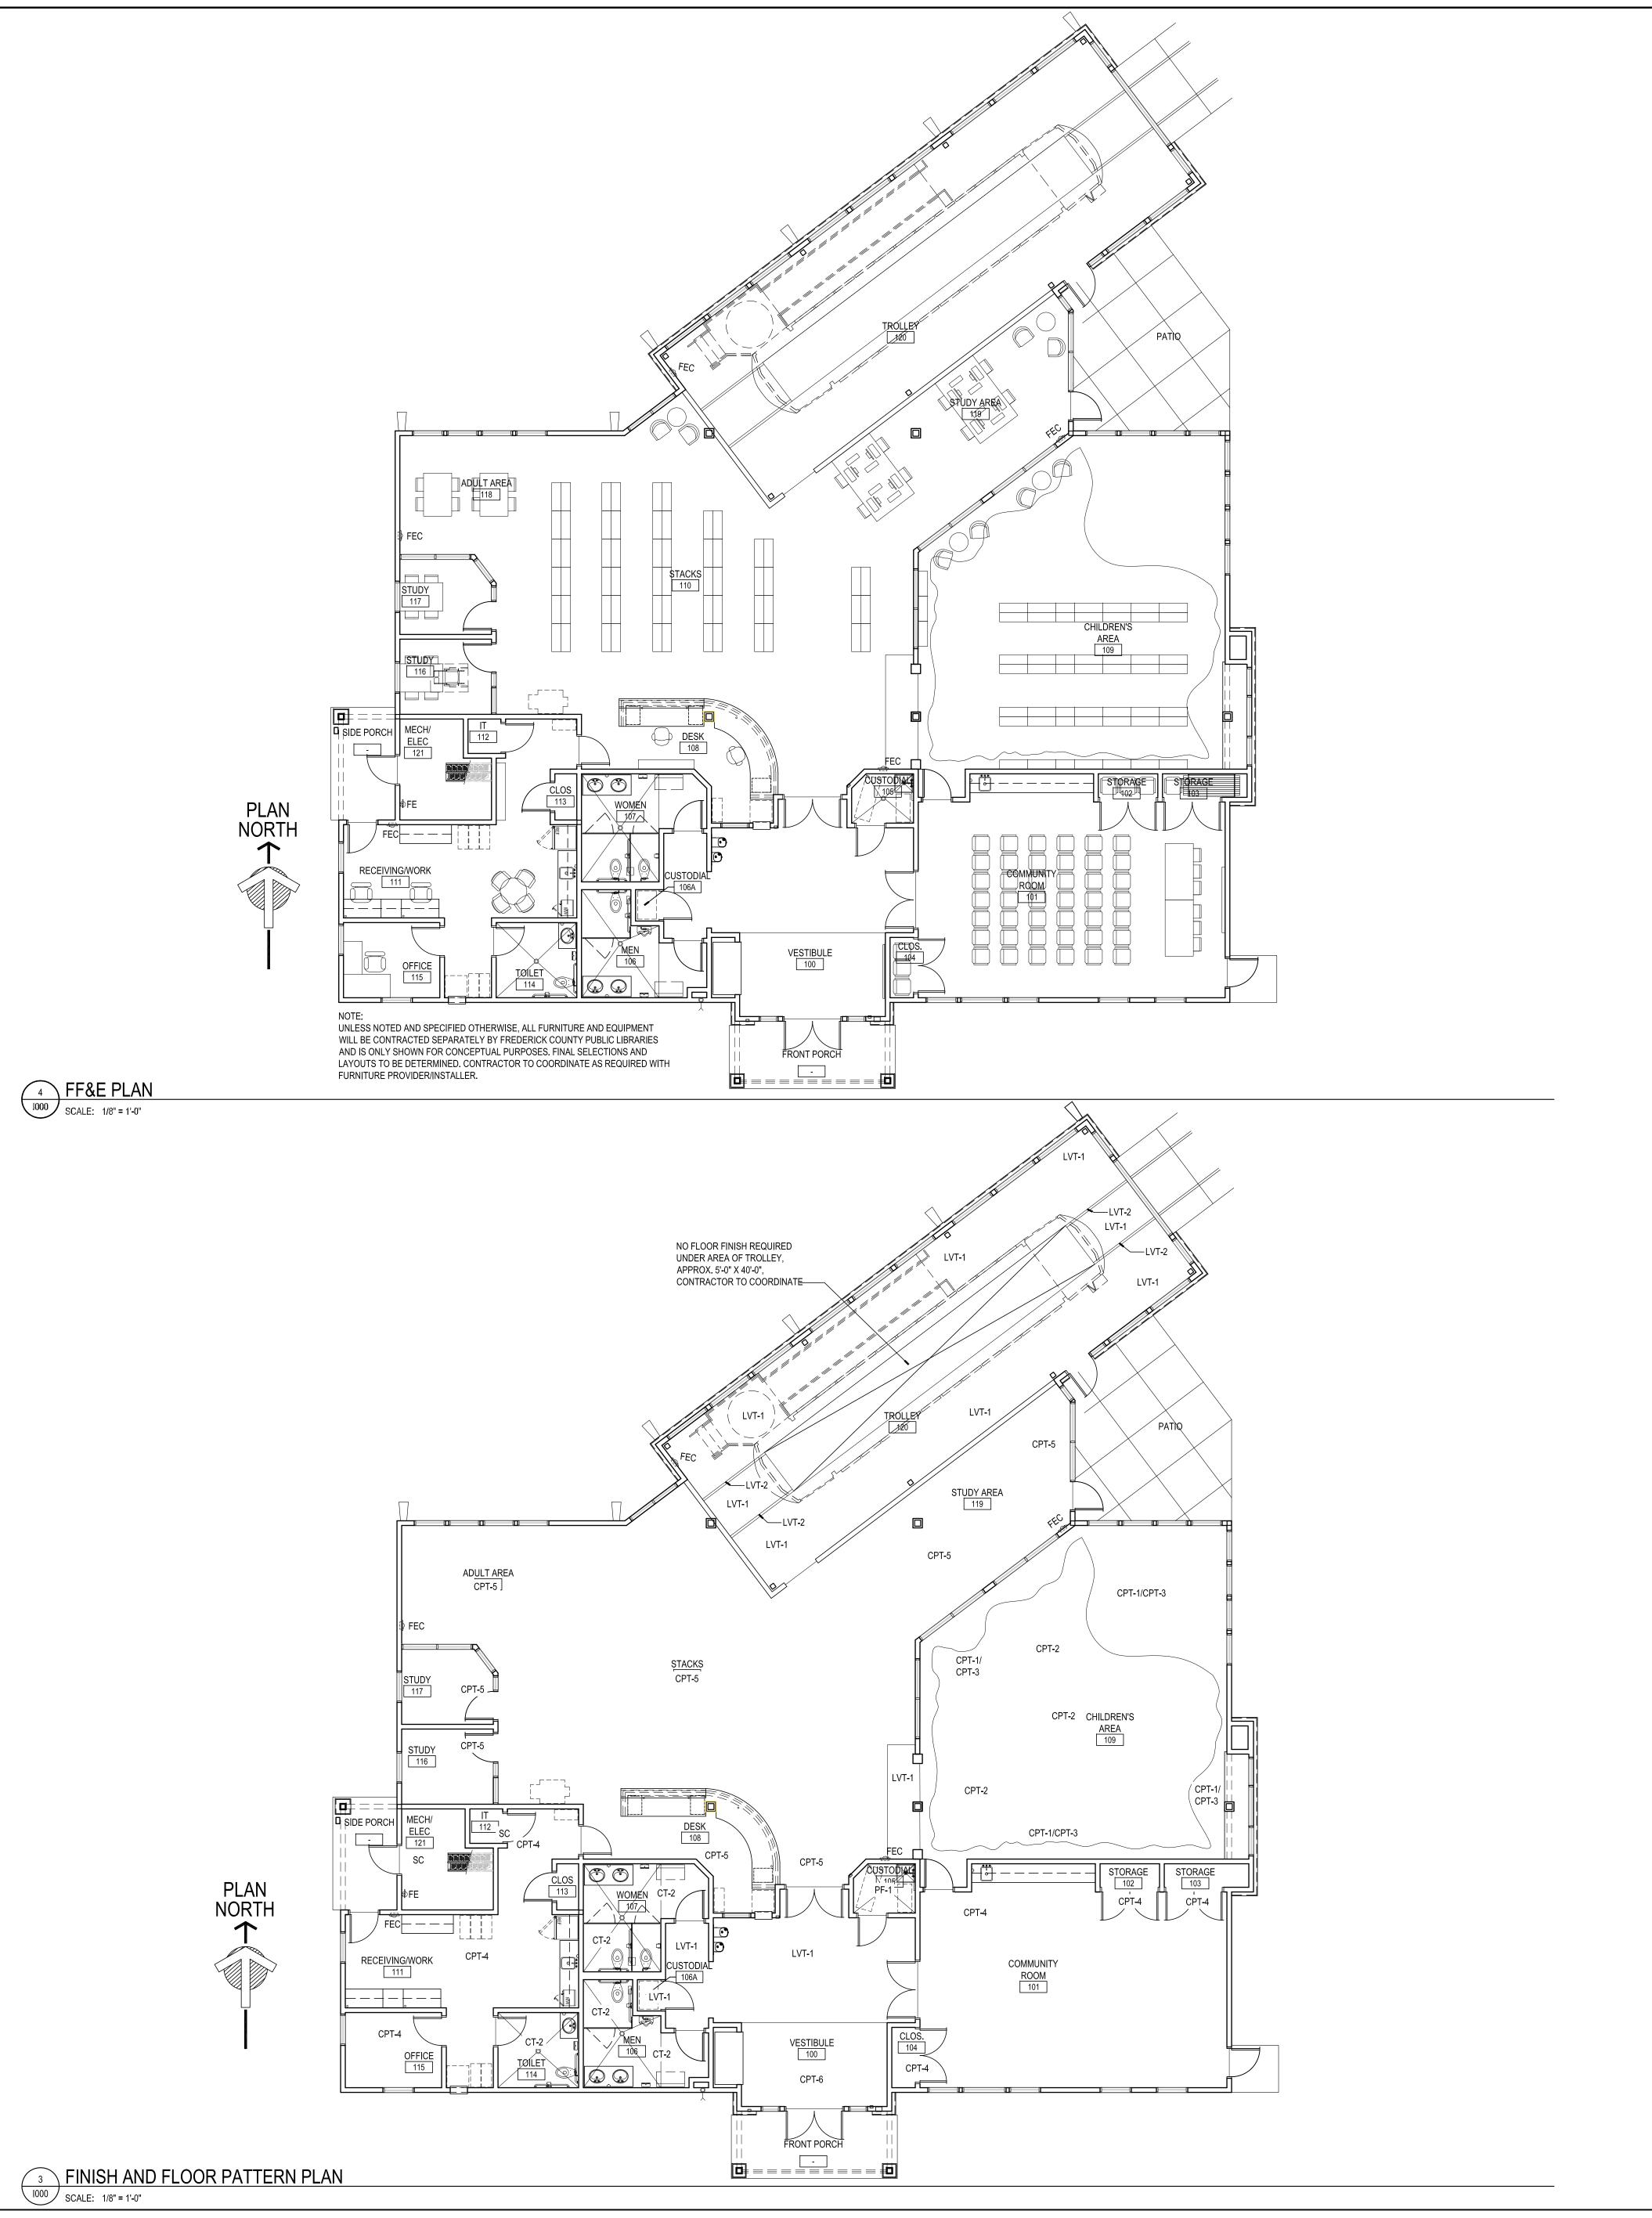

			FINISH KEY		
ITEM	SYMBOL	MFR	PRODUCT NAME, #, & COLOR	SPECIFICS	REMARKS
064113- WC	OD VENEER- FA	CED ARCHITECTURAL CABINET	rs		
	WD-1	CUSTOM STAIN FINISH	MATCH ARCHITECT'S SAMPLE ON MAPLE		
064116/1236	52.31- PLASTIC	LAMINATE- FACED ARCHITECT	URAL CABINETS/PLASTIC LAMINATE COUNTERTOPS		
PLASTIC LAN	/INATE (PL)				
	PL-1	WILSONART	#L6455 (408) Hot Tin Roof		
	PL-2	FORMICA	6317-34 Weathered Cement, Scovato Finish		
	PL-3	FORMICA	1150-58 Vosges Pear, Matte Finish		
	PL-4	WILSONART	7850-60 Beigewood, Matte Finish		
093000- TILE					
CERAMIC TIL					
		CDOSSVILLE	NEST COLOR: AV262 BLISSELLI OLIVE SIZE: 6" V 26" Thickness: 10 Emm	Loint Width: 2/16"	Wall tile a installed 26" long side in the horzy direction. Brick Battern
	CT-1	CROSSVILLE	NEST, COLOR: AV363 BLISSFUL OLIVE, SIZE: 6" X 36", Thickness: 10.5mm	Joint Width: 3/16"	Wall tile e installed 36" long side in the horz. direction, Brick Pattern
	CT-1B	CROSSVILLE	NEST, COLOR: AV363 BLISSFUL OLIVE, SIZE: 6" X 18", Thickness: 10.5mm	Joint Width: 3/16"	Wall tile bullnose trim
			NEST, COLOR: NBC02, JOYOUS OAK AMD OLIVE MIX, SIZE: 1" X 6" MOSAIC,		
	CT-2	CROSSVILLE	Thickness: 10.5 mm	Joint Width: 3/16"	Floor Tile
				,	
	OUSTICAL CEILIN				
ACOUSTICAL		ACT)/ CEILING SYSTEM (C-1)			
	ACT-1 ACT-2		ULTIMA 1951, 15/16" GRID, BEVELED TEGULAR, SIZE: 24" X 24" X 3/4" CERAMAGUARD FINE FISSURED 607, 15/16" GRID, SIZE: 24" X 24" X 5/8"		
	C-1	ARMSTRONG COMMERCIAL	WOODWORKS, LINEAR, VENEERED PLANKS, 6" MODULE WOOD FINISH: CHERRY CCY		
	C-2	ARMSTRONG COMMERCIAL	WOODWORKS, CONCEALED, 5983/W-2, WOOD FINISH: CHERRY CCY SIZE: 24" x 48"		
	ILIENT FLOORIN	G (LVT)			
LUXURY VIN	YL TILE LVT-1	MOLIAWIK CROLLD	LIOT AND LIFAVAY MIXED COLID. Colors 700 Integrate	Tile Size: 36" x 36"	
	LV1-1	MOHAWK GROUP	HOT AND HEAVY, MIXED SOLID, Color: 768 Integrate	The size, so x so	
	LVT-2	MOHAWK GROUP	HOT AND HEAVY, LINEATE, Color: 868 Groove	Plank Size: 9" x 59"	
096500- RFS	II IFNT BASE AN	D ACCESSORIES RUBBER BASE	Π		
	RB-1	JOHNSONITE	TRADITIONAL WALL BASE, 4" H. COLOR: 79 BONE WHITE		
		N= 41			
096700- EPO	XY FLOORING (I	SHERWIN WILLIAMS	GENERAL POLYMERS, CERAMIC CARPET #400, COLOR: MOUNTAIN SAGE		
		SHERWIN WILLIAMS	dentitive i definition, delivative draw er i i i i i i i i i i i i i i i i i i		
	CARPETING				
CARPET TILE					
	CPT-1	INTERFACE	URBAN RETREAT, UR101, 12711025H, COLOR: 103505 FLAX/GRASS	INSTALLATION METHOD: NON-DIRECTION	
	CPT-2 CPT-3	INTERFACE INTERFACE	URBAN RETREAT, UR102, 127100250H, COLOR: FLAX URBAN RETREAT, UR103, 1271202500, COLOR: GRASS	INSTALLATION METHOD: NON-DIRECTION INSTALLATION METHOD: NON-DIRECTION	
	CPT-3 CPT-4	INTERFACE	URBAN RETREAT, UR303, 126990250H, COLOR: 102971 FLAX	INSTALLATION METHOD: NON-DIRECTION INSTALLATION METHOD: MONOLITHIC	•
	CPT-5	INTERFACE	GATHER, FIRST OPTION, 19DR402500, COLOR: 180781 OREGANO ACCENT	INSTALLATION METHOD: QUARTER TURN	
	CPT-6	SHAW CONTRACT	PATH TILE, 5T034, COLOR: 34761 PORTABELLA	INSTALLATION METHOD: MONOLITHIC	
099100- PAII	NTS (P)				
	P-1	SHERWIN WILLIAMS	SW9110 MALBAR		
	P-2	SHERWIN WILLIAMS	SW9112 SONG THRUSH		
	P-3	SHERWIN WILLIAMS	SW9109 NATURAL LINEN		
	P-4	SHERWIN WILLIAMS	SW6416 SASSY GREEN		
	P-5	SHERWIN WILLIAMS	SW6417 TUPELO TREE		
	P-6	SHERWIN WILLIAMS	SW6657 AMBER WAVE		
	P-7	SHERWIN WILLIAMS	SW7703 EARTHEN JUG		

FINISH LEGEND
SCALE: NONE

123661.19- QUARTZ AGGLOMERATE COUNTERTOPS

QZ-1 CAMBRIA/ZODIAQ??? COLOR: ????

COLOR: COTTAGE LANE

FINISH SCHEDULE									
	SPACE	FLO	OR		WA	LLS		CEILING MATERIAL	
ROOM#	NAME	FLOORING	BASE	NORTH WALL	EAST WALL	SOUTH WALL	WEST WALL		REMARKS
-	FRONT OF BUILDING	-	-	-	-	-	-	-	
-	FRONT OF BUILDING	-	-	-	-	-	-	-	
-	SIDE PORCH	-	-	-	-	-	-	-	
-	FRONT PORCH	-	-	-	-	-	-	-	
100	VESTIBULE	-	-	-	-	-	-	-	
100	VESTIBULE	-	-	-	-	-	-	-	
100	VESTIBULE	CPT-6/LVT-1	RB-1	P-1	P-1	P-1	P-1	P-3	
101	COMMUNITY ROOM	CPT-4	RB-1	P-1	P-1	P-5	P-1	C-2 / P-3	6
102	STORAGE	CPT-4	RB-1	P-1	P-1	P-1	P-1	P-1	
103	STORAGE	CPT-4	RB-1	P-1	P-1	P-1	P-1	P-1	
104	CLOS.	CPT-4	RB-1	P-1	P-1	P-1	P-1	P-1	
105	CUSTODIAL	PF-1	PF-1	PF-1/P-1	PF-1/P-1	PF-1/P-1	PF-1/P-1	P-3	
106	MEN	CT-2	CT-1	CT-1/CT-1B / P-1	CT-1/CT-1B / P-1	CT-1/CT-1B / P-1	CT-1/CT-1B / P-1	P-3	1
106A	CUSTODIAL	SEAL. CONC.	RB-1	P-1	P-1	P-1	P-1	P-3	
107	WOMEN	CT-2	CT-1	CT-1/ CT-1B / P-1	CT-1/CT-1B / P-1	CT-1/CT-1B / P-1	CT-1/CT-1B / P-1	P-3	1
108	DESK	-	-	-	-	-	1	-	
108	DESK	-	-	-	•	-	-	-	
108	DESK	CPT-5	RB-1	-	P-1	P-1	P-1	C-1/P-1/P-5	2, 4
109	CHILDREN'S AREA	CPT-1, 2, 3/LVT-1	RB-1	P-1	P-1	P-4	P-6	C-1	
110	STACKS	CPT-5/LVT-1	RB-1	P-1	P-2	P-7	P-7	C-1	5
111	RECEIVING/WORK	-	-	-	-	-	-	-	
111	RECEIVING/WORK	-	-	-	-	-	-	-	
111	RECEIVING/ WORK	-	-	-	-	-	-	-	
111	RECEIVING/WORK	CPT-4	RB-1	P-1	P-1	P-1	P-1	ACT-1	3
112	IT	CPT-4	RB-1	P-1	P-1	P-1	P-1	P-1	
113	CLOS	CPT-4	RB-1	P-1	P-1	P-1	P-1	P-1	
114	TOILET	CT-2	CT-1	CT-1/CT-1B/ P-1	CT-1/CT-1B/ P-1	CT-1/CT-1B/ P-1	CT-1/CT-1B/ P-1	P-3	1
115	OFFICE	CPT-4	RB-1	P-1	P-1	P-1	P-1	ACT-1	
116	STUDY	CPT-5	RB-1	P-1	P-1	P-1	P-7	ACT-1	
117	STUDY	CPT-5	RB-1	P-1	P-1	P-1	P-7	ACT-1	
118	ADULT AREA	CPT-5	RB-1	P-1	-	P-1	P-7	C-1	
119	STUDY AREA	CPT-5	RB-1	P-1	P-1	P-1	P-1	P-3	5
120	TROLLEY	LVT-1/LVT-2	RB-1	P-2	P-2	P-2	P-2	P-1	
121	MECH/ ELEC	SEAL. CONC.	RB-1	P-1	P-1	P-1	P-1	P-3	
121	MECH/ ELEC	-	-	-	-	-	-	-	
200	MECHANICAL LOFT	-	-	-	-	-	-	-	
200	MECHANICAL LOFT	-	-	-	-	-	-	-	

ABBREVIATIONS

PL PLASTIC LAMINATE

QZ QUARTZ

WD WOOD

RB RUBBER BASE

SS SOLID SURFACE

1. VANITY SHALL BE SS-1/ PL-4 VANITY BASE.

4. COUNTERTOP SHALL BE QZ-1. CABINETS SHALL BE PL-1/WD-1.

6. COUNTERTOP SHALL BE SS-2, CABINETS SHALL BE PL-3.

FINISH NOTES

2. PAINT FRONT OF THE CEILING BULKHEAD P-5. PAINT UNDERSIDE OF THE CEILING BULKHEAD P-3.

5. PAINT FRONT OF THE CEILING BULKHEAD P-5. PAINT UNDERSIDE OF THE CEILING BULKHEAD P-3.

3. COUNTERTOP SHALL BE PL-2, COUNTERTOPS AT KITCHENETTE SHALL BE SS-2, CABINETS SHALL BE PL-3.

ACT ACOUSTICAL CEILING TILE P PAINT C CEILING SYSTEM

PF EPOXY POURED FLOOR

CPT CARPET TILE CT CERAMIC TILE

LVT LUXARY VINYL TILE

GENERAL NOTES

B. REFER TO SHEET 1000 FOR FLOOR FINISH LOCATIONS. C. PAINT DIFFUSERS LOCATED AT WALLS AND CEILINGS TO MATCH ADJACENT WALL OR CEILING FINISH/COLOR, TYPICAL. D. CARRY FLOOR FINISH CONTINUOUS UNDERNEATH SINK BASE, TYPICAL.

E. PAINT FIRE EXTINGUISHER CABINET EXTERIOR TRIM AND DOOR TO MATCH ADJACENT WALL PAINT COLOR, TYPICAL. F. PF-1 SHALL BE 4'-0" H. WAINSCOT ON THE WALLS AS INDICATED. P-1 PAINTED ABOVE THE WAINSCOT.

A. WOOD DOORS SHALL BE STAINED WD-1, DOOR FRAMES, AND TRIM SHALL BE PAINTED P-2, TYPICAL.

FINISH SCHEDULE

SCALE: NONE

PROJECT INFORMATION PROJECT TITLE

MYERSVILLE COMMUNITY LIBRARY

PROJECT ADDRESS **8 HARP PLACE** MYERSVILLE, MD 21773

PROJECT OWNER FREDERICK COUNTY, **MARYLAND** DEPARTMENT OF PUBLIC **WORKS**

PROJECT TEAM

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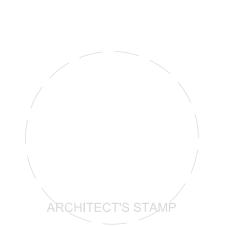
ARCHITECTS

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CIVIL ENGINEER HARRIS, SMARIGA & ASSOCIATES, INC. 125 SOUTH CARROLL STREET | FREDERICK, MD | 21701 P: 301.662.4488 | F: 301.662.4906




SHEET INFORMATION <u>KEY PLAN</u>

PROJECT STATUS

JOB NUMBER: 17905 ISSUE DATE: 10 APRIL 2018 AS INDICATED SHEET TITLE: FINISH SCHEDULE AND FINISH PLANS SHEET NUMBER:

I000

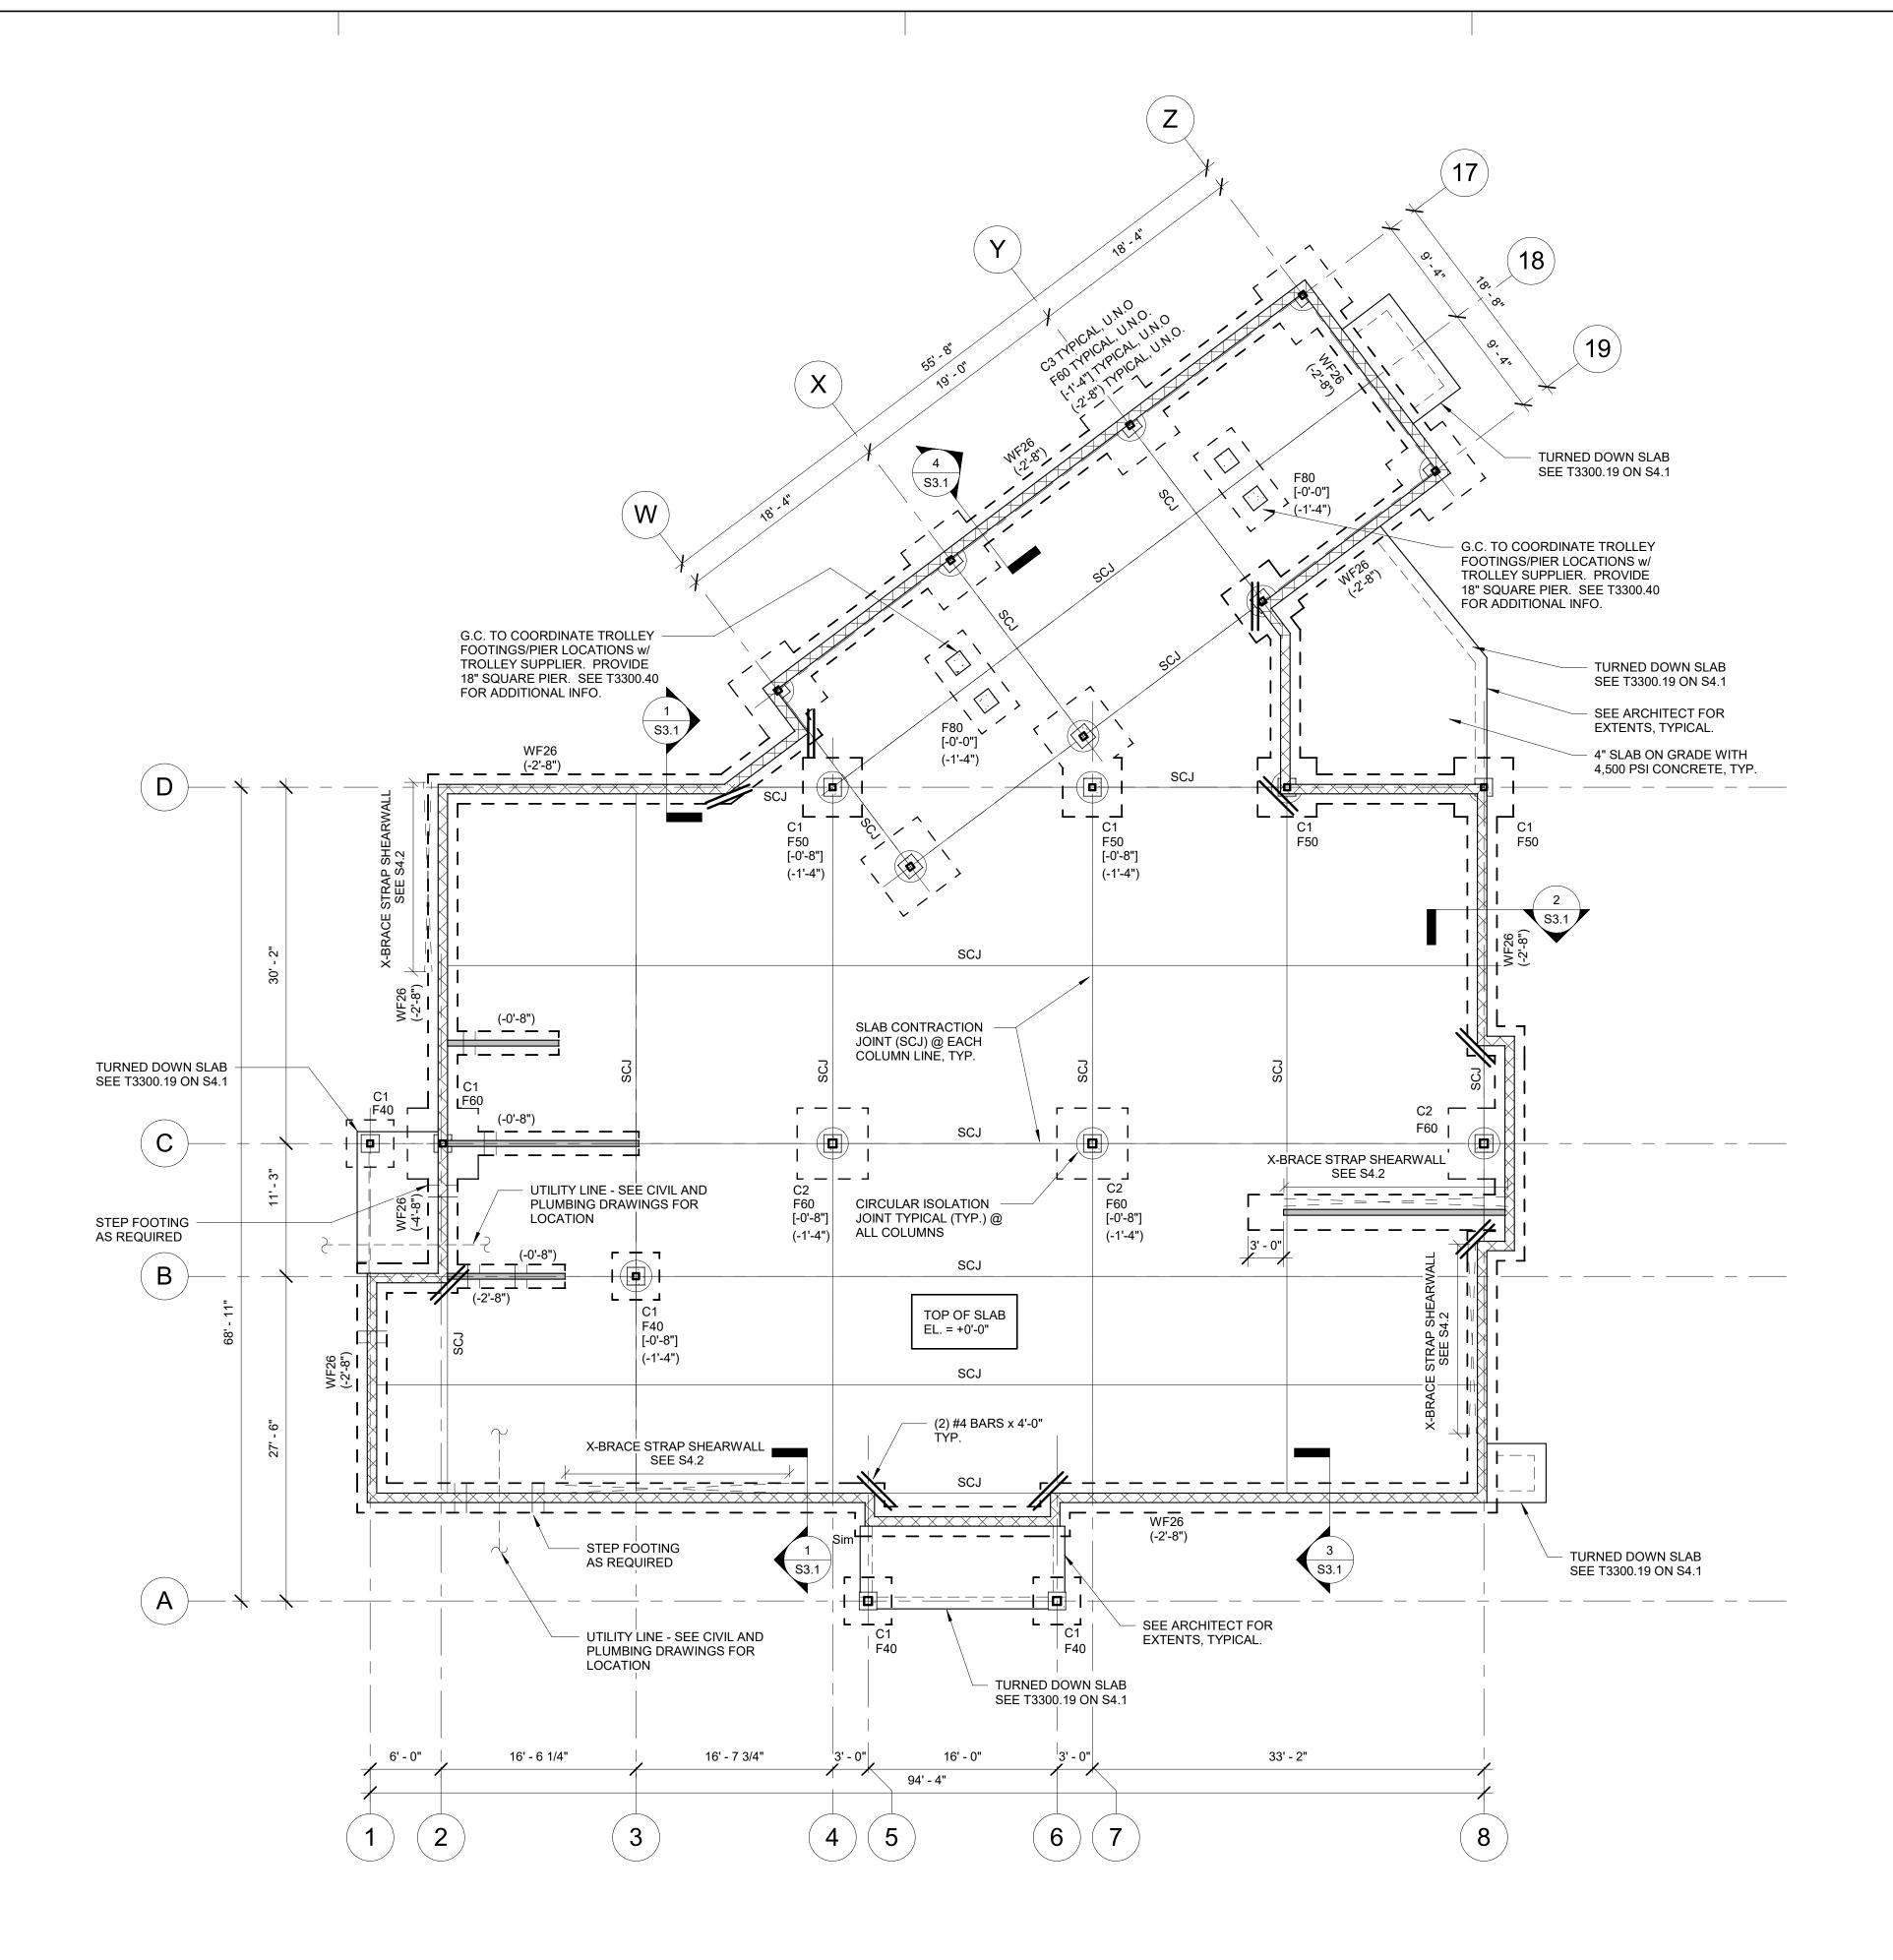

FOUNDATION PLAN

1/8" = 1'-0"

FLOOR AND LOW ROOF NOTES:

1. SLAB ON GRADE SHALL BE 4" NORMAL WEIGHT CONCRETE (F'C=3000 PSI, 145 PCF) WITH 6"X6"-W1.4XW1.4 WELDED WIRE FABRIC OVER VAPOR BARRIER OVER 4" OF COMPACTED WASHED GRAVEL. SUBGRADE TO BE BPREPARED IN ACCORDANCE WITH THE GEOTECHNICAL RECOMMENDATIONS.

2. TOP OF SLAB ELEVATION 680.1' UNLESS NOTED OTHERWISE.

3. [-0'-0"] DENOTES TOP OF PIER ELEVATION MEASURED FROM TOP OF SLAB ON GRADE ELEVATION 680.1'.

4. (-0'-0") DENOTES TOP OF FOOTING ELEVATION MEASURED FROM TOP OF SLAB ON GRADE ELEVATION 680.1'. FOOTING ELEVATIONS ARE FOR BIDDING PURPOSES ONLY AND MAY HAVE TO BE ADJUSTED BASED ON FIELD CONDITIONS ENCOUNTERED DURING EXCAVATION.

5. ALL FOOTINGS SHALL BE LOWERED TO BEAR BELOW ANY UTILITIES. SEE TYPICAL DETAIL.

6. REFER TO THE ARCHITECTURAL, MECHANICAL, PLUMBING, ELECTRICAL, CIVIL DRAWINGS FOR BELOW GRADE UTILITIES, BELOW GRADE CONDUITS, SLAB DEPRESSIONS, ETC.

8. SCJ DENOTES SLAB CONTRACTION JOINT. SEE TYPICAL DETAILS.

7. ALL SUBGRADE PREPARATION FOR THE SLAB ON GRADE, FOOTINGS, INSTALLATION OF CONTROLLED FILL, ETC SHALL BE IN ACCORDANCE WITH THE PROJECT GEOTECHNICAL ENGINEER'S RECOMMENDATIONS.

FO	FOOTING SCHEDULE										
FOOTING NOTATION	SIZE (LxW)	THICKNESS	REINFORCEMENT (EACH WAY) BOTTOM								
F40	4'-0"x4'-0"	12"	(5)#4 BARS								
F50	5'-0"x5'-0"	12"	(6)#6 BARS								
F60	6'-0"x6'-0"	12"	(7)#6 BARS								
F80	8'-0"x4'-0"	12"	#5 @ 12" o.c.								

TOP REINFORCEMENT TO BE #4 BARS @ 12" O.C. EACH

WALL FOOTING SCHEDULE			
MARK	WIDTH (FT)	THICKNESS (FT)	REINFORCEMENT (LONGITUDINAL)
WF26	2'-6"	1'-0"	(3)#5 BARS

NOTE: WALLS CENTERED ON WALL FOOTINGS.

COLUMN SCHEDULE		
MARK	COLUMN SIZE	
C1	HSS 6X6X3/8	
C2	HSS 8X8X3/8	
C3	HSS 6X6X1/2	



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Structural Design

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PROJECT INFORMATION

PROJECT TITLE

MYERSVILLE COMMUNITY LIBRARY

PROJECT ADDRESS

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Myersville, MD 21773

PROJECT OWNER

FREDERICK COUNTY,
MARYLAND DEPARTMENT OF
PUBLIC WORKS

PROJECT TEAM



NOELKER AND HULL

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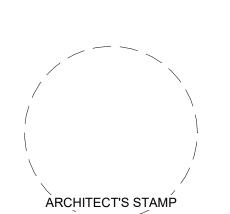
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<u>CIVIL ENGINEER</u>

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SHEET INFORMATION

KEY PLAN

REV. #: DESCRIPTION: DATE:


PROJECT STATUS

JOB NUMBER: 17059
ISSUE DATE: 10 APRIL 2018
SCALE: 1/8" = 1'-0"
SHEET TITLE:

FOOTING AND FOUNDATION

SHEET NUMBER:

S1.1

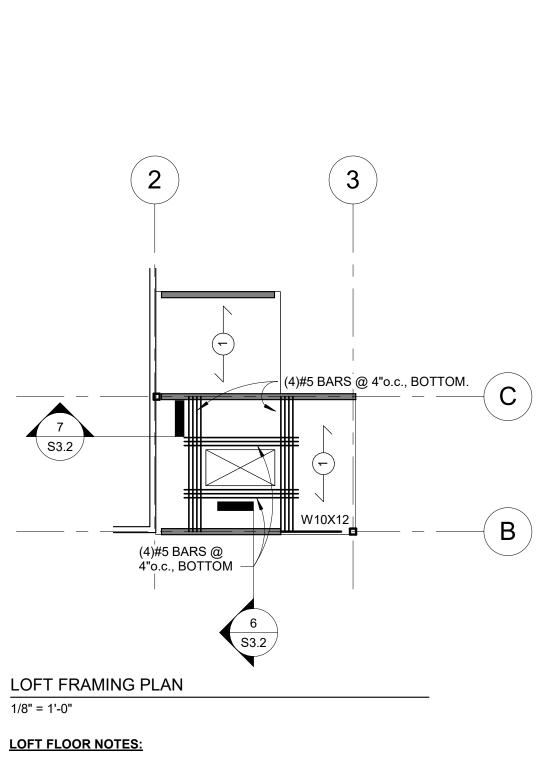


LOFT FLOOR NOTES:

1. FLOOR SYSTEM SHALL BE 6" NORMAL WEIGHT CONCRETE (F'C = 4000 PSI, 145 PCF) WITH 6"X6" W2.1XW2.1 WWF ON 22 GAGE 2" DOVE TAIL (FLAT BOTTOM) METAL DECK-SHORED CONSTRUCTION. TOTAL SLAB THICKNESS SHALL BE 6" UNLESS NOTED

2. TOP OF LOFT FLOOR SLAB ELEVATION IS PER THE ARCHITECT. SEE ARCHITECTURAL DRAWINGS FOR FLOOR SLAB ELEVATIONS.

3. COORDINATE ALL OPENINGS THROUGH DECK WITH ARCHITECTURAL, MECHANICAL, ELECTRICAL AND PLUMBING DRAWINGS. FRAME ALL SLAB OPENINGS WITH REINFORCING BARS PER TYPICAL DETAILS. AT EDGE OF ACCESS OPENING, PROVIDE L6X4X3/8 ANGLE WITH 1/2" DIA. X 6" LONG HEADED STUDS AT 16" O.C.

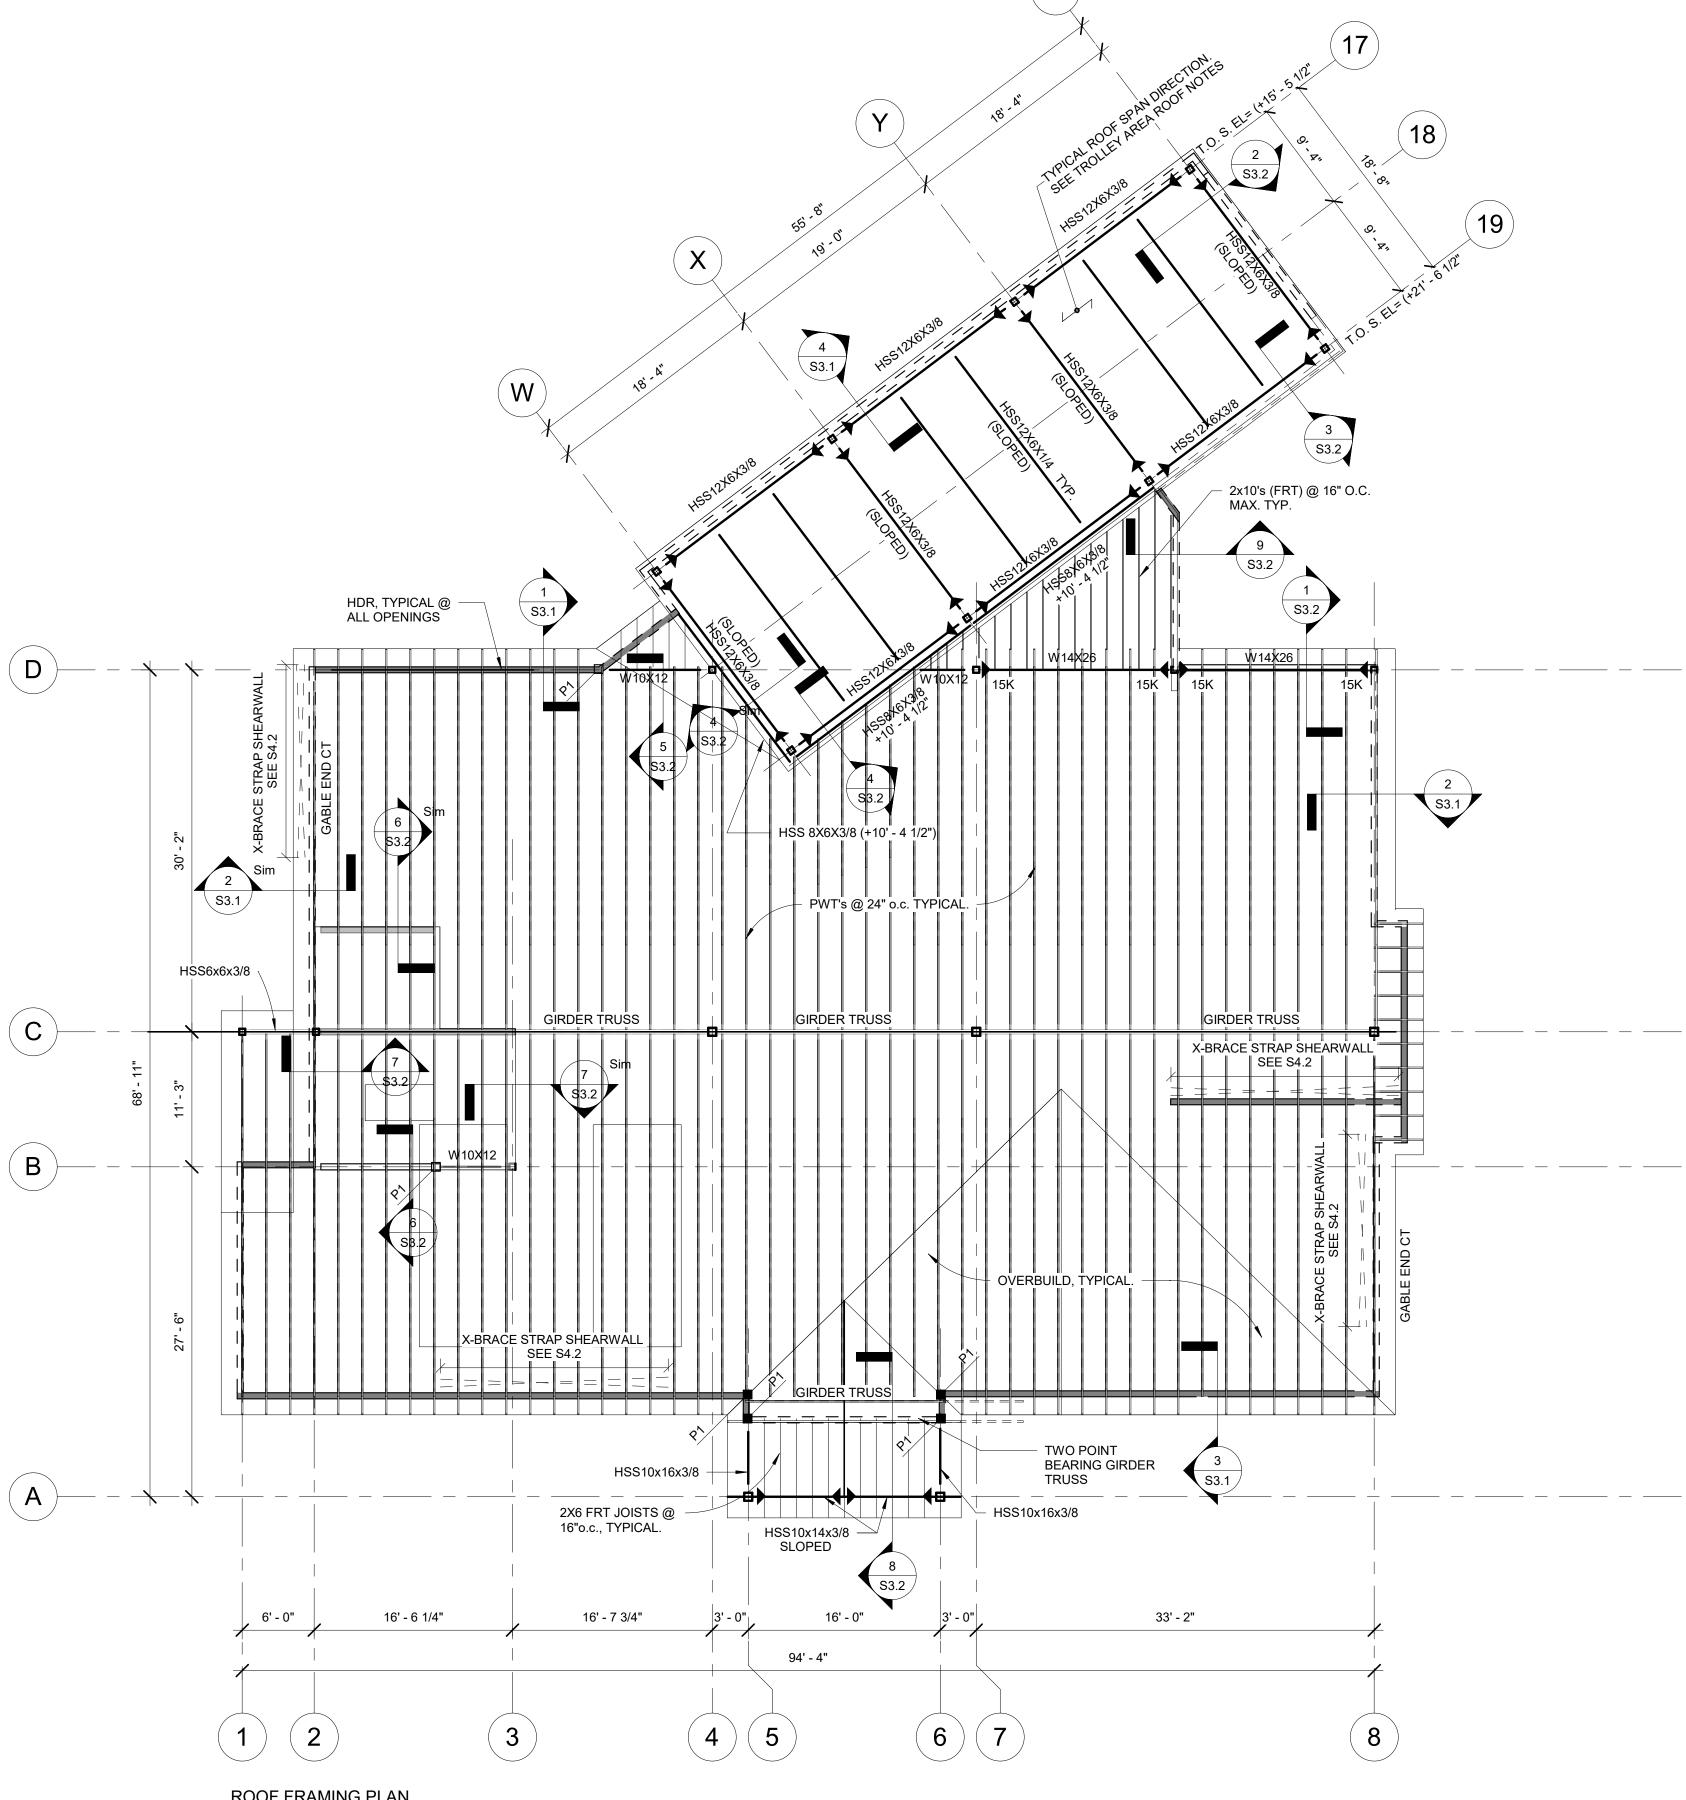

ROOF FRAMING PLAN

1/8" = 1'-0"

ROOF NOTES:

1. SEE ARCHITECTURAL DRAWINGS FOR ROOF SLOPES AND FINISH MATERIAL OVER PLYWOOD. PLYWOOD SHALL BE FRT 19/32" THICK, APA RATED EXTERIOR GRADE, 32/16 SPAN RATING.

2. T.B.E. DENOTES TRUSS BEARING ELEVATION FROM SLAB ON GRADE ELEVATION (0'-0"). T.B.E. = 10'-6" TYP. U.N.O.

3. PWT DENOTES PREFABRICATED FRT WOOD TRUSSES BY THE WOOD TRUSS FABRICATOR. SEE ADDITIONAL TRUSS NOTES ON \$5.1. TRUSS LAYOUT IS CONCEPTUAL. FINAL TRUSS LAYOUT TO BE DETERMINED BY THE ROOF TRUSS SUPPLIER. ALL FRT WOOD TRUSS SHOP DRAWINGS AND CALCULATIONS ARE TO BE SIGNED AND SEALED BY AN ENGINEER REGISTERED IN THE LOCAL JURISDICTION AND DESIGNED FOR THE FOLLOWING MINIMUM LOADS. PREFABRICATED FRT WOOD TRUSS DESIGN SHALL TAKE INTO ACCOUNT ALL UNIFORM AND CONCENTRATED LOADS FROM OTHER FRAMING OR EQUIPMENT SUPPORTED BY THE TRUSSES.

TOP CHORD LIVE LOAD 30 PSF + DRIFTING PER LOCAL CODE REQUIREMENTS DEAD LOAD 15 PSF

BOTTOM CHORD DEAD LOAD 10 PSF

4. ALL NECESSARY FRAMING FOR INFILLS TO CREATE VALLEYS, HIPS, GABLES, ETC., IS TO BE SUPPLIED ALONG WITH ROOF TRUSSES BY ONE SOURCE. GABLES SHALL BE BUILT ON TOP OF TYPICAL TRUSSES TO ENSURE A UNIFORM LOAD ON THE EXISTING STRUCTURE. ANY CONVENTIONAL FRAMING REQUIRED FOR INFILLS SHALL HAVE COMPUTATIONS SIGNED AND SEALED BY AN ENGINEER REGISTERED IN THE LOCAL JURISDICTION.

5. GT DENOTES GABLE END TRUSS.

6. CT DENOTES COLLECTOR TRUSS. COLLECTOR TRUSSES SHALL BE PLACED ABOVE ALL SHEAR WALLS. COLLECTOR TRUSSES SHALL BE DESIGNED FOR LATERAL LOADS AS NOTED ON THE CONTRACT DOCUMENTS. PROVIDE BLOCKING TRUSSES AT ALL SHEAR WALLS THAT ARE PERPENDICULAR TO ROOF TRUSS FRAMING. BLOCKING TRUSSES SHALL BE DESIGNED FOR LATERAL LOADS AS NOTED ON THE CONTRACT DOCUMENTS.

7. TOP OF STEEL IS MEASURED FROM TOP OF FLOOR SLAB BELOW AND IS INDICATED THUS (+0'-0"). ALL TOP OF STEEL ELEVATIONS ARE 10'-4 1/2" ABOVE THE SLAB ON GRADE

8. XXK DENOTES UNFACTORED REACTION OF STEEL BEAMS. REACTIONS ARE 10K U.N.O.

9. SHADED WALLS ARE LOAD BEARING CFS WALLS DESIGNED BY THE SPECIALTY

ENGINEER. DESIGN WALLS FOR 1.5 KLF TOTAL AXIAL LOAD PLUS EXTERIOR COMPONENTS AND CLADDING WIND LOADS.

10. P1 DENOTES CONCENTRATED POINT LOADS FOR CFS STUD POSTS BY THE SPECIALTY

ENGINEER. DESIGN POSTS FOR 9.0 K TOTAL AXIAL LOAD. 11. HDR DENOTES LINTEL DESIGNED BY THE SPECIALTY ENGINEER.

SPECIALTY ENGINEER. SEE S4.2 FOR LOADS AND DETAILS.

12. FOR X-BRACE FLAT STRAPPED CFS SHEAR WALL (STRAPS ONE SIDE ONLY) BY THE

13. ► DENOTES FULL MOMENT CONNECTION. STEEL CONNECTONS ARE DELEGATED DESIGN BY THE STEEL SUPPLIER'S ENGINEER. MOMENT CONNECTIONS ARE TO DEVELOP THE FULL MOMENT CAPACITY OF THE BEAM.

TROLLEY AREA ROOF NOTES:

1. THE SLOPED TROLLEY AREA ROOF SYSTEM SHALL BE AS INDICATED ON THE ARCHITECTURAL DRAWINGS ON 1.5"-22 GAGE TYPE "B" GALVANIZED METAL ROOF DECK BY VULCRAFT OR EQUIVALENT (3 SPAN MINIMUM). ATTACH ROOF DECK TO STEEL SUPPORTS USING A 36/7 PATTERN (EVERY FLUTE WELDED TO STEEL SUPPORT)WITH 2 SIDE LAP FASTENERS.

2. NET UPLIFT FORCES ON THE TROLLEY AREA FRAMED ROOF ARE AS NOTED BELOW. THE METAL DECK SUPPLIER SHALL SUBMIT CALCULATIONS TO DEMONSTRATE THAT THE METAL DECK AND THEIR RESPECTIVE CONNECTIONS MEET A 20 PSF NET UPLIFT.



Consulting Engineers Structural Design 9055 Comprint Court, SUITE 370 301 258 8884 Gaithersburg, Maryland 20877 Email info@ACEPA.net PROJECT INFORMATION PROJECT TITLE

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PROJECT ADDRESS 8 Harp place Myersville, MD 21773

PROJECT OWNER

FREDERICK COUNTY, MARYLAND DEPARTMENT OF **PUBLIC WORKS**

PROJECT TEAM



NOELKER AND HULL

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ASSOCIATES, INC.

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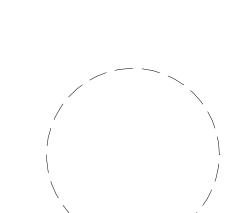
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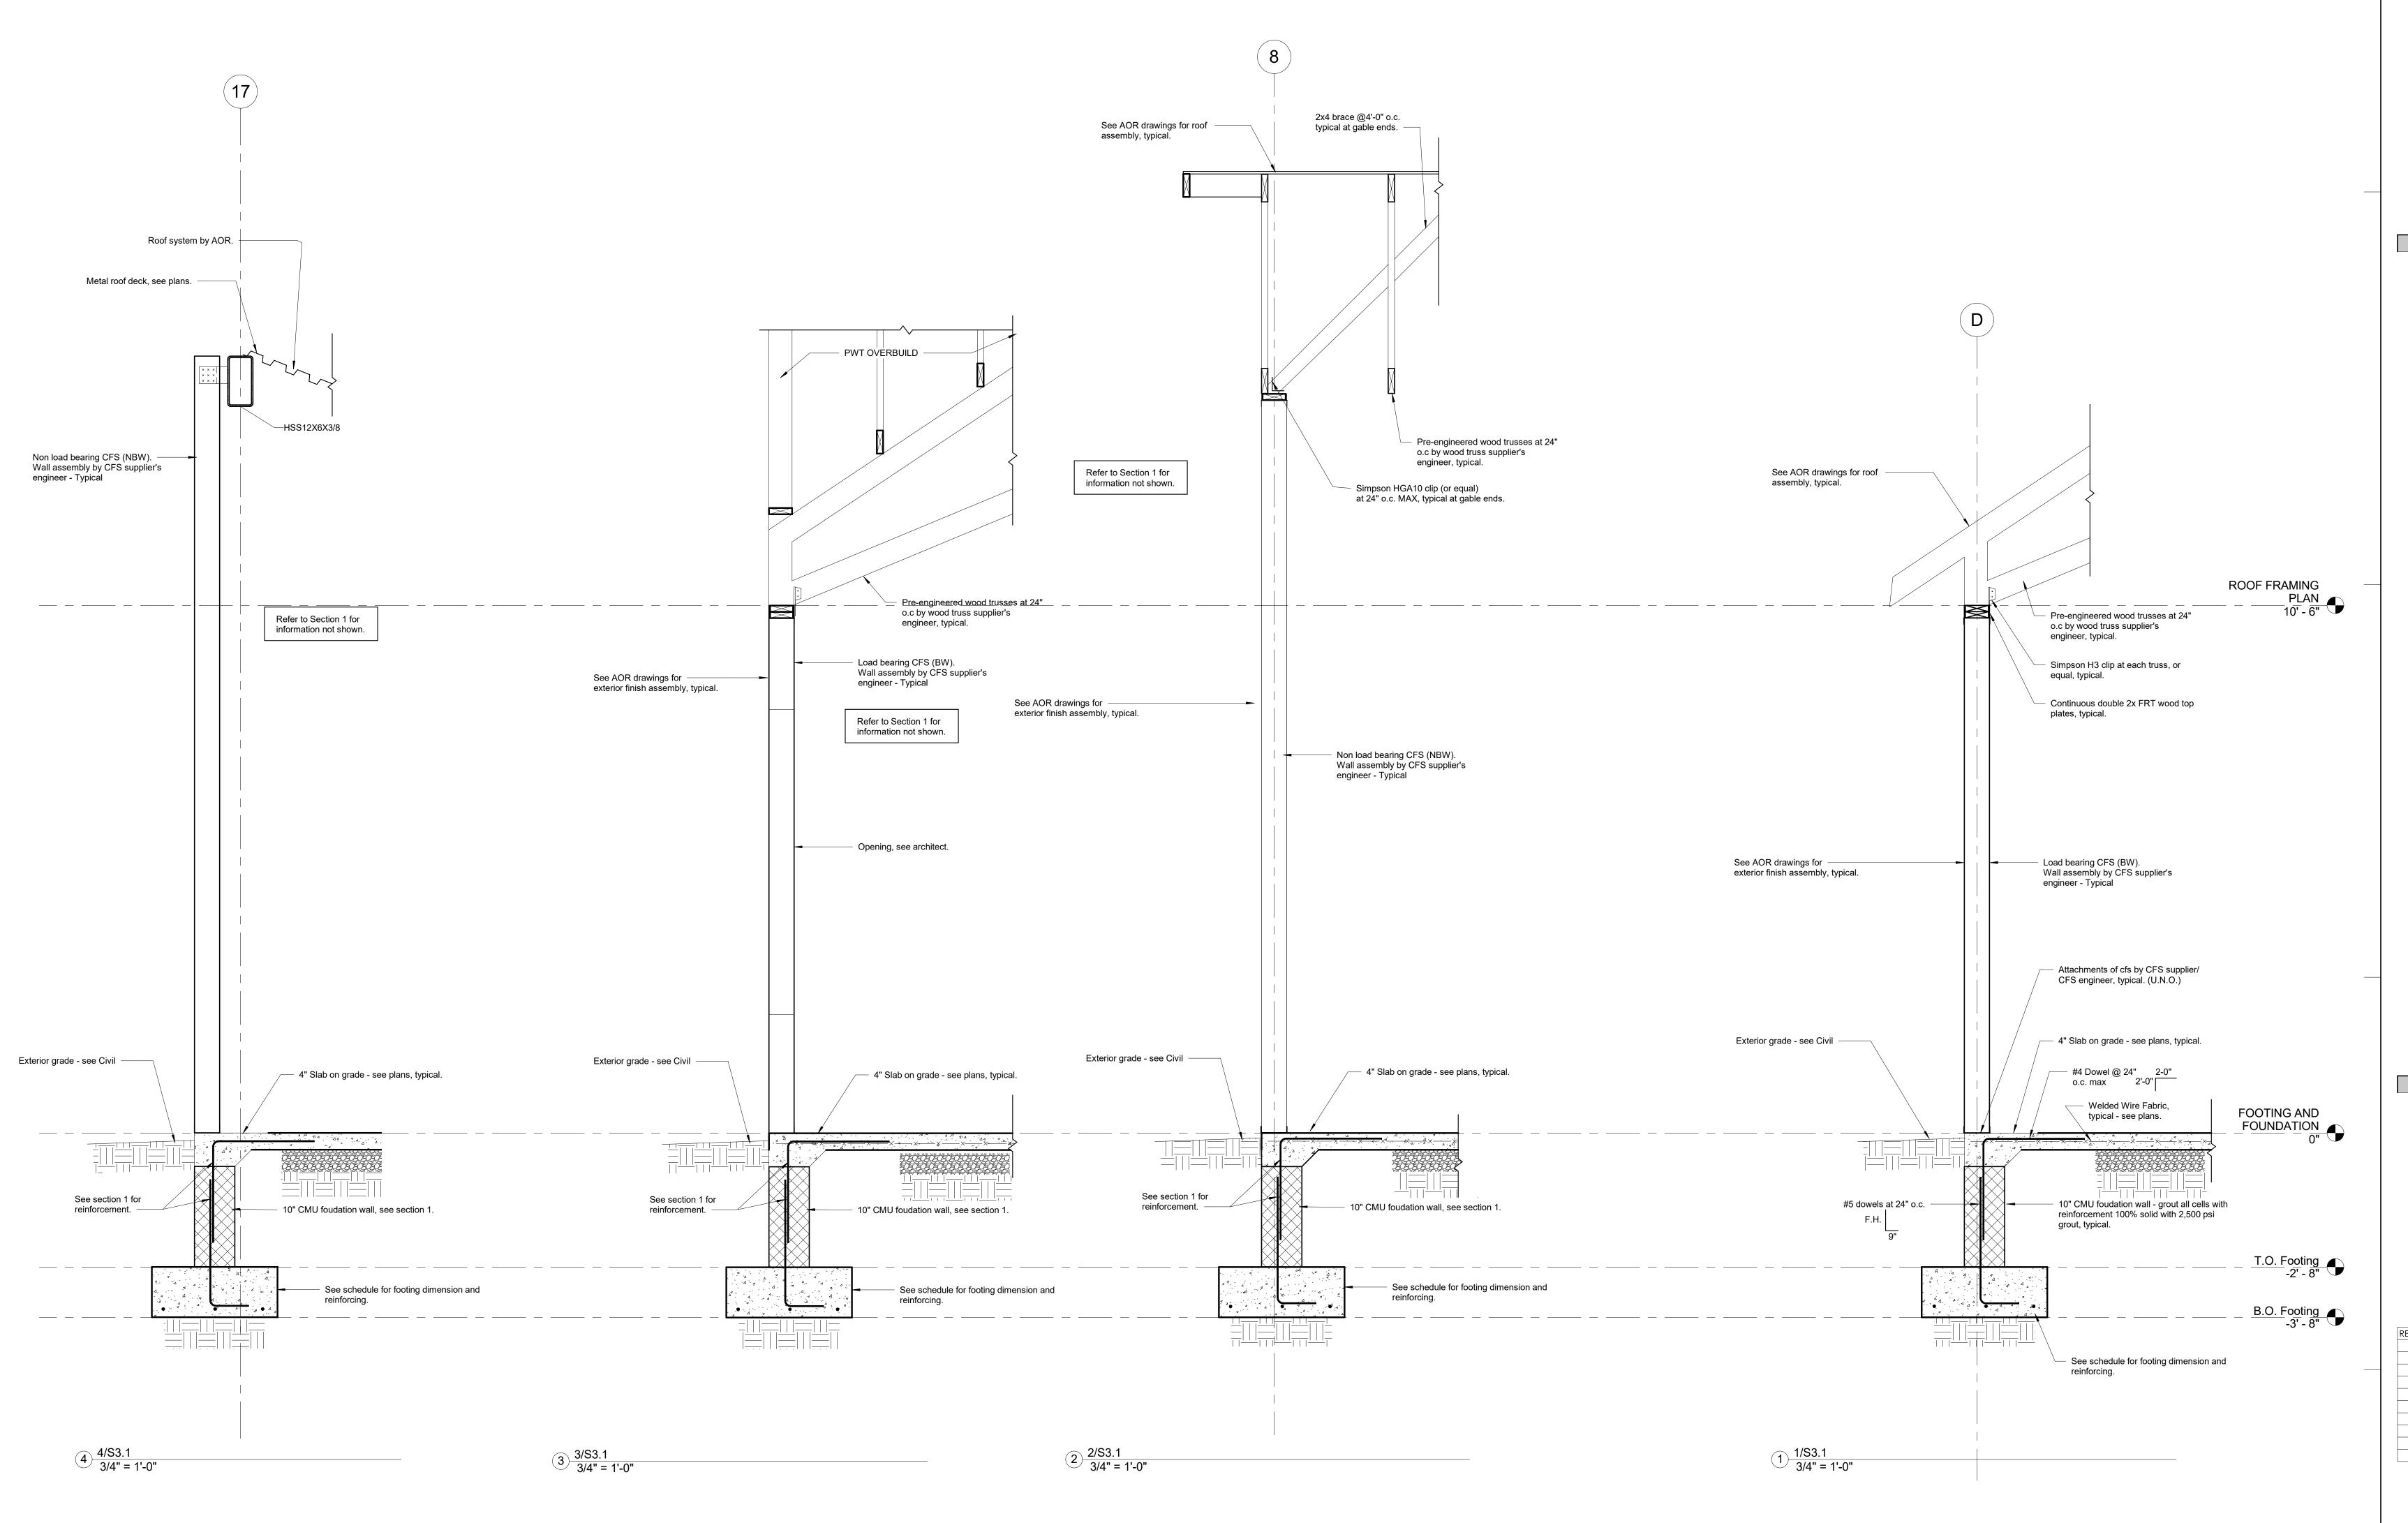
ARCHITECT'S STAMP

SHEET INFORMATION <u>KEY PLAN</u>

<u>REVISIONS</u>			
REV. #:	DESCRIPTION:		DATE:

PROJECT STATUS

JOB NUMBER:	17059
ISSUE DATE:	10 APRIL 2018
SCALE:	1/8" = 1'-0
SHEET TITLE:	
ROOF FRA	MING PLAN
SHEET NUMBER:	



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PROJECT INFORMATION

PROJECT TITLE


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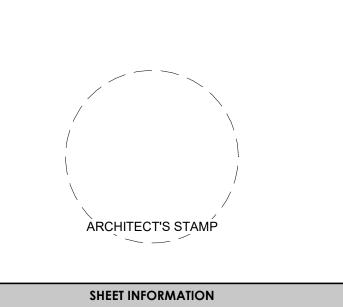
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PROJECT OWNER

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MARYLAND DEPARTMENT OF
PUBLIC WORKS






KEY PLAN

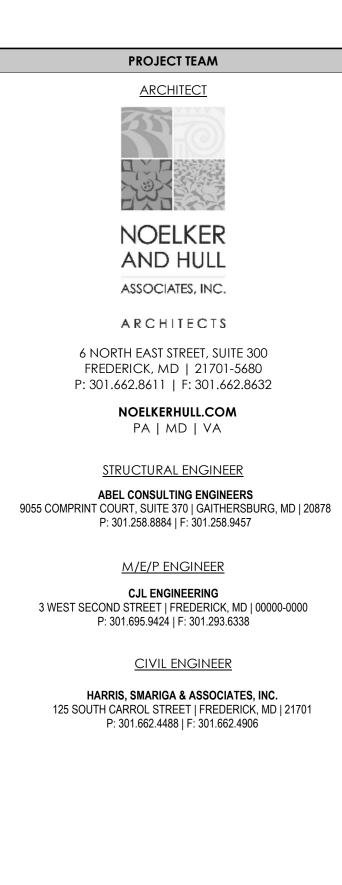
	<u>REVISIONS</u>	
REV. #:	DESCRIPTION:	DATE:

PROJECT STATUS

ISSUE DATE:		10 APRI
SCALE:		As indi
SHEET TITLE:		
	SECTIONS	

S3.1

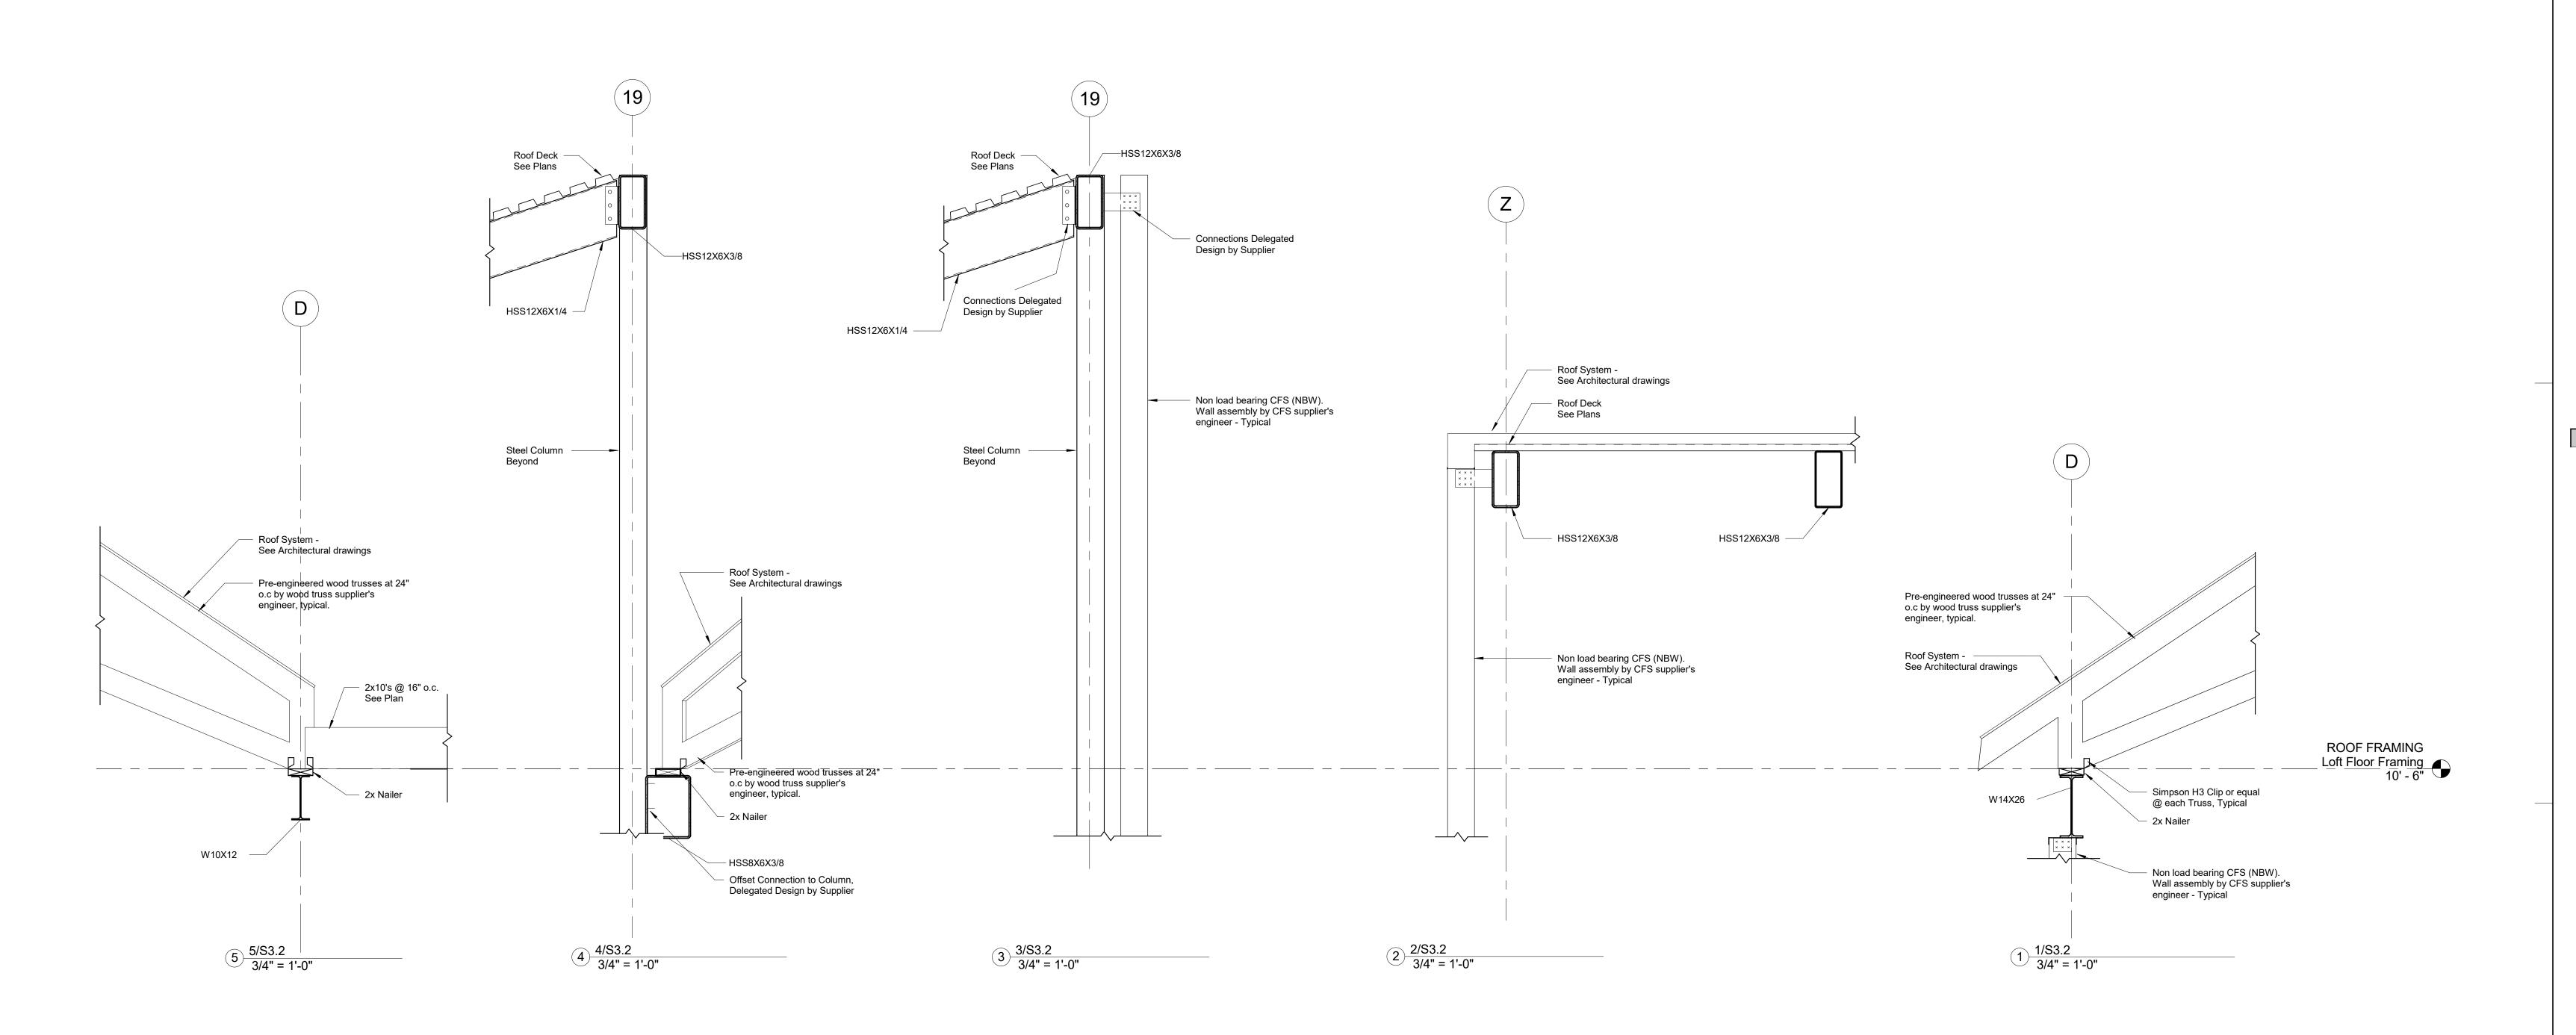

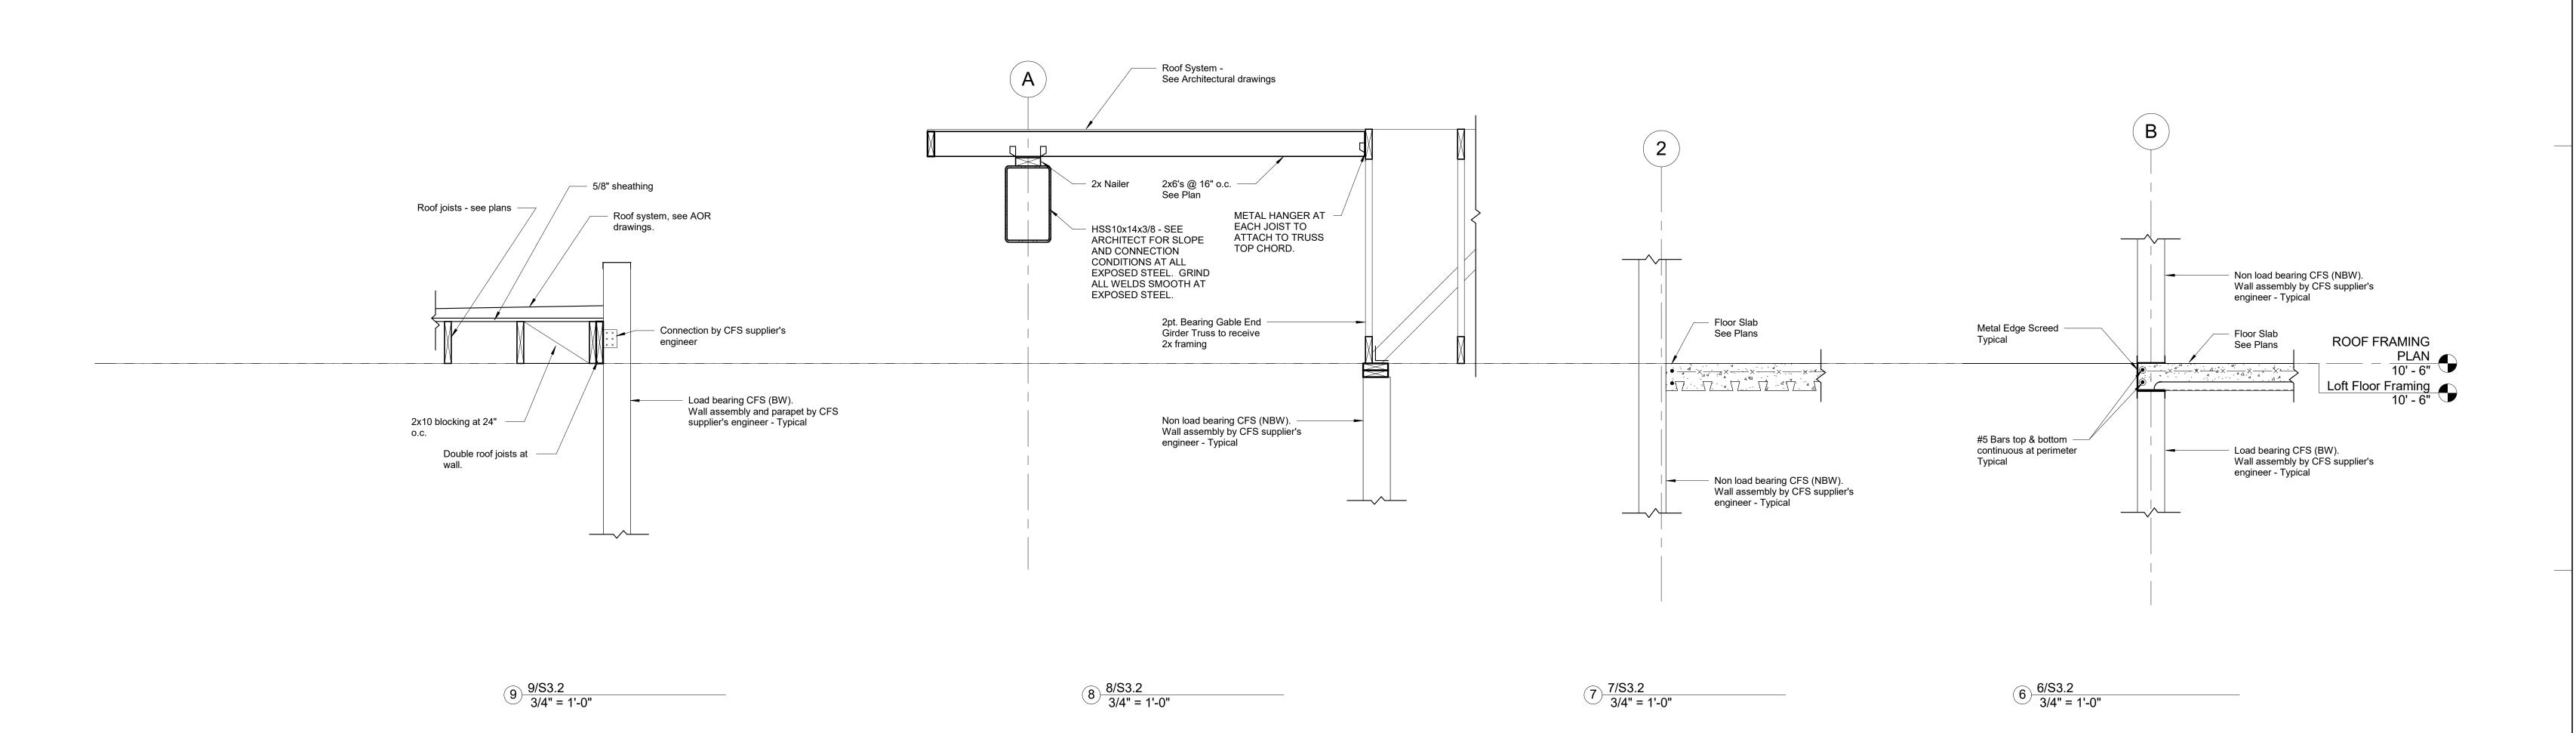



PROJECT INFORMATION

PROJECT TITLE

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PROJECT ADDRESS

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PROJECT OWNER

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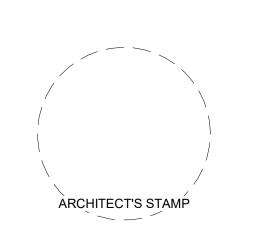
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SHEET INFORMATION

KEY PLAN

REV. #: DESCRIPTION: DATE:


PROJECT STATUS

JOB NUMBER: 17059
ISSUE DATE: 10 APRIL 2018
SCALE: As indicated
SHEET TITLE:

SECTIONS

SHEET NUMBER:

53.2

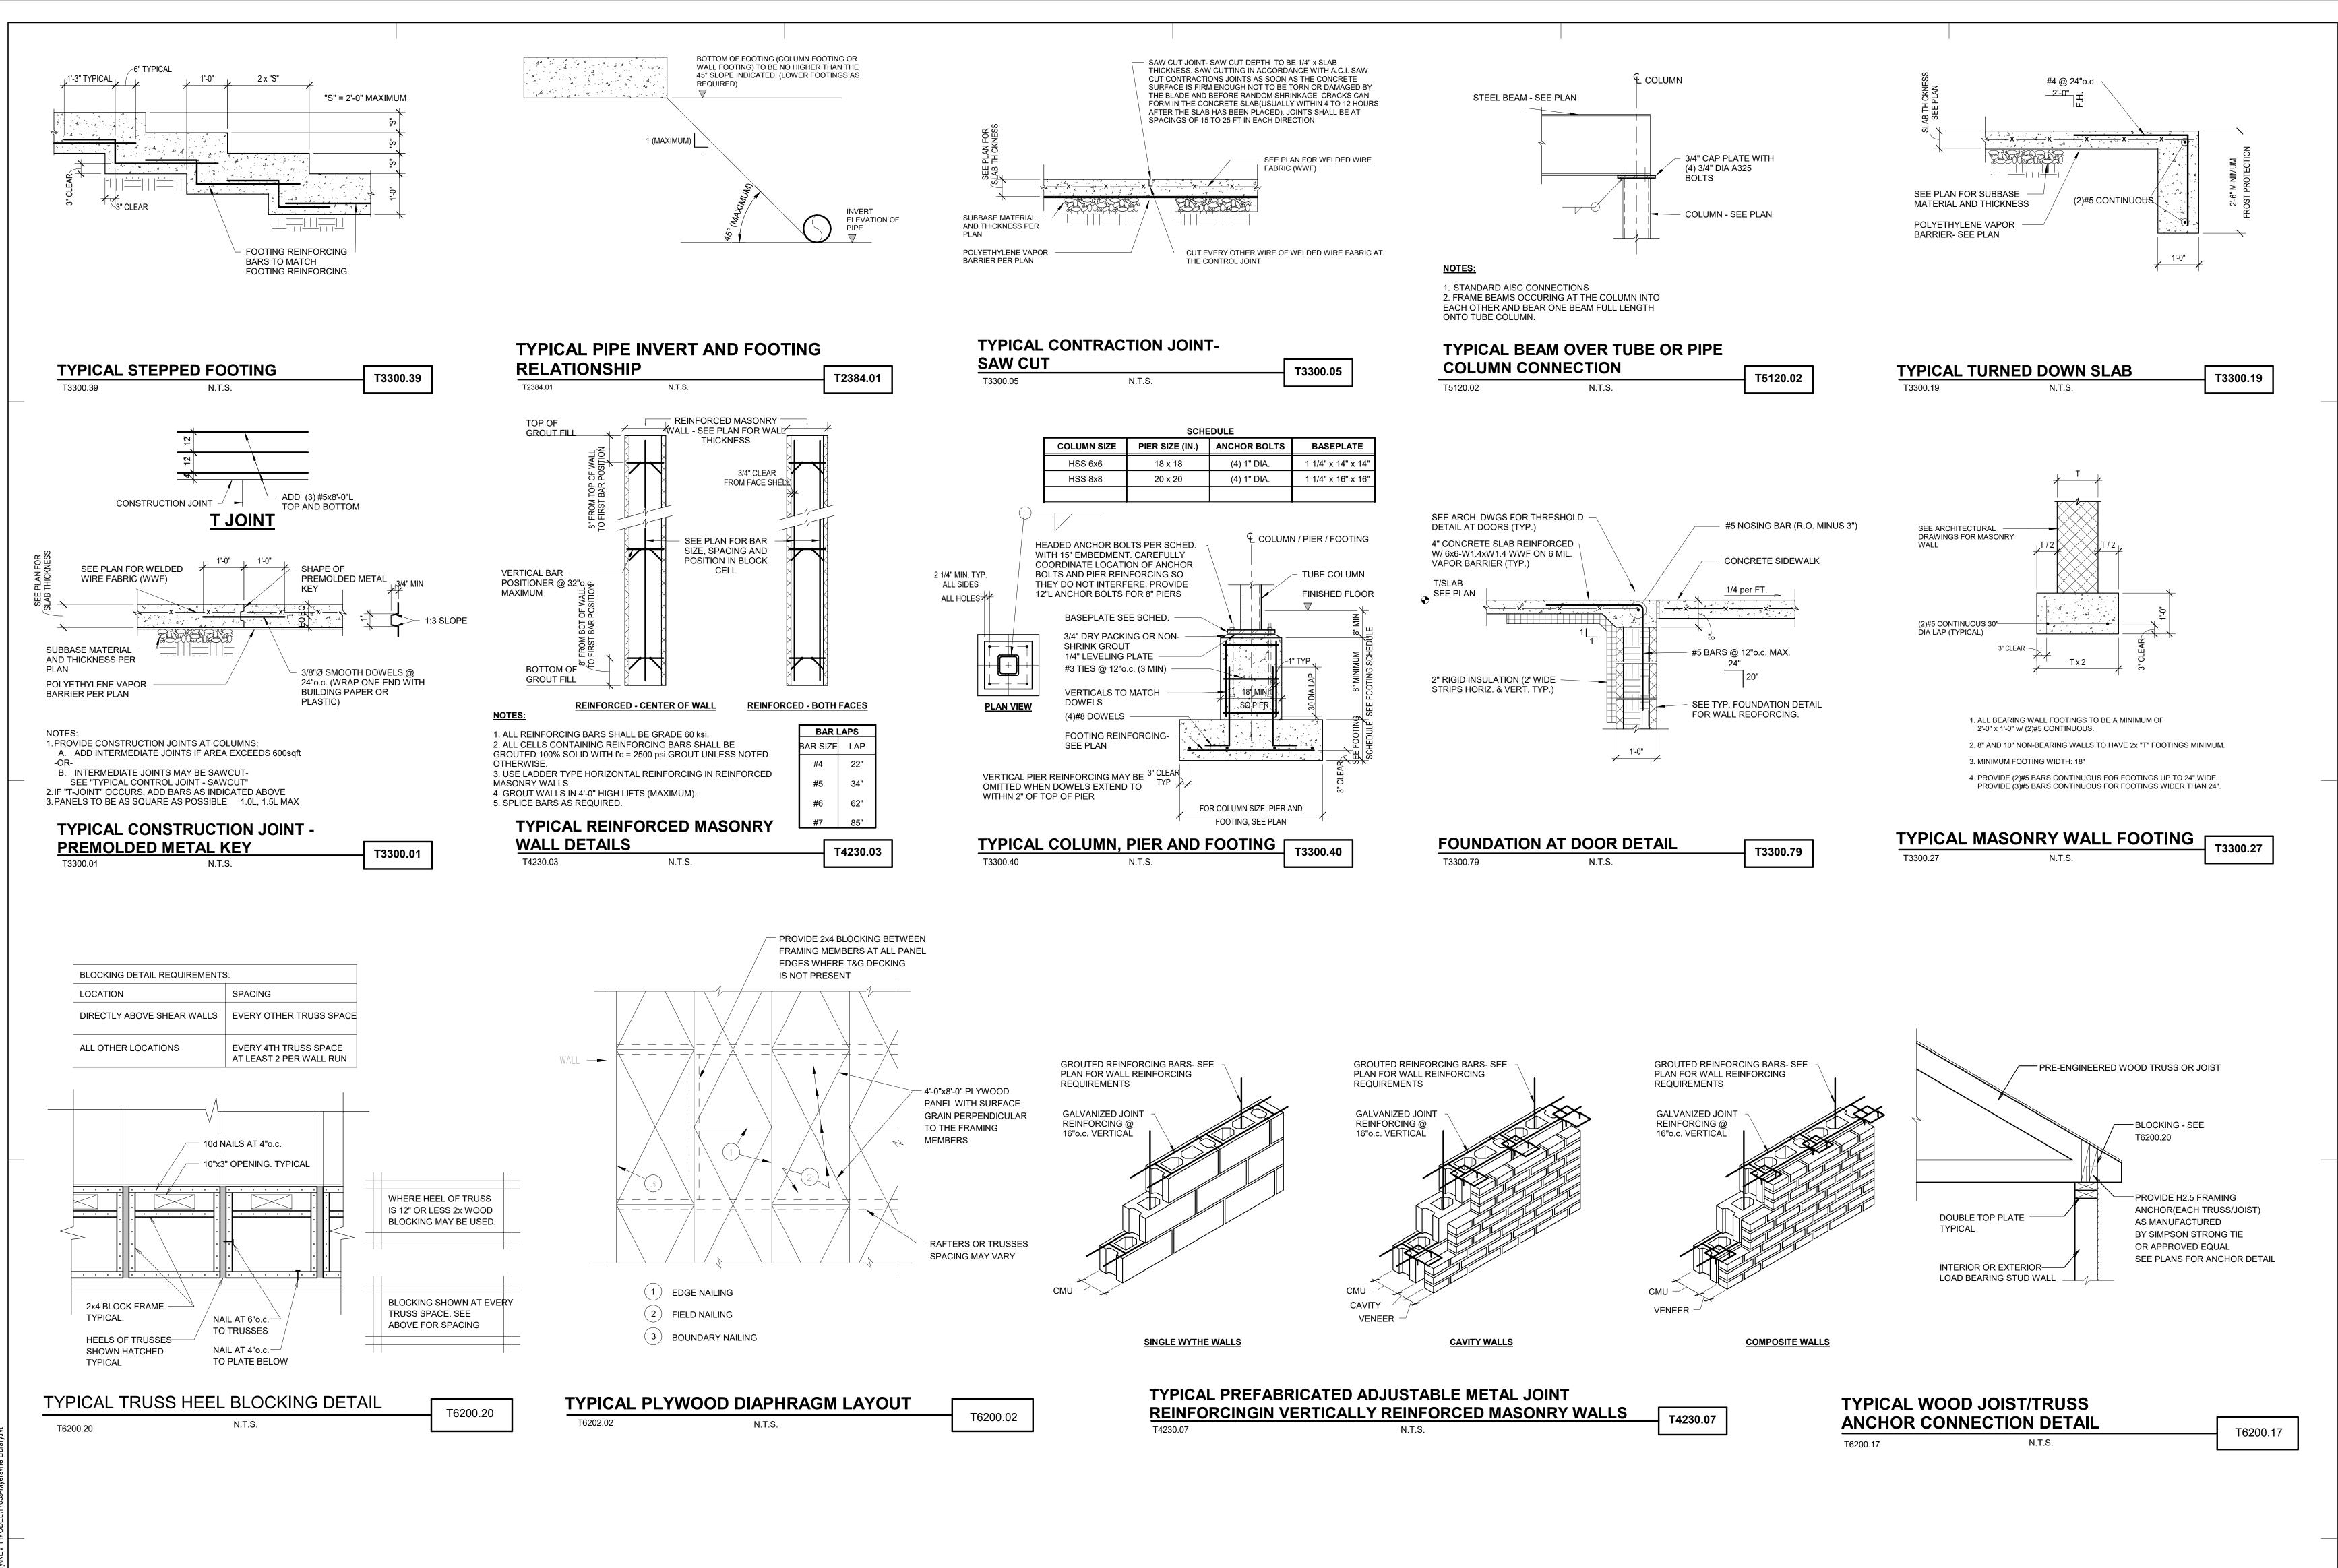

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PROJECT INFORMATION

PROJECT TITLE

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PROJECT ADDRESS

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Myersville, MD 21773

PROJECT OWNER

FREDERICK COUNTY,
MARYLAND DEPARTMENT OF
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ABEL CONSULTING ENGINEERS


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SHEET INFORMATION

KEY PLAN

	<u>revisions</u>	
REV. #:	DESCRIPTION:	DATE:
I —		


PROJECT STATUS

JOB NUMBER: 17059
ISSUE DATE: 10 APRIL 2018
SCALE: As indicated
SHEET TITLE:

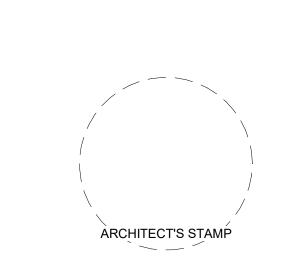
TYPICAL DETAILS

SHEET NUMBER:

54.1

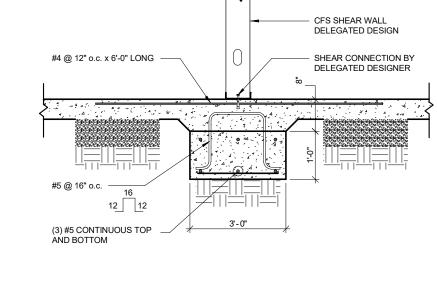

SW-1 - TYPICAL INTERIOR FOOTING @
SHEAR WALL
3/4" = 1'-0"

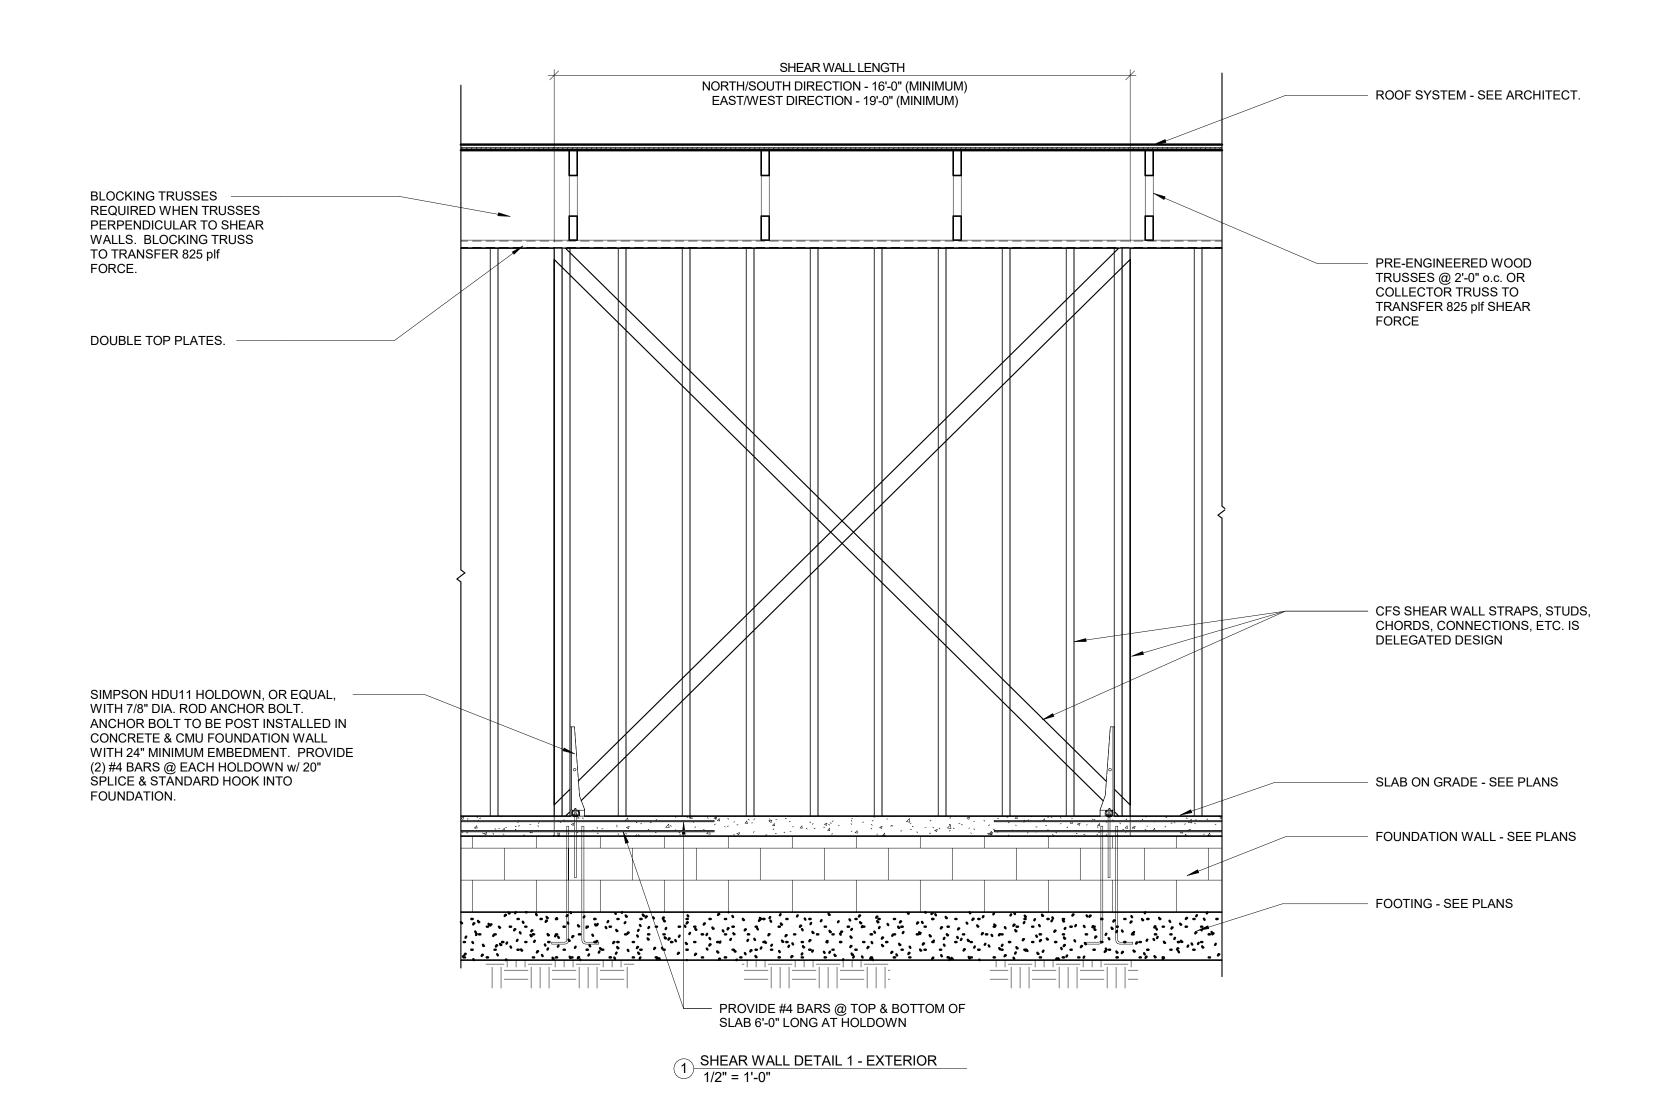


NOTES

ALL SHEAR WALL ELEMENTS & CONNECTIONS ARE DELEGATED DESIGN.

2. ALL STUDS TO BE 6" - 18 GAGE MINIMUM.

3. SEE SCHEDULE FOR ASD FACTORED LOADS.

4. ALL CMU CELLS WITH REBAR TO BE GROUTED 100% SOLID w/ fc = 2500 psi

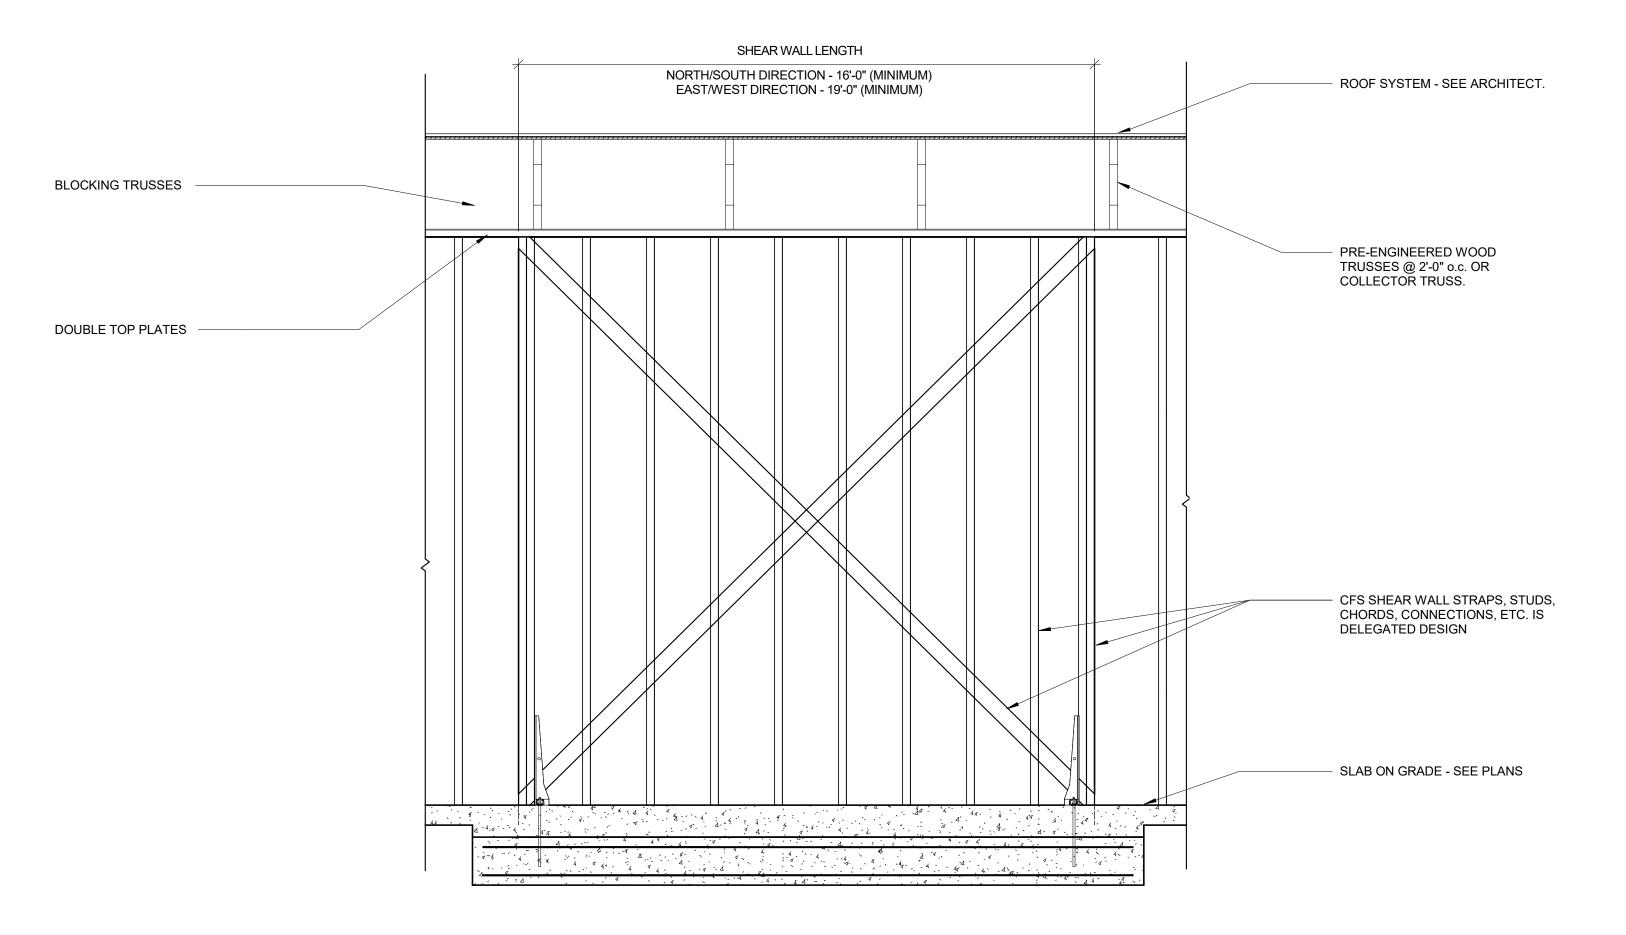

SEE SHEAR WALL DETAIL 1 - EXTERIOR FOR INFORMATION NOT SHOWN

2 SHEAR WALL DETAIL 2 - INTERIOR
1/2" = 1'-0"

	SHEAR WALL	. LOAD SCHEDULE	
	WIND LOADING	SEISMIC LOADING	
	LOAD AT TOP OF LOAD AT TOP OF		TYPE
	WALL	WALL	
SW -NORTH/SOUTH DIR.	13.2	3.5 k	FLAT STRAP - X-BRACE
SW -EAST/WEST DIR.	6. k K	3.5 K	FLAT STRAP - X-BRACE

NOTES:
1. LOADS ARE FACTORED (ASD).
2. DESIGN OF CFS SHEAR WALLS IS DELEGATED DESIGN.

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MARYLAND DEPARTMENT OF
PUBLIC WORKS

PROJECT TEAM



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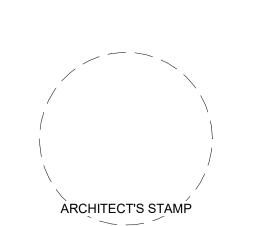
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KEY PLAN

REV. #: DESCRIPTION: DATE:

PROJECT STATUS

JOB NUMBER: 17059
ISSUE DATE: 10 APRIL 2018
SCALE: As indicated
SHEET TITLE:

SHEAR WALL DETAILS

SHEET NUMBER:

DIVISION 1 - GENERAL REQUIREMENTS

THE STRUCTURAL DRAWINGS INDICATE THE FINAL CONDITION/CONFIGURATION OF THE BUILDING STRUCTURE. MEANS AND METHODS USED BY THE CONTRACTOR TO ACHIEVE THE FINAL CONDITION/CONFIGURATION OF THE BUILDING STRUCTURE ARE THE SOLE RESPONSIBILITY OF THE CONTRACTOR.

STRUCTURAL DETAILS SHOW BASIC STRUCTURAL CONDITIONS. IT IS INTENDED THAT THESE DRAWINGS BE USED IN CONJUNCTION WITH THE CONTRACT DOCUMENTS FROM ALL DISCIPLINES. STRUCTURAL WORK MUST BE COORDINATED WITH THE DOCUMENTS OF THE OTHER DISCIPLINES CONTAINED IN THE CONTRACT SET.

SHOP DRAWINGS FOR ALL STRUCTURAL ELEMENTS SHOWN ON THE CONTRACT DOCUMENTS SHALL BE SUBMITTED BY THE CONTRACTOR.

WHEN THE STRUCTURAL CONTRACT DOCUMENTS HAVE BEEN REPRODUCED FOR SHOP DRAWING PREPARATION THE COMPANY WHICH PREPARED THE SHOP DRAWINGS SHALL ASSUME THE SOLE RESPONSIBILITY FOR ALL STRUCTURAL INFORMATION SHOWN ON THE SHOP DRAWINGS AS IF THEY WERE PREPARED BY THAT COMPANY. THE COMPANY PREPARING THESE SHOP DRAWINGS SHALL CHECK ALL DIMENSIONS, ELEVATIONS, AND OTHER STRUCTURAL INFORMATION IN THE REPRODUCED CONTRACT DOCUMENTS.

AT THE TIME OF SHOP DRAWING SUBMISSION THE CONTRACTOR SHALL STATE IN WRITING ANY DEVIATIONS OR OMISSIONS FROM THE CONTRACT DOCUMENTS.

THE CONTRACTOR SHALL REVIEW ALL SHOP DRAWINGS BEFORE SUBMISSION AND MAKE ALL CORRECTIONS DEEMED NECESSARY.

THE CONTRACTOR SHALL ALLOW A MINIMUM OF 10 WORKING DAYS FOR STRUCTURAL REVIEW OF SHOP DRAWINGS.

LOADS GREATER THAN THE DESIGN LIVE LOADS SHALL NOT BE PLACED ON THE STRUCTURE DURING OR AFTER CONSTRUCTION.

SEE MECHANICAL OR ARCHITECTURAL DRAWINGS FOR HOLES IN SLABS NOT SHOWN.

THE TERM DELEGATED DESIGN SHALL MEAN THAT THE SELECTED BUILDING COMPONENT IS DESIGNED BY A REGISTERED PROFESSIONAL ENGINEER REGISTERED IN THE LOCAL JUSRISDICTION. DESIGN CALCULATIONS AND SHOP DRAWINGS FOR THE SELECTED BUILDING COMPONENTS SHALL BE SIGNED AND SEALED AND SUBMITTED FOR REVIEW. THE DELEGATED DESIGN ENGINEER SHALL SUBMIT A CERTIFICATE OF LIABILITY INSURANCE WITH THE SIGNED AND SEALED CALCULATIONS AND SHOP DRAWINGS.

CONTRACTOR SHALL HAVE ALL TEMPORARY FORMWORK, SHEETING, SHORING, AND UNDERPINNING, ETC., NECESSARY TO CONSTRUCT THE STRUCTURE DESIGNED BY A QUALIFIED REGISTERED ENGINEER REGISTERED IN THE LOCAL JURISDICTION. THE CONTRACTOR SHALL SUBMIT ONE COPY OF ALL TEMPORARY FORMWORK, SHEETING, SHORING, UNDERPINNING, ETC., SIGNED AND SEALED BY THE REGISTERED ENGINEER ALONG WITH A CERTIFICATE OF PROFESSIONAL LIABILITY INSURANCE FOR THE QUALIFIED REGISTERED ENGINEER. THIS SUBMISSION WILL NOT BE A SHOP DRAWING SUBMITTED FOR REVIEW. THIS SUBMISSION WILL BE FOR RECORD PURPOSES TO DEMONSTRATE THE DESIGN HAS BEEN PERFORMED BY A REGISTERED PROFESSIONAL ENGINEER.

ABEL CONSULTING ENGINEERS, P.A. WILL NOT BE RESPONSIBLE FOR TEMPORARY FORMWORK, SHEETING, SHORING, UNDERPINNING, ETC. NECESSARY TO INSTALL WORK CONTAINED WITHIN THESE DOCUMENTS.

ALL WORK SPECIFIED HEREIN SHALL BE INSPECTED IN ACCORDANCE WITH THE BUILDING CODE, ALL LOCAL ORDINANCES AND THE CONTRACT DOCUMENTS. ALL INSPECTION WORK MUST BE PERFORMED UNDER THE DIRECT SUPERVISION OF AN ENGINEER REGISTERED IN THE LOCAL JURISDICTION.

ABEL CONSULTING ENGINEERS, P.A., WILL NOT PERFORM THE REQUIRED INSPECTION AS PART OF THEIR DESIGN SERVICE. ABEL CONSULTING ENGINEERS, P.A., MAY VISIT THE SITE TO ASCERTAIN GENERAL CONFORMANCE TO THE CONTRACT DOCUMENTS BUT, SUCH VISITS ARE NOT BE CONSTRUED AS MEETING INSPECTION REQUIREMENTS.

ALL STAIRS, RAILINGS, GLASS, STOREFRONT, AND EXTERIOR CEILINGS SHALL BE DESIGNED FOR LOADS INDICATED ON THE DRAWINGS AND IN THE LOCAL BUILDING CODE. SHOP DRAWINGS AND CALCULATIONS SHALL BE SIGNED AND STAMPED BY REGISTERED

ALL REFERENCED STANDARDS SHALL BE THE LATEST APPROVED EDITION PER THE BUILDING CODE NOTED ON THESE DRAWINGS.

PROFESSIONAL ENGINEER REGISTERED IN THE LOCAL JURISDICTION.

DESIGN CRITERIA: BUILDING CODE: 2015 IBC AND LOCAL AMMENDMENTS OCCUPANCY CATEGORY: II

SEISMIC:

IE = 1.0SITE CLASS: I SS = 0.126

S1 = 0.052SDS = 0.134

SD1 = 0.083 R = 3CS = 0.045

SEISMIC DESIGN CATEGORY: B SEISMIC FORCE RESISTING SYSTEM: LIGHT-FRAME (CFS) WALL SYSTEMS USING FLAT STRAP BRACING AND ORDINARY STEEL MOMENT FRAMES NOT SPECIFICALLY DETAILED FOR SEISMIC

DESIGN BASE SHEAR = 10

ANALYSIS PROCEDURE: **EQUIVALENT LATERAL FORCE PROCEDURE**

V = 115 MPH

IW = 1.0EXPOSURE: C

APPLICABLE INTERNAL PRESSURE COEFFICIENTS: +/- 0.18 COMPONENTS AND CLADDING PRESSURES: ±26.0 PSF MINIMUM – ZONE 4(OVER 1000 SQ FT TRIBUTARY AREA)

±26.0 PSF MINIMUM – ZONE 5(OVER 1000 SQ FT TRIBUTARY AREA) ±33.9 PSF MAXIMUM – ZONE 4(UNDER 10 SQ FT TRIBUTARY AREA) ±41.8 PSF MAXIMUM – ZONE 5(UNDER 10 SQ FT TRIBUTARY AREA)

SNOW: PG = 30 PSF

IS = 1.0CE = 1.0 CT = 1.0

PF = 21 PSF

LIVE LOADS: ROOF = 30 PSF (MINIMUM) LOFT FLOOR = 60 PSF

DEAD LOADS: TRUSS ROOF = 25 PSF LOFT FLOOR = 90 PSF TROLLEY ROOF = 18 PSF

DIVISION 2 - SITE WORK

AREAS NOT EXCEEDING 225 SQUARE FEET.

FOOTINGS ARE DESIGNED FOR A BEARING CAPACITY OF 3.000 PSF PROVIDED BY THE GEOTECHNICAL ENGINEER OF RECORD PER ECS MID-ATLANTIC, LLC REPORT NUMBER 13.8337. FOOTINGS SHALL BEAR ON NATURAL UNDISTURBED SOIL, 1'-0" BELOW ORIGINAL GRADE OR ON ENGINEERED CONTROLLED FILL AS SPECIFIED BY THE GEOTECHNICAL ENGINEER. BOTTOM OF EXTERIOR FOOTING SHALL BE A LOCATED AT A MINIMUM DEPTH TO MEET LOCAL JURISDICTION REQUIREMENTS FOR FROST PROTECTION. THE SOIL BEARING PRESSURE SHALL BE VERIFIED BY QUALIFIED INSPECTORS. IF BEARING CAPACITY IS FOUND TO BE LESS THAN THE CAPACITY ABOVE, THE FOOTINGS WILL HAVE TO BE REDESIGNED.

THE CONTRACTOR SHALL PROVIDE FROST PROTECTION FOR ALL FOUNDATION SUBGRADES DURING CONSTRUCTION. NO FOOTINGS SHALL BE CAST ON FROZEN SUB-GRADE MATERIAL. FROST PROTECTION SHALL BE MAINTAINED AFTER THE FOOTINGS HAVE BEEN CAST TO INSURE THAT NO BEARING MATERIAL BECOMES FROZEN PRIOR TO BACK-FILLING.

ALL FILL UNDER SLABS ON GROUND SHALL BE COARSE GRANULAR MATERIAL COMPACTED IN ACCORDANCE WITH THE GEOTECHNICAL ENGINEER'S RECOMMENDATIONS. ALL SLABS ON GROUND SHALL BE POURED CONTINUOUSLY TO FORM RELATIVELY SQUARE

DO NOT BACKFILL AGAINST FOUNDATION WALLS UNTIL SUPPORTING SLABS ARE IN PLACE AND HAVE ATTAINED REQUIRED STRENGTH. IF A WALL REQUIRES BACKFILLING PRIOR TO PLACEMENT OF SUPPORTING SLAB THE CONTRACTOR SHALL HIRE A REGISTERED PROFESSIONAL ENGINEER REGISTERED IN THE LOCAL JURISDICTION TO DESIGN BRACING. BRACE THE WALL UNTIL THE SLAB IS IN PLACE AND HAS ACHIEVED DESIGN STRENGTH.

DIVISION 3 - CONCRETE

SLABS ON GROUND SHALL BE 4" THICK CONCRETE REINFORCED WITH 6"X6" W1.4XW1.4 WWF OVER VAPOR BARRIER AND 4" WASHED GRAVEL UNLESS OTHERWISE NOTED. SEE SPECIFICATIONS FOR VAPOR BARRIER. SEE GEOTECHNICAL REPORT FOR WASHED GRAVEL SPECIFICATION.

ALL SLABS UNLESS OTHERWISE SPECIFIED SHALL HAVE THE FOLLOWING TEMPERATURE

#3 AT 12" O.C

5" TO 6 1/2" #3 AT 9" O.C. OVER 6 1/2" #4 AT 12" O.C.

WELDED WIRE FABRIC SHALL HAVE ENDS LAPPED ONE FULL MESH AND SHALL EXTEND INTO SUPPORTING BEAMS OR WALLS EXCEPT AT SLABS ON GROUND.

ALL SPLICES IN REINFORCING SHALL BE CLASS "B" SPLICES IN ACCORDANCE WITH ACI-318 (LATEST LOCAL APPROVED EDITION) EXCEPT AS NOTED IN THE PLANS. BEND HORIZONTAL WALL REINFORCING 1'-0" MINIMUM AROUND ALL CORNERS OR PROVIDE 4'-0" LONG CORNER BARS TO MATCH HORIZONTAL REINFORCING.

ALL CONCRETE NOT EXPOSED TO WEATHER SHALL BE F'C = 3,000 PSI, NORMAL WEIGHT CONCRETE AT 28 DAYS UNLESS NOTED OTHERWISE ON THE PLANS.

ALL CONCRETE EXPOSED TO WEATHER SHALL BE F'C = 4500 PSI, NORMAL WEIGHT, AIR-ENTRAINED CONCRETE AT 28 DAYS UNLESS NOTED OTHERWISE ON THE PLANS.

ALL REINFORCING STEEL SHALL BE HIGH STRENGTH NEW BILLET STEEL CONFORMING TO ASTM DESIGNATION A-615 (LATEST LOCAL APPROVED EDITION),FY=60,000 PSI). ALL REINFORCING SHALL BE DETAILED, FABRICATED, AND PLACED IN ACCORDANCE WITH THE ACI'S "MANUAL OF STANDARD PRACTICE FOR DETAILING CONCRETE STRUCTURES" (ACI-315, LATEST LOCAL APPROVED EDITION). UNLESS OTHERWISE NOTED IN STRUCTURAL DRAWINGS, PROVIDE CONCRETE PROTECTION FOR REINFORCING AS FOLLOWS:

CAST AGAINST EARTH -----EXPOSED TO EARTH OR WEATHER: NO.6 AND LARGER BARS ----- 2"

NO.5 AND SMALLER BARS ----- 1-1/2" NOT EXPOSED TO EARTH OR WEATHER:

SLABS, WALLS, JOISTS ----- 3/4" BEAMS, GIRDERS, COLUMNS ----- 1-1/2" TO TIES, STIRRUPS, OR SPIRALS

ALL FORMWORK SHALL BE IN ACCORDANCE WITH THE AMERICAN CONCRETE INSTITUTE "FORMWORK FOR CONCRETE", SPECIAL PUBLICATION NO.4 AND ACI'S "STANDARD RECOMMENDED PRACTICE FOR CONCRETE FORMWORK" (ACI-347, LATEST LOCAL APPROVED EDITION).

ALL CONCRETE WORK SHALL CONFORM TO THE LATEST APPROVED (BY LOCAL GOVERNMENT) EDITIONS OF THE FOLLOWING A.C.I. AND A.S.T.M. DOCUMENTS:

ACI-301 SPECIFICATIONS FOR STRUCTURAL CONCRETE FOR BUILDINGS ACI-318 CODE

ACI-214 COMPRESSION TESTS ACI-306 COLD WEATHER ACI-315 DETAILING

ACI-347 FORMWORK ACI-305 HOT WEATHER

PROPORTIONS OF CONCRETE ACI-211 PLACING CONCRETE

ASTM-C94 READY-MIX CONCRETE

ALL FIELD AND LAB TESTING OF CONCRETE SHALL CONFORM TO THE LATEST APPROVED (BY LOCAL **GOVERNMENT) EDITIONS OF ASTM:**

ASTM C-31 FIELD CYLINDER SPECIMENS ASTM C-143 SLUMP TEST ASTM C-231 AIR CONTENT (WHEN REQUIRED)

ASTM C-39 LAB TESTING CYLINDERS ASTM C-172 SAMPLING FRESH CONCRETE HARDENED CORES (WHEN REQUIRED)

AN ENGINEER REGISTERED IN THE LOCAL JURISDICTION.

WHEN APPLICABLE THE CONTRACTOR SHALL HAVE AT THE SITE A FORMWORK PLAN SHOWING SIZES AND STRENGTHS OF FORMWORK, SEQUENCE OF CONSTRUCTION, AND DETAILED PLANS OF FORMWORK REMOVAL AND RESHORING. THE FORMWORK PLAN SHALL BE SIGNED AND STAMPED BY

A CONCRETE STRUCTURE MAY NOT SUPPORT ITS DESIGN LIVE LOAD FOR 28 DAYS.

CONTRACTOR MUST SUBMIT A CONCRETE DESIGN MIX IN ACCORDANCE WITH ACI-318 (LATEST LOCAL APPROVED EDITION). SUCH DESIGN MIX SHALL BE ACCOMPANIED BY THE APPROPRIATE GRAPHS AND BACKGROUND DATA. CONCRETE DESIGN MIX SHALL INDICATE 7 AND 28 DAY STRENGTHS, CEMENT CONTENT AND WATER CEMENT RATIO, FINE AND COARSE AGGREGATES AND ADMIXTURES FOR EACH DESIGN STRENGTH. THE ADDITION OF WATER AT THE PLANT OR IN THE FIELD GREATER THAN 1% MORE THAN THE SPECIFIED WATER CONTENT IS STRICTLY PROHIBITED.

DIVISION 4 – MASONRY

ALL CONCRETE MASONRY SHALL CONFORM TO THE LATEST EDITION OF ASTM SPECIFICATIONS C90 AND C145. ALL MORTAR SHALL CONFORM TO ASTM C270 AND SHALL BE TYPE "S" MINIMUM, ALL BRICK AND MASONRY CONSTRUCTION SHALL BE PROVIDED WITH STANDARD GALVANIZED "DUR-O-WAL" OR EQUAL HORIZONTAL JOINT REINFORCING AT 16" O/C UNLESS HEAVIER REINFORCING IS NOTED ON THE DRAWINGS. CALCIUM CHLORIDE AND OTHER CHLORIDES MAY NOT BE USED AS ADMIXTURES. ALL MASONRY CONSTRUCTION MUST BE PROTECTED FROM FREEZING. THE REQUIREMENTS OF THE "SPECIFICATIONS FOR MASONRY STRUCTURES" (ACI 530.1 - LATEST EDITION) SHALL BE FOLLOWED. GROUT SHALL CONFORM TO THE REQUIREMENTS OF ASTM C476 WITH A MINIMUM STRENGTH OF 2500 PSI. PRIOR TO CONSTRUCTION A MIX DESIGN OF THE GROUT SHALL BE SUBMITTED WITH

COMPRESSIVE STRENGTH TESTS PERFORMED IN ACCORDANCE WITH ASTM C1019. THE MINIMUM REQUIRED COMPRESSIVE STRENGTH (F'M AT 28 DAYS) OF BRICK MASONRY CONSTRUCTION, CONCRETE MASONRY CONSTRUCTION, AND BRICK AND CONCRETE MASONRY CONSTRUCTION IS AS FOLLOWS:

MIN. REQUIRED F'M AT 28 DAYS 1500 PSI

TUBES, COLD FORMED

DIVISION 5 - METAL DECKING, STEEL JOISTS, STRUCTURAL STEEL, AND COLD FORMED STEEL

PROVIDE G60 GALVANIZED ROOF DECK UNLESS OTHERWISE NOTED. WELD WASHERS ARE REQUIRED FOR ANY UNCOATED DECK THICKNESS OF LESS THAN .028" OR 22

DO NOT SUPPORT LIGHTS, SPRINKLERS, PIPES, CEILING, ETC FROM THE METAL FLOOR DECK OR

METAL ROOF DECK. POUR STOPS, SCREED ANGLES, ETC., ARE TO BE PROVIDED AT SLAB POUR EDGES AND AS REQUIRED TO PREVENT THE CONCRETE FROM LEAKING THROUGH THE FORMS. THE EDGE OF DECK, FLOOR AND

ALL STRUCTURAL STEEL SHALL CONFORM TO ASTM SPECIFICATION A36, A992, A500, OR A53 (CODE APPLICABLE EDITION), FOR WHICH MILL TEST REPORTS SHALL BE SUBMITTED TO THE ARCHITECT. ALL STEEL SHALL BE DETAILED, FABRICATED, AND ERECTED IN ACCORDANCE WITH THE AISC MANUAL, AISC SPECIFICATION AND AISC CODE OF STANDARD PRACTICE. ALL CONNECTIONS SHALL DEVELOP THE FULL STRENGTH OF THE BEAM. IN GENERAL, FIELD CONNECTIONS SHALL BE MADE WITH 3/4" A-325 HIGH TENSILE BOLTS AND WASHERS UNLESS OTHERWISE NOTED. BOLTS SHALL BE SNUG TIGHT. AND SHOP CONNECTIONS SHALL BE WELDED. ALL STEEL SHALL BE FABRICATED WITH NATURAL CAMBER

ROOF SHALL BE COORDINATED WITH THE CONTRACT DOCUMENTS BY THE CONTRACTOR.

ALL STRUCTURAL STEEL GRADES ARE AS FOLLOWS UNLESS NOTED OTHERWISE: FY=50 KSI ASTM A992 WIDE-FLANGE SHAPES ANGLES, CHANNELS & PLATES FY=36 KSI ASTM A36

PIPES, HOT FORMED ASTM A53 GRADE B FY=35 KSI ALL WELDING AND WELD INSPECTION SHALL BE IN ACCORDANCE WITH THE "STRUCTURAL WELDING CODE - STEEL", AWS D1.1 (LATEST LOCAL APPROVED) OF THE AMERICAN WELDING SOCIETY. THESE WELDS SHALL BE MADE ONLY BY OPERATORS QUALIFIED BY PRESCRIBED TESTS IN THE "STRUCTURAL WELDING CODE IN BUILDING CONSTRUCTION" OF THE AMERICAN WELDING SOCIETY. ACCEPTANCE OF THE WELDS TO BE SUBJECT TO THE INSPECTION AND REVIEW OF AN AWS QUALIFIED INSPECTOR.

FY=46 KSI

ASTM A500 GRADE B

CONNECTIONS DETAILED BY THE FABRICATOR SHALL MEET THE FOLLOWING REQUIREMENTS: ALL CONNECTIONS SHALL BE DESIGNED BY A PROFESSIONAL ENGINEER IN THE LOCAL JURISDICTION. THE DESIGN OF THE STEEL CONNECTIONS IS CONSIDERED DELEGATED DESIGN. SUBMIT SIGNED AND SEALED CALCULATIONS AND SIGNED AND SEALED STEEL SHOP

B. CONNECTIONS MAY BE DESIGNED AND DETAILED IN ACCORDANCE WITH PART 10 OF THE AISC MANUAL – 14TH EDITION.

WHERE BEARING TYPE CONNECTIONS ARE SPECIFIED, SHEAR VALUES FOR THREADS INCLUDED IN THE SHEAR PLANE SHALL BE USED. EXCEPT AS FOLLOWS: SPECIAL CONNECTIONS FOR REACTIONS EXCEEDING 45 KIPS MAY BE DESIGNED AND DETAILED USING LARGE DIAMETER BOLTS AND/OR HIGHER STRENGTH BOLTS AND/OR BOLT STRENGTHS FOR THREADS EXCLUDED FROM THE

D. BOLTS IN MOMENT RESISTING CONNECTIONS SHALL BE SLIP CRITICAL TYPE.

E. BEAMS FRAMING INTO THE WEAK AXIS OF THE COLUMN SHALL FRAME DIRECTLY INTO THE WEB OF THE COLUMN WHENEVER POSSIBLE.

ALL STRUCTURAL STEEL SHALL BE SHOP PAINTED WITH A RUST INHIBITIVE PRIMER (RED OXIDE). IT WILL NOT BE NECESSARY TO MASK OUT AREAS FOR WELDING. IT WILL BE NECESSARY TO MASK OUT AREAS FOR FRICTION TYPE BOLTED CONNECTIONS.

STRUCTURAL COLD FORMED METAL FRAMING SHALL BE DEFINED AS ANY COLD FORMED METAL FRAMING THAT SUPPORTS VERTICAL ROOF OR FLOOR LOADS, PROVIDES BACKUP FOR THE EXTERIOR SKIN OF THE STRUCTURE AND RESISTS WIND LOAD, OR ACTS AS A SHEARWALL FOR THE STRUCTURE.

STRUCTURAL COLD FORMED METAL FRAMING SHOWN ON STRUCTURAL PLANS IS TO BE USED AS A GUIDELINE BY THE COLD FORMED STEEL CONTRACTOR. THE MINIMUM GAGE FOR COLD FORMED STEEL METAL FRAMING SHALL BE 18 GAGE.

COLD FORMED STEEL FRAMING DESIGN, SHOP DRAWINGS, AND CALCULATIONS SHALL BE DEVELOPED FOR ALL STRUCTURAL COLD FORMED STEEL. DESIGN AND DETAILING OF THE COLD FORMED STEEL MEMBERS AND SHOP DRAWINGS IS CONSIDERED DELEGATED DESIGN. SHOP DRAWINGS AND CALCULATIONS SHALL BE SIGNED AND STAMPED BY A REGISTERED PROFESSIONAL ENGINEER REGISTERED IN THE LOCAL JURISDICTION.

DESIGN, FABRICATION AND ERECTION OF ALL MEMBERS SHALL CONFORM TO THE FOLLOWING STANDARD SPECIFICATIONS, LATEST EDITION, AS ADOPTED BY THE AMERICAN IRON AND STEEL INSTITUTE, "LIGHTGAGE COLD-FORMED STEEL DESIGN MANUAL".

FOR ALL COLD FORMED STRUCTURAL MEMBERS DESIGNATED 18 GAGE, FY=33KSI, FOR ALL COLD FORMED STRUCTURAL MEMBERS DESIGNATED 16-12 GAGE, FY=50KSI TYPICAL UNLESS NOTED

ALL STRUCTURAL COLD FORMED METAL FRAMING SHALL BE GALVANIZED UNLESS NOTED OTHERWISE ON THE DRAWINGS.

DIVISION 6 - STRUCTURAL WOOD PRODUCTS

DELEGATED DESIGN - PRE-ENGINEERED WOOD TRUSSES:

Pre-engineered wood truss layout drawing and bracing design.

A pre-engineered wood truss layout drawing shall be prepared by a registered professional engineer in compliance with the delegated design requirements. The pre-engineered wood truss layout drawing shall include but shall not be limited to the following

Provide a layout drawing of all pre-engineered wood truss members referenced to the individual truss shop drawings

Provide design of the required PERMANENT LATERAL BRIDGING/BRACING BETWEEN THE TRUSSES AND ADJACENT STRUCTURAL ELEMENTS THAT IS REQUIRED FOR INDIVIDUAL TRUSS MEMBERS (BASED ON the DESIGN OF THE pre engineered truss MEMBERS) AND TO INSURE TRUSS Stability. The permanent lateral bridging/bracing design shall be detailed and shown on the pre-engineered wood truss layout drawing. Signed and sealed calculations to be submitted as part of delegated

Submit THE PERMANENT BRACING PLAN SIGNED AND SEALED BY AN ENGINEER REGISTERED IN THE LOCAL JURISDICTION AND ONE COPY SUBMITTED TO ABEL CONSULTING ENGINEERS FOR RECORD ONLY. ABEL CONSULTING ENGINEERS HAS INDICATED THE STRUCTURAL ELEMENTS OF THE OVERALL BUILDING LATERAL LOAD RESISTING SYSTEM AND GRAVITY LOAD SYSTEM AND THE PERMANENT ATTACHMENT OF THESE ELEMENTS TO ONE

NOTE THAT ADEQUATE BEARING FOR TRUSSES IS PART OF THE TRUSS MANUFACTURER'S DESIGN IN REGARD TO

Truss erector MUST PROVIDE THE NECESSARY TEMPORARY BRACING TO ASSURE TRUSS STABILITY DURING CONSTRUCTION AND UNTIL ALL PERMANENT BRIDGING/BRACING OF THE Trusses IS IN PLACE AND UNTIL ALL OTHER PERMANENT STRUCTURAL ELEMENTS AND ATTACHMENTS ARE IN PLACE.

PREENGINEERED WOOD TRUSSES SHALL BE DESIGNED, FABRICATED AND ERECTED IN ACCORDANCE WITH THE DESIGN SPECIFICATION FOR LIGHT METAL PLATE CONNECTED WOOD TRUSSES TPI1-02 AND BRACING OF WOOD TRUSSES: COMMENTARY AND RECOMMENDATIONS BCSI-1 AS PUBLISHED BY TPI AND WTCA AND IN ACCORDANCE WITH THE 2005 EDITION OF THE NATIONAL DESIGN SPECIFICATION FOR WOOD CONSTRUCTION. PROVIDE ANCHORAGE AS INDICATED ON THE DRAWINGS, BUT IN NO CASE SHALL THE ANCHORAGE FOR EACH TRUSS BE LESS THAN ONE SIMPSON H7Z TIE OR PROVIDE UPLIFT CAPACITY TO RESIST THE UPLIFTS SHOWN ON THE TRUSS SHOP DRAWINGS IF THESE UPLIFTS EXCEED THE CAPACITY OF THE TIES INDICATED ON THESE DRAWINGS. UNLESS SPECIFICALLY NOTED OTHERWISE, ALL OVER BUILT

ROOF FRAMING IS TO BE OF PREENGINEERED WOOD TRUSSES.

PREENGINEERED WOOD TRUSSES AND WOOD TRUSS JOISTS ARE TO BE DESIGNED BY A STRUCTURAL ENGINEER LICENSED IN THE LOCAL JURISDICTION. SIGNED AND SEALED SHOP DRAWINGS AND CALCULATIONS SHALL BE SUBMITTED FOR REVIEW. FOR SPECIFIC LOADS AND LOADING CONDITIONS, SEE THE PLANS AND DIVISION 1 NOTES. THE DESIGN OF WOOD TRUSSES SHALL MEET OR EXCEED THE MINIMUM GRAVITY LOADS SET FORTH IN THESE DOCUMENTS AND THE MINIMUM WIND LOAD PER THE APPROPRIATE BUILDING CODE OR REFERENCED

ALL MEMBERS AND CONNECTIONS AND ATTACHMENTS MUST BE DESIGNED FOR THE APPROPRIATE DEAD, LIVE, AND WIND LOADS AND FOR ALL COMBINATIONS SPECIFIED IN THE IBC CODE (INCLUDING WIND UPLIFT).

ANY HORIZONTAL DEFLECTIONS OF THE ROOF TRUSSES DUE TO THE TRUSS CONFIGURATION (I.E., SLOPED BOTTOM CHORD) SHALL BE ACCOUNTED FOR IN THE TRUSS CONNECTION DETAILS AND SHALL BE SUBMITTED TO THE ENGINEER oof record FOR REVIEW. E. ALLOWANCE SHALL BE MADE BY THE CONTRACTOR FOR POTENTIAL UPLIFT OF ROOF TRUSS BOTTOM

CONTENT OF THE TRUSS MEMBERS. F. ALL LUMBER FOR USE IN THE TRUSSES SHALL BE #2 SOUTHERN PINE (19 PERCENT MAXIMUM MOISTURE CONTENT IN USE) OR BETTER.

CHORDS THAT MIGHT BE CAUSED BY DISTORTION OF THE TRUSS MEMBERS DUE TO VARIATIONS IN THE MOISTURE

CONTRACTOR SHALL SUBMIT SHOP DRAWINGS COMPLETE WITH SIGNED AND SEALED ERECTION PLANS AND CALCULATIONS. SHOP DRAWINGS SHALL INDICATE THE SIZE AND CAPACITY OF ALL CONNECTOR PLATES. SHOP DRAWINGS ALSO INDICATE THE WOOD GRADE, MEMBER SIZES AND WEB CONFIGURATION OF ALL TRUSSES. SHOP DRAWINGS SHALL BE SIGNED AND SEALED BY A STRUCTURAL ENGINEER LICENSED IN THE LOCAL JURISDICTION. INSTALL MEMBERS IN ACCORDANCE WITH MANUFACTURER'S RECOMMENDATION. ALL BEAMS SHALL BEAR FULL LENGTH ONTO POSTS.

STRUCTURAL WOOD JOISTS AND BEAMS SHALL BE SOUTHERN PINE NO.2 OR EQUAL. ALL FABRICATION, ERECTION, OTHER PROCEDURES, AND MINIMUM UNIT STRESSES SHALL CONFORM TO THE CURRENT "NATIONAL DESIGN SPECIFICATION FOR WOOD CONSTRUCTION". WOOD EXPOSED TO THE EXTERIOR SHALL BE PRESSURE TREATED. EXCEPT AS NOTED OTHERWISE, NAILING AND DETAILS OF CONSTRUCTION SHALL BE IN ACCORDANCE WITH THE REQUIREMENTS OF THE LOCAL BUILDING CODE AND THE AFPA'S NATIONAL DESIGN SPECIFICATION FOR STRESS-

GRADE LUMBER AND ITS FASTENINGS. IN GENERAL, TRUSSES SHALL BE ANCHORED TO SUPPORTING MEMBERS

WITH METAL FRAMING ANCHORS. PROVIDE CORNER BRACING AS REQUIRED BY THE IBC CODE. PROVIDE BRIDGING, BRACING, ETC., AS REQUIRED BY TRUSS MANUFACTURER. CONNECTORS SPECIFIED ON THE DOCUMENTS ARE TO BE INSTALLED PER MANUFACTURERS RECOMMENDATIONS. SPECIAL ORDER DETAILS SUCH AS SKEW AND SLOPE ANGLES ARE THE RESPONSIBILITY OF THE CONTRACTOR. DETAILS SHALL BE COORDINATED WITH CONNECTION SUPPLIER. CONNECTORS OTHER THAN THOSE STATED ON THE DRAWINGS MAY BE SUBSTITUTED PROVIDED THEY MEET ALL MINIMUM ALLOWABLE LOADS OF THE SPECIFIED

PROVIDE ERECTION BRACING FOR ROOF FRAMING TO INCLUDE STRUCTURAL BRACING, CROSS BRACING FOR BOTTOM CHORD BEARING, BOTTOM CHORD RESTRAINT, AND SWAY BRACING. USE IBC FOR NAILING SCHEDULE PLYWOOD - ROOF SHEATHING SHALL BE STANDARD APA RATED C-D 32/16 WITH EXTERIOR GLUE PLYWOOD WITH A NOMINAL THICKNESS OF 19/32". NAIL PLYWOOD TO TRUSSES WITH 8D NAILS AT 6" AT SHEET EDGES AND AT 12" AT

ALL INTERMEDIATE TRUSSES.

CONNECTOR. SUBSTITUTIONS SHALL BE SUBMITTED FOR REVIEW PRIOR TO INSTALLATION. SUBSTITUTION

PROPOSALS SHALL CLEARLY INDICATE THE CONNECTOR LOCATION, MANUFACTURER AND MODEL NUMBER.

	Registered Professional Engineer*	and Return	and Retained Record
Shop Drawings			
Structural Steel Shop Drawing		X	
Shear Stud Layout		N/A	
Steel Joist Shop Drawing		N/A	
Steel Stair and Railing Shop Drawing (Delegated Design)	N/A	N/A	
Metal Deck Shop Drawing		X	
Architectural Precast Shop Drawing (Delegated Design)	N/A	N/A	
Structural Precast Shop Drawing (Delegated Design)	N/A	N/A	
Reinforcing Steel Shop Drawing		X	
Cold Formed Steel Shop Drawing used for load bearing members or to support exterior cladding (Delegated Design)	X	Х	
Pre-engineered Wood Truss Layout and Shop Drawings (Delegated Design)	X	X	
Pre-engineered Cold Formed Steel Truss Layout and Shop Drawings (Delegated Design)	N/A	N/A	
Concrete Mix Designs		X	
Formwork Shop Drawing (Delegated Design)	X		X
Sheeting Shop Drawing (Delegated Design)	X		X
Shoring Shop Drawing (Delegated Design)	X		X
Mechanical, Electrical, Plumbing & Miscellaneous Penetration Layouts in Slabs, Beams, Walls, etc. (Horizontal and Vertical)		X	
Concrete Masonry Reinforcing Shop Drawing		X	
Concrete Masonry Mix and Grout Design		X	
Glass Storefront / Curtainwall System Shop Drawing (Delegated Design)	N/A	N/A	
Anchor Bolt / Embed Layout		X	
Structural Steel Mill Test Reports Reinforcing Bar Mill Test Reports			X
Welder Certifications (Fabricator)			X
Welder Certifications (Erector)			X
High Strength Bolts			X
Fabricator Qualification Data			X
Erector Qualification Data			X
Aggregate Mill Test Report			X
Cement Mill Certificate			X
Design Calculations			
Structural Steel Connection Calculations	X	X	
Steel Stair & Connection Calculations	N/A	N/A	
Glass Storefront / Curtainwall System Calculations	N/A	N/A	
Miscellaneous Steel Calculations	X	X	
Architectural Precast Calculations (Delegated Design)	N/A	N/A	
Structural Precast Calculations (Delegated Design)	N/A	N/A	
Cold Formed Steel Calculations used for load bearing members or to support exterior cladding (Delegated Design)	X	X	
Pre-engineered Wood Truss Calculations (Delegated Design)	X	X	
Pre-engineered Cold Formed Steel Truss Calculations (Delegated Design)	N/A	N/A	
Formwork (Delegated Design)	X		X
Simmon (Dologatou Doolgii)	X		X
Sheeting (Delegated Design)	A		

Note: Additional submittals may be required per the project specifications. Delegated Design means that the submittal requires a seal of a registered professional engineer registered in the local jurisdiction. The registered professional engineer must submit a certificate of proof of professional liability insurance with the shop drawing/calculation submittal.

Review and Return means that the submittal will be reviewed and returned to the appropriate party. Review and Retained for Record means that the submittal is for record purposes to confirm that the item has been designed and signed and sealed by a registered professional engineer licensed in the local jurisdiction.

AHU		LLH	LONG LEG HORIZONTAL
4 D O L L	AIR HANDLING UNIT	LLV	LONG LEG VERTICAL
ARCH.	ARCHITECTURAL	LVL	LAMINATED VENEER LUMBEI
BOTT	ВОТТОМ	L.W.	LIGHT WEIGHT (CONCRETE)
BP	BEARING PLATE, BASE PLATE	MAX.	MAXIMUM
CFS	COLD FORMED STEEL	MECH.	MECHANICAL
C.J.	CONTRACTION JOINT	MIN.	MINIMUM
CL	CENTERLINE	N.W.	NORMAL WEIGHT (CONCRET
CONC	CONCRETE	O.C.	ON CENTER
CONT.	CONTINUOUS	PCF	POUNDS PER CUBIC FOOT
CMU	CONCRETE MASONRY UNIT	PL.	PLATE
DIA	DIAMETER	PLF	POUNDS PER LINEAL FOOT
DN	DOWN	PSF	POUNDS PER SQUARE FOOT
E.F.	EACH FACE	PSI	POUNDS PER SQUARE INCH
E.J.	EXPANSION JOINT	PWT	PRE-ENGINEERED WOOD TR
EL.	ELEVATION	PMT	PRE-ENGINEERED METAL TR
ELEV.	ELEVATION	REINF	REINFORCED, REINFORCEM
E.O.S.	EDGE OF SLAB	REQ'D	REQUIRED
EQ.	EQUAL	RTU	ROOF TOP UNIT
E.W.	EACH WAY	SCJ	SLAB CONTRACTION JOINT
EX.	EXISTING	SIM	SIMILAR
FT.	FOOT	S.O.G.	SLAB ON GRADE
FTG	FOOTING	T&G	TONGUE AND GROOVE
GA	GAGE	T.O.S.	TOP OF STEEL
GB	GRADE BEAM	TYP.	TYPICAL
HORIZ	HORIZONTAL	U.N.O.	UNLESS NOTED OTHERWISE
IN.	INCH	VERT	VERTICAL
KSF	KIPS PER SQUARE FOOT	V.I.F.	VERIFY IN FIELD
KSI	KIPS PER SQUARE INCH	w/	WITH
NOI	LIGHT GAGE METAL		

(SO) SLAB OPENING

ABEL Consulting Engineers Structural Design 9055 Comprint Court, SUITE 370 301 258 8884

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PROJECT INFORMATION **PROJECT TITLE**

MYERSVILLE

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PROJECT OWNER

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PROJECT TEAM



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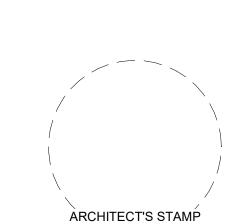
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STRUCTURAL ENGINEER

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SHEET INFORMATION KEY PLAN

	<u>revisions</u>					
REV. #:	DESCRIPTION:	DATE:				

PROJECT STATUS

JOB NUMBER: 10 APRIL 2018 ISSUE DATE: As indicated SHEET TITLE: **GENERAL NOTES**

SHEET NUMBER:

ABV AFF	ABOVE ABOVE FINISHED FLOOR	AHU ERV	AIR HANDLING U	JNIT /ERY VENTILATOR
AHJ AMP	AUTHORITY HAVING JURISDICTION AMPERE	EWH HP	ELECTRIC WALL HEAT PUMP	
ANSI APD	AMERICAN NATIONAL STANDARDS INSTITUTE AIR PRESSURE DROP			
ASHRAE	AIR-CONDITIONING ENGINEERS			
ASME AWG	AMERICAN SOCIETY OF MECHANICAL ENGINEERS AMERICAN WIRE GAUGE	HVA	C PIPING A	ABBREVIATIONS
BAS BDD	BUILDING AUTOMATION SYSTEM BACK DRAFT DAMPER			
BHP BLDG	BRAKE HORSE POWER BUILDING		- CDL	CONDENSATE DRAIN LINE
BTU	BRITISH THERMAL UNIT		- RL	REFRIGERANT LIQUID
CFM CO	CUBIC FEET PER MINUTE CLEAN OUT		- RS ———	REFRIGERANT SUCTION
CONC	CONCRETE CONDENSATE			
CONN CONST CONT	CONNECTION CONSTRUCTION CONTINUATION			
CONTR	CONTRACTOR	HVAC	PIPING S	SYMBOLS .
DB DEG (°)	DRY BULB TEMPERATURE DEGREE		0	PIPE ELBOW UP
DIA DIFF	DIAMETER DIFFUSER		e	PIPE ELBOW DOWN
DISCH DN	DISCHARGE DOWN			
DPR DWG	DAMPER DRAWING		-	DIRECTION OF FLOW
EA	EXHAUST AIR		E	CAPPED PIPE
EAT EDB	ENTERING AIR TEMPERATURE ENTERING DRY BULB		CO	CLEAN OUT
EL EQUIP	ELEVATION EQUIPMENT		Υ	
ETC ESP	ETCETERA EXTERNAL STATIC PRESSURE			
EWB EXH	ENTERING WET BULB EXHAUST			
F	FAHRENHEIT EDEE ADEA			
FA FC FPM	FREE AREA FLEXIBLE CONNECTION FEET PER MINUTE			
FR FT	FROM FEET			
GR	GRILLE			
HP	HORSE POWER			
HORIZ HZ	HORIZONTAL FREQUENCY (HERTZ)			
ID INCLII	INSIDE DIAMETER			
INSUL JT	INSULATION JOINT			
KW	KILOWATT			
LAT	LEAVING AIR TEMPERATURE			
LBS LDB	POUNDS LEAVING DRY BULB			
LF LIQ	LINEAR FEET LIQUID			
LSDS LSDR	LINEAR SLOT DIFFUSER SUPPLY LINEAR SLOT DIFFUSER RETURN			
LWB MAX	LEAVING WET BULB MAXIMUM			
MBH MFGR	THOUSAND BTU'S MANUFACTURER			
MIN MTD	MINIMUM MOUNTED			
N/A	NOT APPLICABLE			
NTS	NOT TO SCALE			
OA	OUTSIDE AIR			
OPNG	OPENING DEPOENT			
% PC PD	PERCENT PLUMBING CONTRACTOR PRESSURE DROP			
PD PG PH	PRESSURE DROP PRESSURE GAUGE WITH COCK PHASE			
PPD PPM	PHASE PERFORATED PLATE DAMPER PARTS PER MILLION			
PRESS PRV	PRESSURE PRESSURE REDUCING VALVE			
PS PSF	PRESSURE REDUCING VALVE PIPE SUPPORT POUNDS PER SQUARE FOOT			
PSIA PSIG	POUNDS PER SQUARE INCH ABSOLUTE POUNDS PER SQUARE INCH GAUGE			
PT PV	PRESSURE TAP PLUG VALVE			
QNTY	QUANTITY			
RA DEEDIC	RETURN AIR			
REFRIG REQD RET	REFRIGERANT REQUIRED RETURN			
RET RH RPM	RETURN RELATIVE HUMIDITY REVOLUTIONS PER MINUTE			
171				
SA SCH	SUPPLY AIR SCHEDULE			
SENS SP	SENSIBLE STATIC PRESSURE			
SPEC SQ FT	SPECIFICATION SQUARE FEET			
STD STR	STANDARD STRAINER			
SUCT SUP	SUCTION SUPPLY			
TAB	TEST, ADJUST AND BALANCE			
TEMP TONS	TEMPERATURE TONS OF REFRIGERATION			
TOT TRANS	TOTAL TRANSITION			
T'STAT TSP	THERMOSTAT TOTAL STATIC PRESSURE			
TV	TURNING VANES			
UNO	UNLESS NOTED OTHERWISE			
V	VOLT			
W W/	WATT WITH			
WB WT	WET BULB WEIGHT			

HVAC SYMBOLS ELECTRICAL REQUIREMENTS FOR MECHANICAL EQUIPMENT

THERMOSTAT GENERAL REQUIREMENTS NUMBERED NOTES

REVISION SEQUENCE (TAG)(THROWS) GRILLE, REGISTER AND DIFFUSER TAG

SUPPLY DIFFUSER - 4-WAY BLOW AIR FLOW ARROW

> LINEAR SLOT DIFFUSER WALL MOUNTED SUPPLY GRILLE / REGISTER

> > TOWARD VIEWER

AWAY FROM VIEWER

OUTSIDE AIR DUCT

TOWARD VIEWER

OUTSIDE AIR DUCT

AWAY FROM VIEWER

CHANGE IN DUCT ELEVATION

CHANGE IN DUCT ELEVATION

DROP INDICATED BY "D"

RISE INDICATED BY "R"

FLEXIBLE CONNECTION

MANUAL VOLUME DAMPER

TRANSITION; SYMMETRIC

RECTANGULAR TO ROUND

90 DEG RADIUS ELBOW

MITERED ELBOW WITH

TEE, BOOT ENTRY BRANCH

TEE, ROUND BRANCH

TURNING VANES

(R/W = 1.5)

FLEXIBLE DUCT

RETURN OR EXHAUST DUCT

WALL MOUNTED RETURN OR EXHAUST GRILLE / REGISTER

CEILING MOUNTED RETURN OR EXHAUST GRILLE / REGISTER INTERIOR CLEAR DUCTWORK 24/12 DIMENSIONS; WIDTH/HEIGHT

E. IT SHALL BE THE RESPONSIBILITY OF THE HEATING AND SUPPLY DUCT ELECTRICAL CONTRACTORS TO CHECK FOR ADEQUACY OF TOWARD VIEWER SUPPLY WIRING, OVERCURRENT PROTECTION, PROPER VOLTAGE, PHASE ROTATION AND FINAL LOCATION OF SUPPLY DUCT AWAY EQUIPMENT PROVIDED PRIOR TO THE RUNNING OF ANY FROM VIEWER CONDUIT OR WIRING. COORDINATE WITH DIVISION 26 TO ASSURE PROPER ELECTRICAL SERVICE IS PROVIDED TO RETURN OR EXHAUST DUCT EQUIPMENT UNDER DIVISION 23.

> F. EQUIPMENT CONNECTIONS SHALL BE MADE THROUGH CONDUIT OR RACEWAYS IN ACCORDANCE WITH DIVISION 26, WITH THE EXCEPTION THAT CONNECTIONS TO MOTORS SHALL BE MADE THROUGH LIQUID TIGHT FLEXIBLE METAL CONDUIT WITH EQUIPMENT GROUNDING CONDUCTOR.

A. HVAC CONTRACTOR SHALL PROVIDE MECHANICAL EQUIPMENT

B. ALL STARTERS, DISCONNECT SWITCHES, MOTOR CONTROL

PROVIDED UNDER DIVISION 23, SHALL BE FURNISHED UNDER

MOUNTED STARTERS, DISCONNECTS SWITCHES, AND VARIABLE

CENTERS AND VARIABLE FREQUENCY DRIVES IN ACCORDANCE

C. HVAC CONTRACTOR SHALL SUBMIT WIRING DIAGRAMS TO THE

APPROVED DIAGRAMS TO THE ELECTRICAL CONTRACTOR SO

OTHER DIVISIONS AND TRADES ON THE PROJECT, AND THEIR

PROTECTION, CONTROL EQUIPMENT AND WIRING, AND THE

MANUFACTURERS, IN PROMPTLY PROVIDING THE INFORMATION

ARCHITECT/ENGINEER FOR APPROVAL AND PROVIDE

D. HVAC CONTRACTOR SHALL FULLY COOPERATE WITH THE

REQUIRED FOR PROPER COORDINATION OF MOTOR

OTHER CHARACTERISTICS OF THE EQUIPMENT.

THAT THE ELECTRICAL WORK MAY BE PROPERLY

DIVISION 23 AND INSTALLED UNDER DIVISION 26. FACTORY

FREQUENCY DRIVES SHALL BE FURNISHED AND INSTALLED

UNDER DIVISION 23. HVAC CONTRACTOR SHALL PROVIDE

STARTERS, DISCONNECT SWITCHES, MOTOR CONTROL

INDICATED ON THE DRAWINGS AND WITHIN THE

SPECIFICATIONS.

WITH DIVISION 26.

ACCOMPLISHED.

POWER REQUIREMENTS A. ALL POWER WIRING FOR MECHANICAL EQUIPMENT PROVIDED UNDER DIVISION 23 SHALL BE FURNISHED AND INSTALLED UNDER DIVISION 26 TO THE POINT OF FINAL CONNECTION (FROM THE SOURCE TO THE STARTERS, DISCONNECT SWITCHES, MCC'S OR VFD'S AND TO EQUIPMENT, MOTOR, OR OTHER CONNECTION POINT). EXCEPT WHERE SPECIFICALLY INDICATED OTHERWISE, ALL POWER WIRING TO THE POINT OF FINAL CONNECTION FOR EQUIPMENT PROVIDED UNDER DIVISION 23

SHALL BE ACCOMPLISHED UNDER DIVISION 26.

B. FINAL ELECTRICAL POWER CONNECTIONS TO ALL EQUIPMENT SHALL BE FURNISHED AND INSTALLED UNDER DIVISION 26. IN GENERAL, THE POINT OF FINAL CONNECTION SHALL BE THE TERMINAL HOUSING ON THE EQUIPMENT, MOTOR, OR AN INTERNAL JUNCTION BOX ON THE EQUIPMENT OR ITEM. IF NO JUNCTION BOX IS FURNISHED, A JUNCTION BOX SHALL BE FURNISHED AND INSTALLED UNDER DIVISION 26. WIRE LEADS OF ADEQUATE LENGTH TO ENSURE A PROPER CONNECTION AT THE FINAL LOCATION SHALL BE FURNISHED AND INSTALLED UNDER DIVISION 26.

C. WIRING, OVERCURRENT PROTECTION DEVICES, VOLTAGE, PHASE, ROTATION AND FINAL LOCATION OF ALL EQUIPMENT PROVIDED UNDER DIVISION 23 SHALL BE COORDINATED WITH ALL SIMILAR DEVICES AND POWER WIRING FURNISHED AND INSTALLED UNDER DIVISION 26. COORDINATION SHALL BE ACCOMPLISHED PRIOR TO THE RUNNING OF ANY CONDUIT OR

3. CONTROL REQUIREMENTS A. ALL CONTROL WIRING (LINE VOLTAGE AND/OR LOW VOLTAGE) FOR MECHANICAL EQUIPMENT PROVIDED UNDER DIVISION 23, SHALL BE FURNISHED AND INSTALLED UNDER DIVISION 23. WIRING FROM THE POWER SOURCE TO ALL CONTROL PANELS, DDC CONTROL PANELS, STARTERS, OPERATOR WORK STATIONS (PC'S, PRINTERS, MONITORS, AND OTHER WORK STATION EQUIPMENT) AND OTHER CONTROL EQUIPMENT REQUIRED FOR A COMPLETE AND OPERABLE CONTROL SYSTEM SERVING MECHANICAL EQUIPMENT PROVIDED UNDER DIVISION 23 SHALL BE FURNISHED AND INSTALLED UNDER DIVISION 23.

B. ALL WIRING FROM CONTROL PANELS TO CONTROL DEVICES FOR MECHANICAL EQUIPMENT PROVIDED UNDER DIVISION 23 SHALL BE FURNISHED AND INSTALLED UNDER DIVISION 23. ALL CONTROL WIRE AND CONDUIT SHALL COMPLY WITH THE NATIONAL ELECTRIC CODE AND DIVISION 26 OF THE SPECIFICATIONS. ALL CONTROL WIRING SHALL BE IN CONDUIT.

C. UNLESS OTHERWISE NOTED, ALL TEMPERATURE CONTROL DEVICES, INSTALLED PILOT DEVICES, AND ALL ASSOCIATED PILOT CONTROL EQUIPMENT, FOR ALL EQUIPMENT PROVIDED UNDER DIVISION 23, SHALL BE FURNISHED AND INSTALLED UNDER DIVISION 23.

D. ELECTRICAL CONTROL WIRING FOR CONNECTION OF TEMPERATURE CONTROLLERS, PUSH BUTTONS, INTERLOCKS IN MOTOR CONTROLLERS, PNEUMATIC SWITCHES AND LIKE ITEMS IS SPECIFIED UNDER THE CONTROL SECTION(S) IN DIVISION 23 AND INSTALLED BY DIVISION 23.

E. ALL MOTORS, MOUNTS, REMOTE MOUNTED PUSH BUTTON CONTROLS AND ALL SPEED CONTROL SWITCHES FOR MULTI-SPEED MOTORS FOR ALL EQUIPMENT PROVIDED UNDER DIVISION 23 SHALL BE FURNISHED AND INSTALLED UNDER DIVISION 23.

PROJECT GENERAL NOTES

1. FREDERICK COUNTY SHALL BE RESPONSIBLE FOR THE PURCHASE AND INSTALLATION OF THE MITSUBISHI VRF EQUIPMENT AND ALL ASSOCIATED DUCTWORK, AIR DEVICE, INSULATION, REFRIGERANT LINES, AND CONTROLS, WITH EXCEPTION OF ALL ASSOCIATED EXTERIOR WALL PENETRATIONS AND LOUVERS, WHICH SHALL BE WITH VOLTAGES AND OTHER ELECTRICAL CHARACTERISTICS AS PROVIDED BY THE GENERAL/MECHANICAL CONTRACTOR. THE MECHANICAL CONTRACTOR SHALL BE RESPONSIBLE FOR ALL OTHER WORK INDICATED ON THE MECHANICAL DRAWINGS AND IN THE MECHANICAL SPECIFICATIONS, INCLUDING ELECTRIC HEATERS. THE ELECTRICAL CONTRACTOR SHALL BE RESPONSIBLE FOR THE ELECTRICAL CONNECTIONS TO THE COMPLETE HVAC SYSTEM. CENTERS, AND VARIABLE FREQUENCY DRIVES, FOR EQUIPMENT INCLUDING THE PORTION THAT FREDERICK COUNTY INSTALLS. THE PLUMBING CONTRACTOR SHALL BE RESPONSIBLE FOR THE PLUMBING INSTALLATION ASSOCIATED WITH THE COMPLETE HVAC INSTALLATION. INCLUDING CONDENSATE DRAIN PIPING AND PIPING INSULATION FOR THE VRF EQUIPMENT. SPECIFICATIONS REGARDING THE FREDERICK COUNTY INSTALLATION ARE FOR INFORMATIONAL PURPOSES ONLY. IT SHALL BE THE SUCCESSFUL CONTRACTOR'S RESPONSIBILITY TO COORDINATE AND SCHEDULE THE INSTALLATION OF THESE SYSTEMS WITH FREDERICK COUNTY'S INSTALLATION

- PROVIDE ALL MATERIALS AND EQUIPMENT AND PERFORM ALL LABOR REQUIRED TO INSTALL COMPLETE AND OPERABLE MECHANICAL SYSTEMS AS INDICATED ON THE DRAWINGS, AS SPECIFIED AND AS REQUIRED BY CODE.
- CONTRACT DOCUMENT DRAWINGS FOR MECHANICAL WORK ARE DIAGRAMMATIC AND ARE INTENDED TO CONVEY SCOPE AND GENERAL ARRANGEMENT ONLY.
- INSTALL ALL MECHANICAL EQUIPMENT AND APPURTENANCES IN ACCORDANCE WITH MANUFACTURERS' RECOMMENDATIONS. CONTRACT DOCUMENTS AND APPLICABLE CODES AND REGULATIONS.
- PROVIDE VIBRATION ISOLATION FOR ALL MECHANICAL EQUIPMENT TO PREVENT TRANSMISSION OF VIBRATION TO BUILDING STRUCTURE.
- PROVIDE VIBRATION ISOLATORS FOR ALL PIPING SUPPORTS CONNECTED TO, AND WITHIN 50 FT OF ISOLATED EQUIPMENT (EXCEPT AT BASE ELBOW SUPPORTS AND ANCHOR POINTS) THROUGHOUT MECHANICAL EQUIPMENT ROOMS. DO THE SAME FOR SUPPORTS OF STEAM MAINS WITHIN 50 FT OF BOILER OR PRESSURE-REDUCING VALVES.
- THE LOCATION OF EXISTING EQUIPMENT AND UTILITIES IS SHOWN IN AN APPROXIMATE WAY ONLY. THE CONTRACTOR SHALL DETERMINE THE EXACT LOCATION OF ALL EXISTING UTILITIES BEFORE COMMENCING WORK. THE CONTRACTOR SHALL PAY FOR AND REPAIR ALL DAMAGES CAUSED BY FAILURE TO EXACTLY LOCATE AND PRESERVE ANY AND ALL UNDERGROUND UTILITIES UNLESS OTHERWISE INDICATED.
- COORDINATE CONSTRUCTION OF ALL MECHANICAL WORK WITH ARCHITECTURAL, STRUCTURAL, CIVIL, ELECTRICAL WORK, ETC., SHOWN ON OTHER CONTRACT DOCUMENT DRAWINGS.
- MAINTAIN A MINIMUM OF 6'-8" CLEARANCE TO THE UNDERSIDE OF PIPES, DUCTS, CONDUITS, SUSPENDED EQUIPMENT, ETC., THROUGHOUT ACCESS ROUTES IN MECHANICAL ROOMS.
- 10. ALL TESTS SHALL BE COMPLETED BEFORE ANY MECHANICAL EQUIPMENT OR PIPING INSULATION IS APPLIED.
- 11. TESTING, ADJUSTING, AND BALANCING AGENCY SHALL BE A MEMBER OF THE ASSOCIATED AIR BALANCE COUNCIL (AABC) OR THE NATIONAL ENVIRONMENTAL BALANCING BUREAU (NEBB). TESTING, ADJUSTING, AND BALANCING SHALL BE PERFORMED IN ACCORDANCE WITH THE AABC STANDARDS.
- 12. WHERE TWO OR MORE ITEMS OF THE SAME TYPE OF EQUIPMENT ARE REQUIRED, THE PRODUCT OF ONE MANUFACTURER SHALL BE
- 13. COORDINATE ALL EQUIPMENT CONNECTIONS WITH MANUFACTURERS' CERTIFIED DRAWINGS. COORDINATE AND PROVIDE ALL DUCT AND PIPING TRANSITIONS REQUIRED FOR FINAL EQUIPMENT CONNECTIONS TO FURNISHED EQUIPMENT. FIELD VERIFY AND COORDINATE ALL DUCT AND PIPING DIMENSIONS BEFORE FABRICATION.
- 14. ALL CONTROL WIRE AND CONDUIT SHALL COMPLY WITH THE NATIONAL ELECTRIC CODE AND DIVISION 26 OF THE SPECIFICATION.
- 15. WHEN MECHANICAL WORK IS SUBCONTRACTED, IT SHALL BE THE MECHANICAL CONTRACTOR'S RESPONSIBILITY TO COORDINATE SUBCONTRACTORS AND THE ASSOCIATED CONTRACTS. WHEN DISCREPANCIES ARISE PERTAINING TO WHICH CONTRACTOR PROVIDED A PARTICULAR ITEM OF THE MECHANICAL CONTRACT OR WHICH CONTRACTOR PROVIDES FINAL CONNECTIONS FOR A PARTICULAR ITEM OF THE MECHANICAL CONTRACT, IT SHALL BE BROUGHT TO THE ATTENTION OF THE MECHANICAL CONTRACTOR, WHOSE DECISION SHALL BE FINAL.
- THE LOCATIONS OF ALL ITEMS SHOWN ON THE DRAWINGS OR CALLED FOR IN THE SPECIFICATIONS THAT ARE NOT DEFINITELY FIXED BY DIMENSIONS ARE APPROXIMATE ONLY. THE EXACT LOCATIONS NECESSARY TO SECURE THE BEST CONDITIONS AND RESULTS MUST BE DETERMINED BY THE PROJECT SITE CONDITIONS AND SHALL HAVE THE APPROVAL OF THE ENGINEER BEFORE BEING INSTALLED. DO NOT SCALE DRAWINGS.
- 17. ALL MISCELLANEOUS STEEL REQUIRED TO ENSURE PROPER INSTALLATION AND AS SHOWN IN DETAILS FOR PIPING, DUCTWORK AND EQUIPMENT (UNLESS OTHERWISE NOTED) SHALL BE FURNISHED AND INSTALLED BY THE MECHANICAL CONTRACTOR.
- 18. PROVIDE ACCESS PANELS FOR INSTALLATION IN WALLS AND CEILINGS, WHERE REQUIRED TO SERVICE DAMPERS, VALVES, SMOKE DETECTORS AND OTHER CONCEALED MECHANICAL EQUIPMENT. ACCESS PANELS SHALL BE TURNED OVER TO THE GENERAL CONTRACTOR FOR INSTALLATION.
- 19. ALL EQUIPMENT, PIPING, DUCTWORK, ETC. SHALL BE SUPPORTED AS DETAILED, SPECIFIED AND REQUIRED TO PROVIDE A VIBRATION-FREE INSTALLATION.
- 20. ALL DUCTWORK, PIPING AND EQUIPMENT SUPPORTED FROM STRUCTURAL STEEL SHALL BE COORDINATED WITH THE GENERAL CONTRACTOR. ALL ATTACHMENTS TO STEEL BAR JOISTS, TRUSSES, OR JOISTS GIRDERS SHALL BE AT PANEL POINTS. PROVIDE BEAM CLAMPS MEETING MSS STANDARDS. WELDING TO STRUCTURAL MEMBERS SHALL NOT BE PERMITTED. THE USE OF C-CLAMPS SHALL NOT BE PERMITTED.
- 21. MECHANICAL EQUIPMENT, DUCTWORK, AND PIPING SHALL NOT SUPPORTED FROM A METAL DECK.
- 22. LOCATIONS AND SIZES OF FLOOR, WALL AND ROOF OPENINGS SHALL BE COORDINATED WITH ALL OTHER TRADES INVOLVED.
- 23. ALL AIR CONDITIONING CONDENSATE DRAIN LINES FROM EACH AIR HANDLING UNIT AND ROOFTOP UNIT SHALL BE PIPED FULL SIZE OF THE UNIT DRAIN OUTLET WITH A "P" TRAP AND PIPED TO THE NEAREST DRAIN. SEE THE DETAILS SHOWN ON THE DRAWINGS OR THE CONTRACT SPECIFICATIONS FOR THE DEPTH OF THE AIR CONDITIONING CONDENSATE TRAP.
- 24. CONTRACTOR SHALL DETERMINE THE EXACT LOCATION OF ALL EXISTING EQUIPMENT AND UTILITIES BEFORE COMMENCING WORK.

SHEET METAL GENERAL NOTES

1. ALL DUCTWORK DIMENSIONS, AS SHOWN ON THE DRAWINGS, ARE INTERNAL CLEAR DIMENSIONS AND DUCT SIZE SHALL BE INCREASED TO COMPENSATE FOR DUCT LINING THICKNESS WHERE SPECIFIED.

- CERTAIN ITEMS SUCH AS RISES AND DROPS IN DUCTWORK, ACCESS DOORS, VOLUME DAMPERS, ETC. ARE INDICATED ON THE CONTRACT DOCUMENT DRAWINGS FOR CLARITY FOR A SPECIFIC LOCATION REQUIREMENT AND SHALL NOT BE INTERPRETED AS THE EXTENT OF THE REQUIREMENTS FOR THESE ITEMS.
- 3. ALL DUCTWORK SHALL BE COORDINATED WITH ALL TRADES INVOLVED. OFFSETS IN DUCTS, INCLUDING DIVIDED DUCTS AND TRANSITIONS AROUND OBSTRUCTIONS, SHALL BE PROVIDED AT NO ADDITIONAL COST TO THE OWNER.
- UNLESS OTHERWISE NOTED, ALL DUCTWORK SHALL BE OVERHEAD, TIGHT TO THE UNDERSIDE OF THE STRUCTURE, WITH SPACE FOR INSULATION IF REQUIRED.
- 5. PROVIDE ACCESS DOORS IN DUCTWORK FOR THE OPERATION, ADJUSTMENT, AND MAINTENANCE OF ALL FANS, VALVES, AND MECHANICAL EQUIPMENT.
- 6. SEE SPECIFICATIONS FOR DUCTWORK GAUGES, BRACING, HANGERS, AND OTHER REQUIREMENTS.
- 7. RUNS OF FLEXIBLE DUCT SHALL NOT EXCEED 5 FEET.
- 8. ALL AIR HANDING UNITS SHALL OPERATE WITHOUT MOISTURE CARRYOVER.
- 9. PROVIDE FLEXIBLE CONNECTIONS IN ALL DUCTWORK SYSTEMS (SUPPLY, RETURN, AND EXHAUST) CONNECTED TO AIR HANDLING UNITS, FANS, AND OTHER EQUIPMENT THAT REQUIRE VIBRATION ISOLATION. FLEXIBLE CONNECTIONS SHALL BE PROVIDED AT THE POINT OF CONNECTION TO THE EQUIPMENT UNLESS OTHERWISE INDICATED.
- 10. ALL DUCTS SHALL BE GROUNDED ACROSS FLEXIBLE CONNECTIONS WITH FLEXIBLE COPPER GROUNDING STRAPS. GROUNDING STRAPS SHALL BE BOLTED OR SOLDERED TO BOTH THE EQUIPMENT AND THE
- 11. COORDINATE DIFFUSERS, REGISTER AND GRILLE LOCATIONS WITH ARCHITECTURAL REFLECTED CEILING PLANS, LIGHTING AND OTHER CEILING ITEMS AND MAKE MINOR DUCT MODIFICATIONS TO SUIT.
- 12. UNLESS OTHERWISE SHOWN, LOCATE ALL ROOM THERMOSTATS AND HUMIDISTATS 42" (CENTERLINE) ABOVE THE FINISHED FLOOR. NOTIFY THE PROFESSIONAL OF ANY ROOMS WHERE THE PRECEDING LOCATION CANNOT BE MAINTAINED OR WHERE THERE IS A QUESTION ON LOCATION.
- 13. EXTERIOR LOUVERS ARE INDICATED FOR INFORMATION ONLY. LOUVER SIZES, LOCATIONS, AND DETAILS SHALL BE COORDINATED WITH THE GENERAL CONTRACTOR.

HVAC PIPING GENERAL NOTES

- 1. ALL PIPING WORK SHALL BE COORDINATED WITH ALL TRADES INVOLVED. OFFSETS IN PIPING AROUND OBSTRUCTIONS SHALL BE PROVIDED AT NO ADDITIONAL COST TO THE OWNER.
- 2. UNI ESS OTHERWISE NOTED, ALL PIPING IS OVERHEAD, TIGHT TO THE UNDERSIDE OF THE STRUCTURE OR SLAB, WITH SPACE FOR INSULATION IF REQUIRED.
- INSTALL PIPING SO ALL VALVES, STRAINERS, UNIONS, TRAPS, FLANGES, AND OTHER APPURTENANCES REQUIRING ACCESS ARE ACCESSIBLE.
- 4. ALL VALVES SHALL BE INSTALLED SO THAT THE VALVE REMAINS IN SERVICE WHEN EQUIPMENT OR PIPING ON THE EQUIPMENT SIDE OF THE
- VALVE IS REMOVED. 5. ALL VALVES (EXCEPT CONTROL VALVES) AND STRAINERS SHALL BE THE
- FULL SIZE OF THE PIPE BEFORE REDUCING IN SIZE TO MAKE CONNECTIONS TO EQUIPMENT AND CONTROLS.
- 6. PROVIDE A LINE SIZE STRAINER UPSTREAM OF EACH AUTOMATIC VALVE. PROVIDE A SHUTOFF VALVE ON EACH SIDE OF A STRAINER.
- 7. UNIONS AND/OR FLANGES SHALL BE INSTALLED AT EACH PIECE OF EQUIPMENT, IN BYPASSES, AND IN LONG PIPING RUNS (100 FT OR MORE) TO PERMIT DISASSEMBLY FOR ALTERNATION AND REPAIRS.
- 8. INSTALL ALL PIPING WITHOUT FORCING OR SPRINGING.
- 9. ALL VALVES SHALL BE ADJUSTED FOR SMOOTH AND EASY OPERATION.
- 10. SLOPE REFRIGERANT PIPING ONE PERCENT IN THE DIRECTION OF OIL RETURN. LIQUID LINES MAY BE INSTALLED LEVEL.
- 11. INSTALL HORIZONTAL REFRIGERANT SUCTION LINES WITH 1/2 INCH PER 10 FEET DOWNWARD SLOPE TO THE COMPRESSOR, WITH NO LONG TRAPS OR DEAD ENDS THAT MAY CAUSE OIL TO SEPARATE FROM THE SUCTION GAS AND RETURN TO THE COMPRESSOR IN DAMAGING SLUGS.

PROJECT TITLE

PROJECT INFORMATION

MYERSVILLE COMMUNITY LIBRARY

PROJECT ADDRESS 8 HARP PLACE MYERSVILLE, MD 21773

PROJECT OWNER FREDERICK COUNTY, **MARYLAND DEPARTMENT OF PUBLIC WORKS**

PROJECT TEAM

<u>ARCHITECT</u>



ASSOCIATES, INC.

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ARCHITECTS

STRUCTURAL ENGINEER ABEL CONSULTING ENGINEERS 9055 COMPRINT COURT, SUITE 370 | GAITHERSBURG, MD | 20878

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P: 301.662.4488 | F: 301.662.4906

Professional Certification. I hereby certify that these documents were prepared or approved by me, and that I am a duly licensed professional engineer under the laws of the State of Maryland.

License No:45511,

Expiration Date: <u>06/03/2020</u>

SHEET INFORMATION


REV. #: DESCRIPTION:

PROJECT STATUS

16-1043 JOB NUMBER: 10 APRIL 2018 ISSUE DATE: **AS INDICATED** SHEET TITLE:

> SYMBOLS, ABBREVIATIONS, AND **NOTES**

SHEET NUMBER:

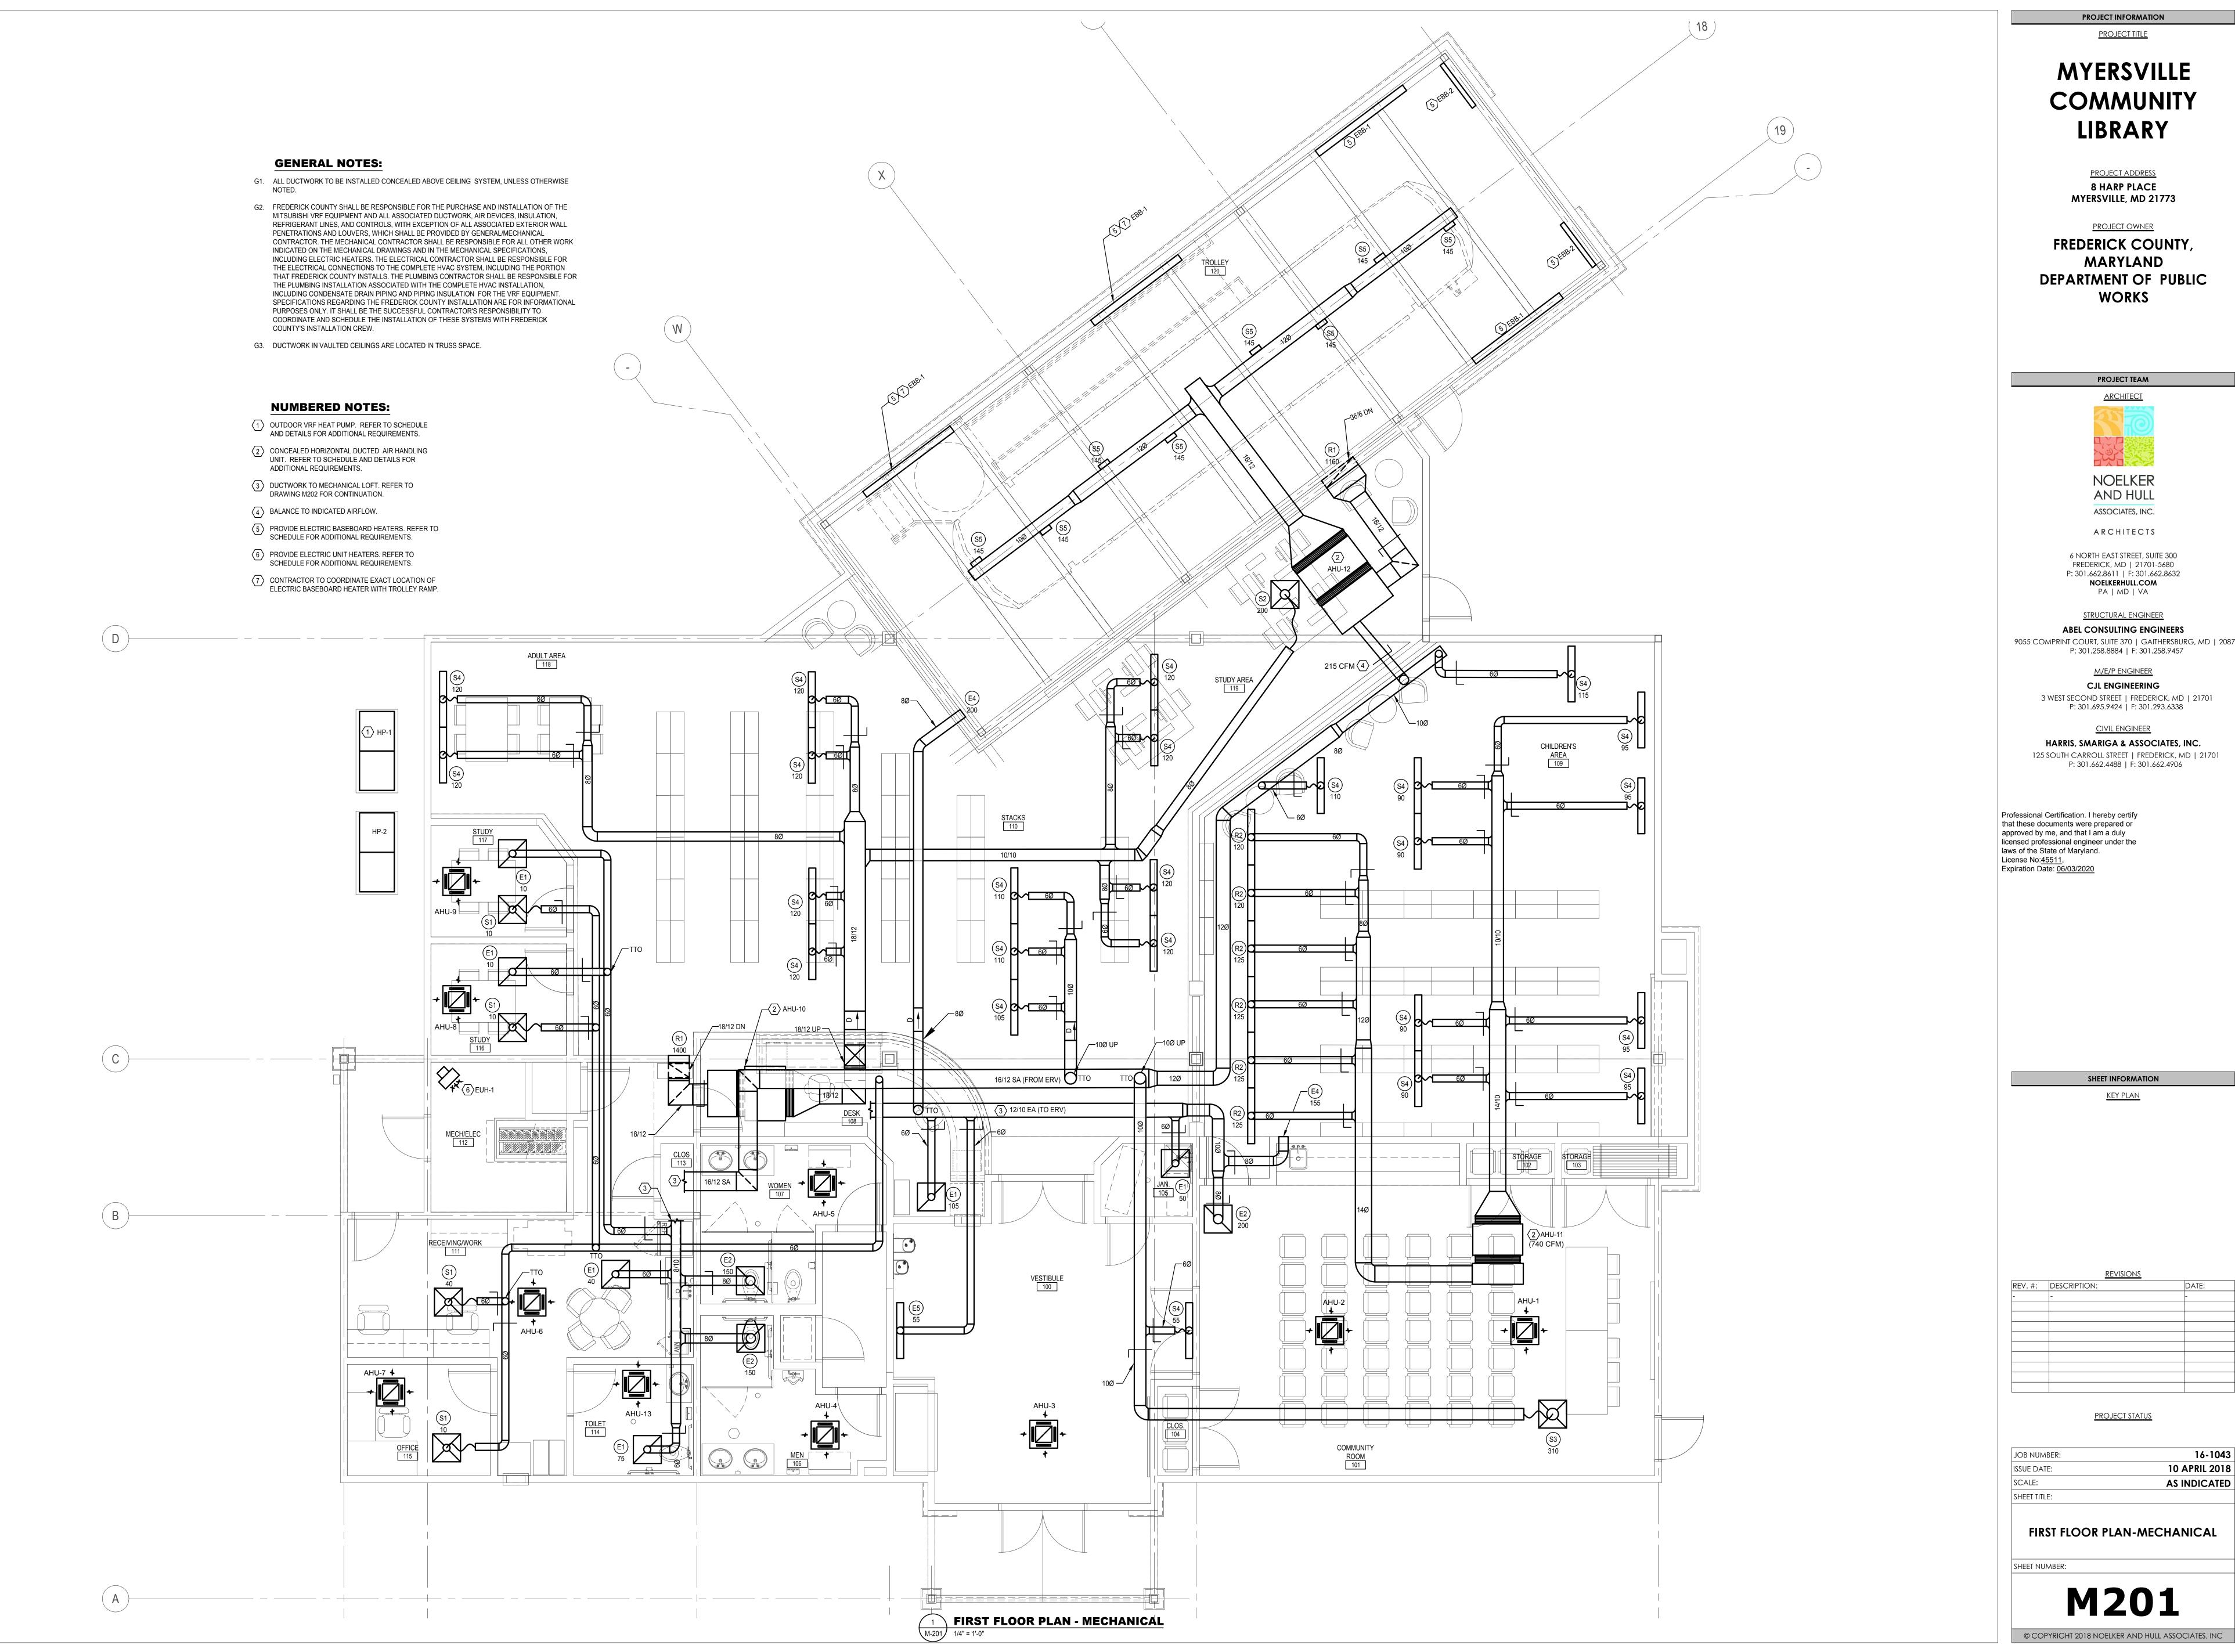

9055 COMPRINT COURT, SUITE 370 | GAITHERSBURG, MD | 20878

GENERAL NOTES:

G1. ALL DUCTWORK TO BE INSTALLED CONCEALED ABOVE CEILING SYSTEM, UNLESS OTHERWISE

G2. FREDERICK COUNTY SHALL BE RESPONSIBLE FOR THE PURCHASE AND INSTALLATION OF THE MITSUBISHI VRF EQUIPMENT AND ALL ASSOCIATED DUCTWORK, AIR DEVICES, INSULATION, REFRIGERANT LINES, AND CONTROLS, WITH EXCEPTION OF ALL ASSOCIATED EXTERIOR WALL PENETRATIONS AND LOUVERS, WHICH SHALL BE PROVIDED BY GENERAL/MECHANICAL CONTRACTOR. THE MECHANICAL CONTRACTOR SHALL BE RESPONSIBLE FOR ALL OTHER WORK INDICATED ON THE MECHANICAL DRAWINGS AND IN THE MECHANICAL SPECIFICATIONS, INCLUDING ELECTRIC HEATERS. THE ELECTRICAL CONTRACTOR SHALL BE RESPONSIBLE FOR THE ELECTRICAL CONNECTIONS TO THE COMPLETE HVAC SYSTEM, INCLUDING THE PORTION THAT FREDERICK COUNTY INSTALLS. THE PLUMBING CONTRACTOR SHALL BE RESPONSIBLE FOR THE PLUMBING INSTALLATION ASSOCIATED WITH THE COMPLETE HVAC INSTALLATION, INCLUDING CONDENSATE DRAIN PIPING AND PIPING INSULATION FOR THE VRF EQUIPMENT. SPECIFICATIONS REGARDING THE FREDERICK COUNTY INSTALLATION ARE FOR INFORMATIONAL PURPOSES ONLY. IT SHALL BE THE SUCCESSFUL CONTRACTOR'S RESPONSIBILITY TO COORDINATE AND SCHEDULE THE INSTALLATION OF THESE SYSTEMS WITH FREDERICK COUNTY'S INSTALLATION CREW.

NUMBERED NOTES:

OUTSIDE AIR DISCHARGE LOUVER AT INDICATED SIZE MINIMUM 50% FREE AREA, LOCATED IN ARCHITECTURAL DORMER.

(2) EXHAUST AIR DISCHARGE LOUVER AT INDICATED SIZE MINIMUM 50% FREE AREA, LOCATED IN ARCHITECTURAL DORMER.

FIELD FABRICATED INSULATED PLENUM AT 22W/18L/22H. PROVIDE TWO (2) CONNECTIONS, TOP


AND BOTTOM, TO ERV.

4 ENERGY RECOVERY VENTILATOR REFER TO SCHEDULE AND DETAIL FOR ADDITIONAL

5 DUCTWORK TO LIBRARY. REFER TO DRAWING M-201

FOR CONTINUATION.

6 DEDICATED OUTSIDE AIR SYSTEM REFER TO SCHEDULE FOR ADDITIONAL REQUIREMENTS.

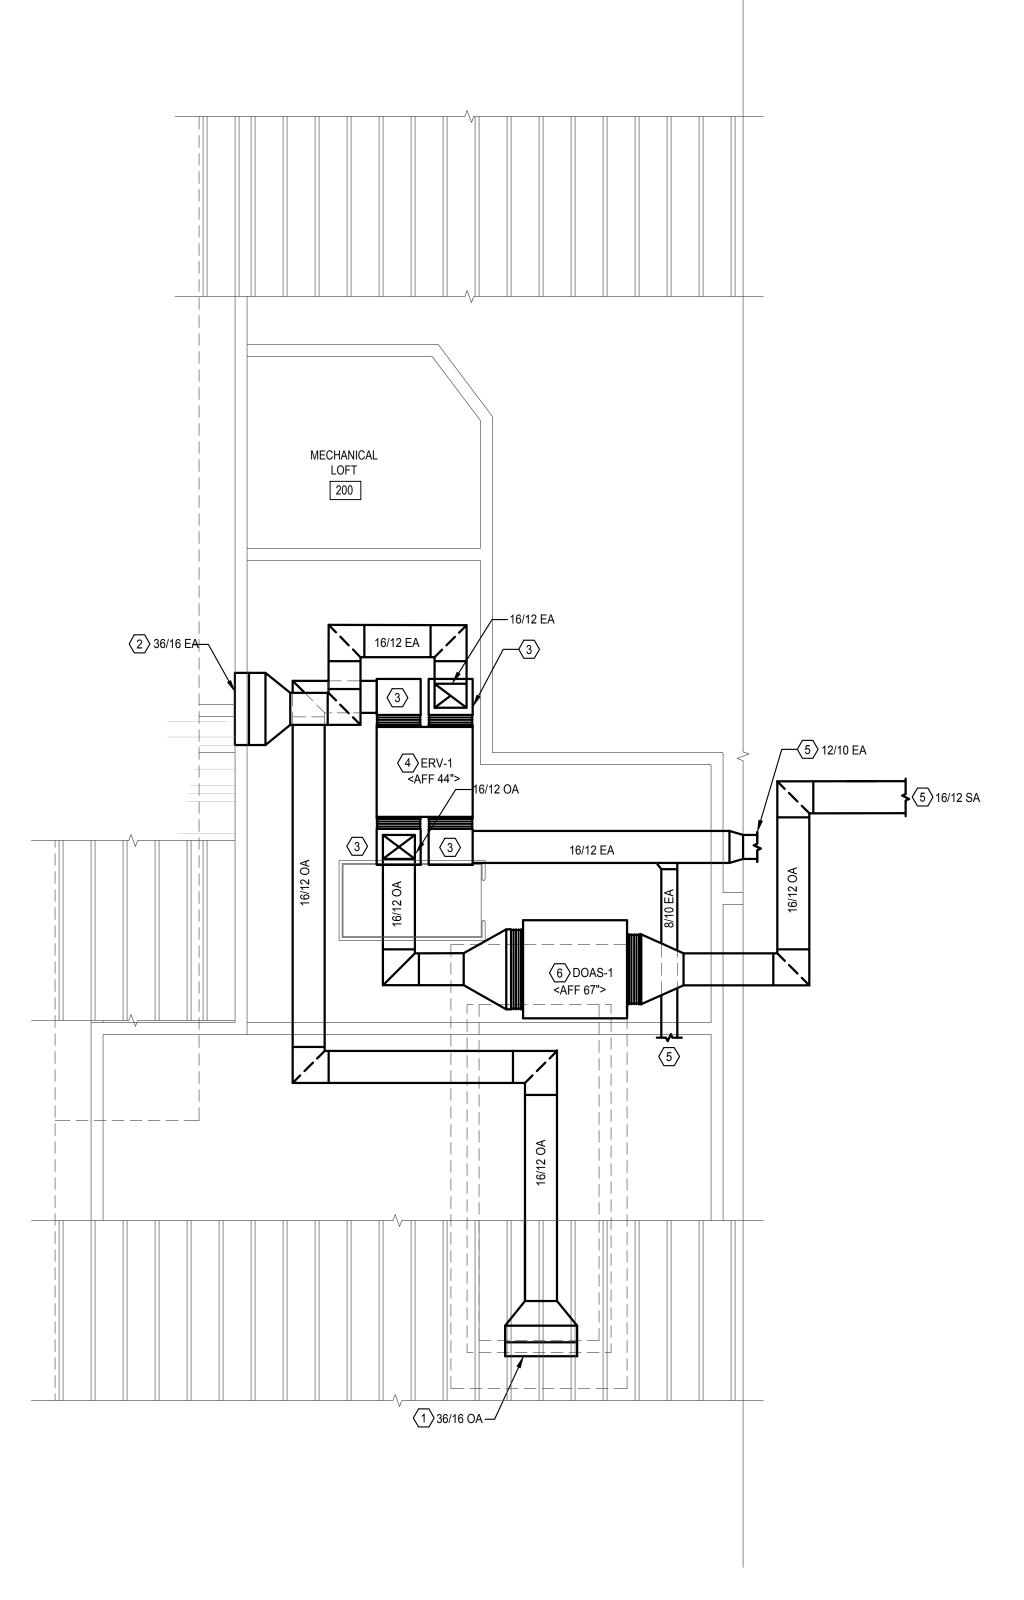

1 PART PLAN LOFT - MECHANICAL
M-202 1/4" = 1'-0"

PROJECT INFORMATION

PROJECT TITLE

MYERSVILLE COMMUNITY LIBRARY

PROJECT ADDRESS

8 HARP PLACE
MYERSVILLE, MD 21773

PROJECT OWNER

FREDERICK COUNTY,

MARYLAND

DEPARTMENT OF PUBLIC

WORKS

PROJECT TEAM



NOELKER AND HULL ASSOCIATES, INC.

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P: 301.662.4488 | F: 301.662.4906

Professional Certification. I hereby certify that these documents were prepared or approved by me, and that I am a duly licensed professional engineer under the laws of the State of Maryland.

License No:45511,

Expiration Date: 06/03/2020

SHEET INFORMATION

KEY PL

REV. #: DESCRIPTION: DATE:
- - -


PROJECT STATUS

JOB NUMBER: 16-1043
ISSUE DATE: 10 APRIL 2018
SCALE: AS INDICATED
SHEET TITLE:

PART PLAN LOFT-MECHANICAL

SHEET NUMBER:

1202

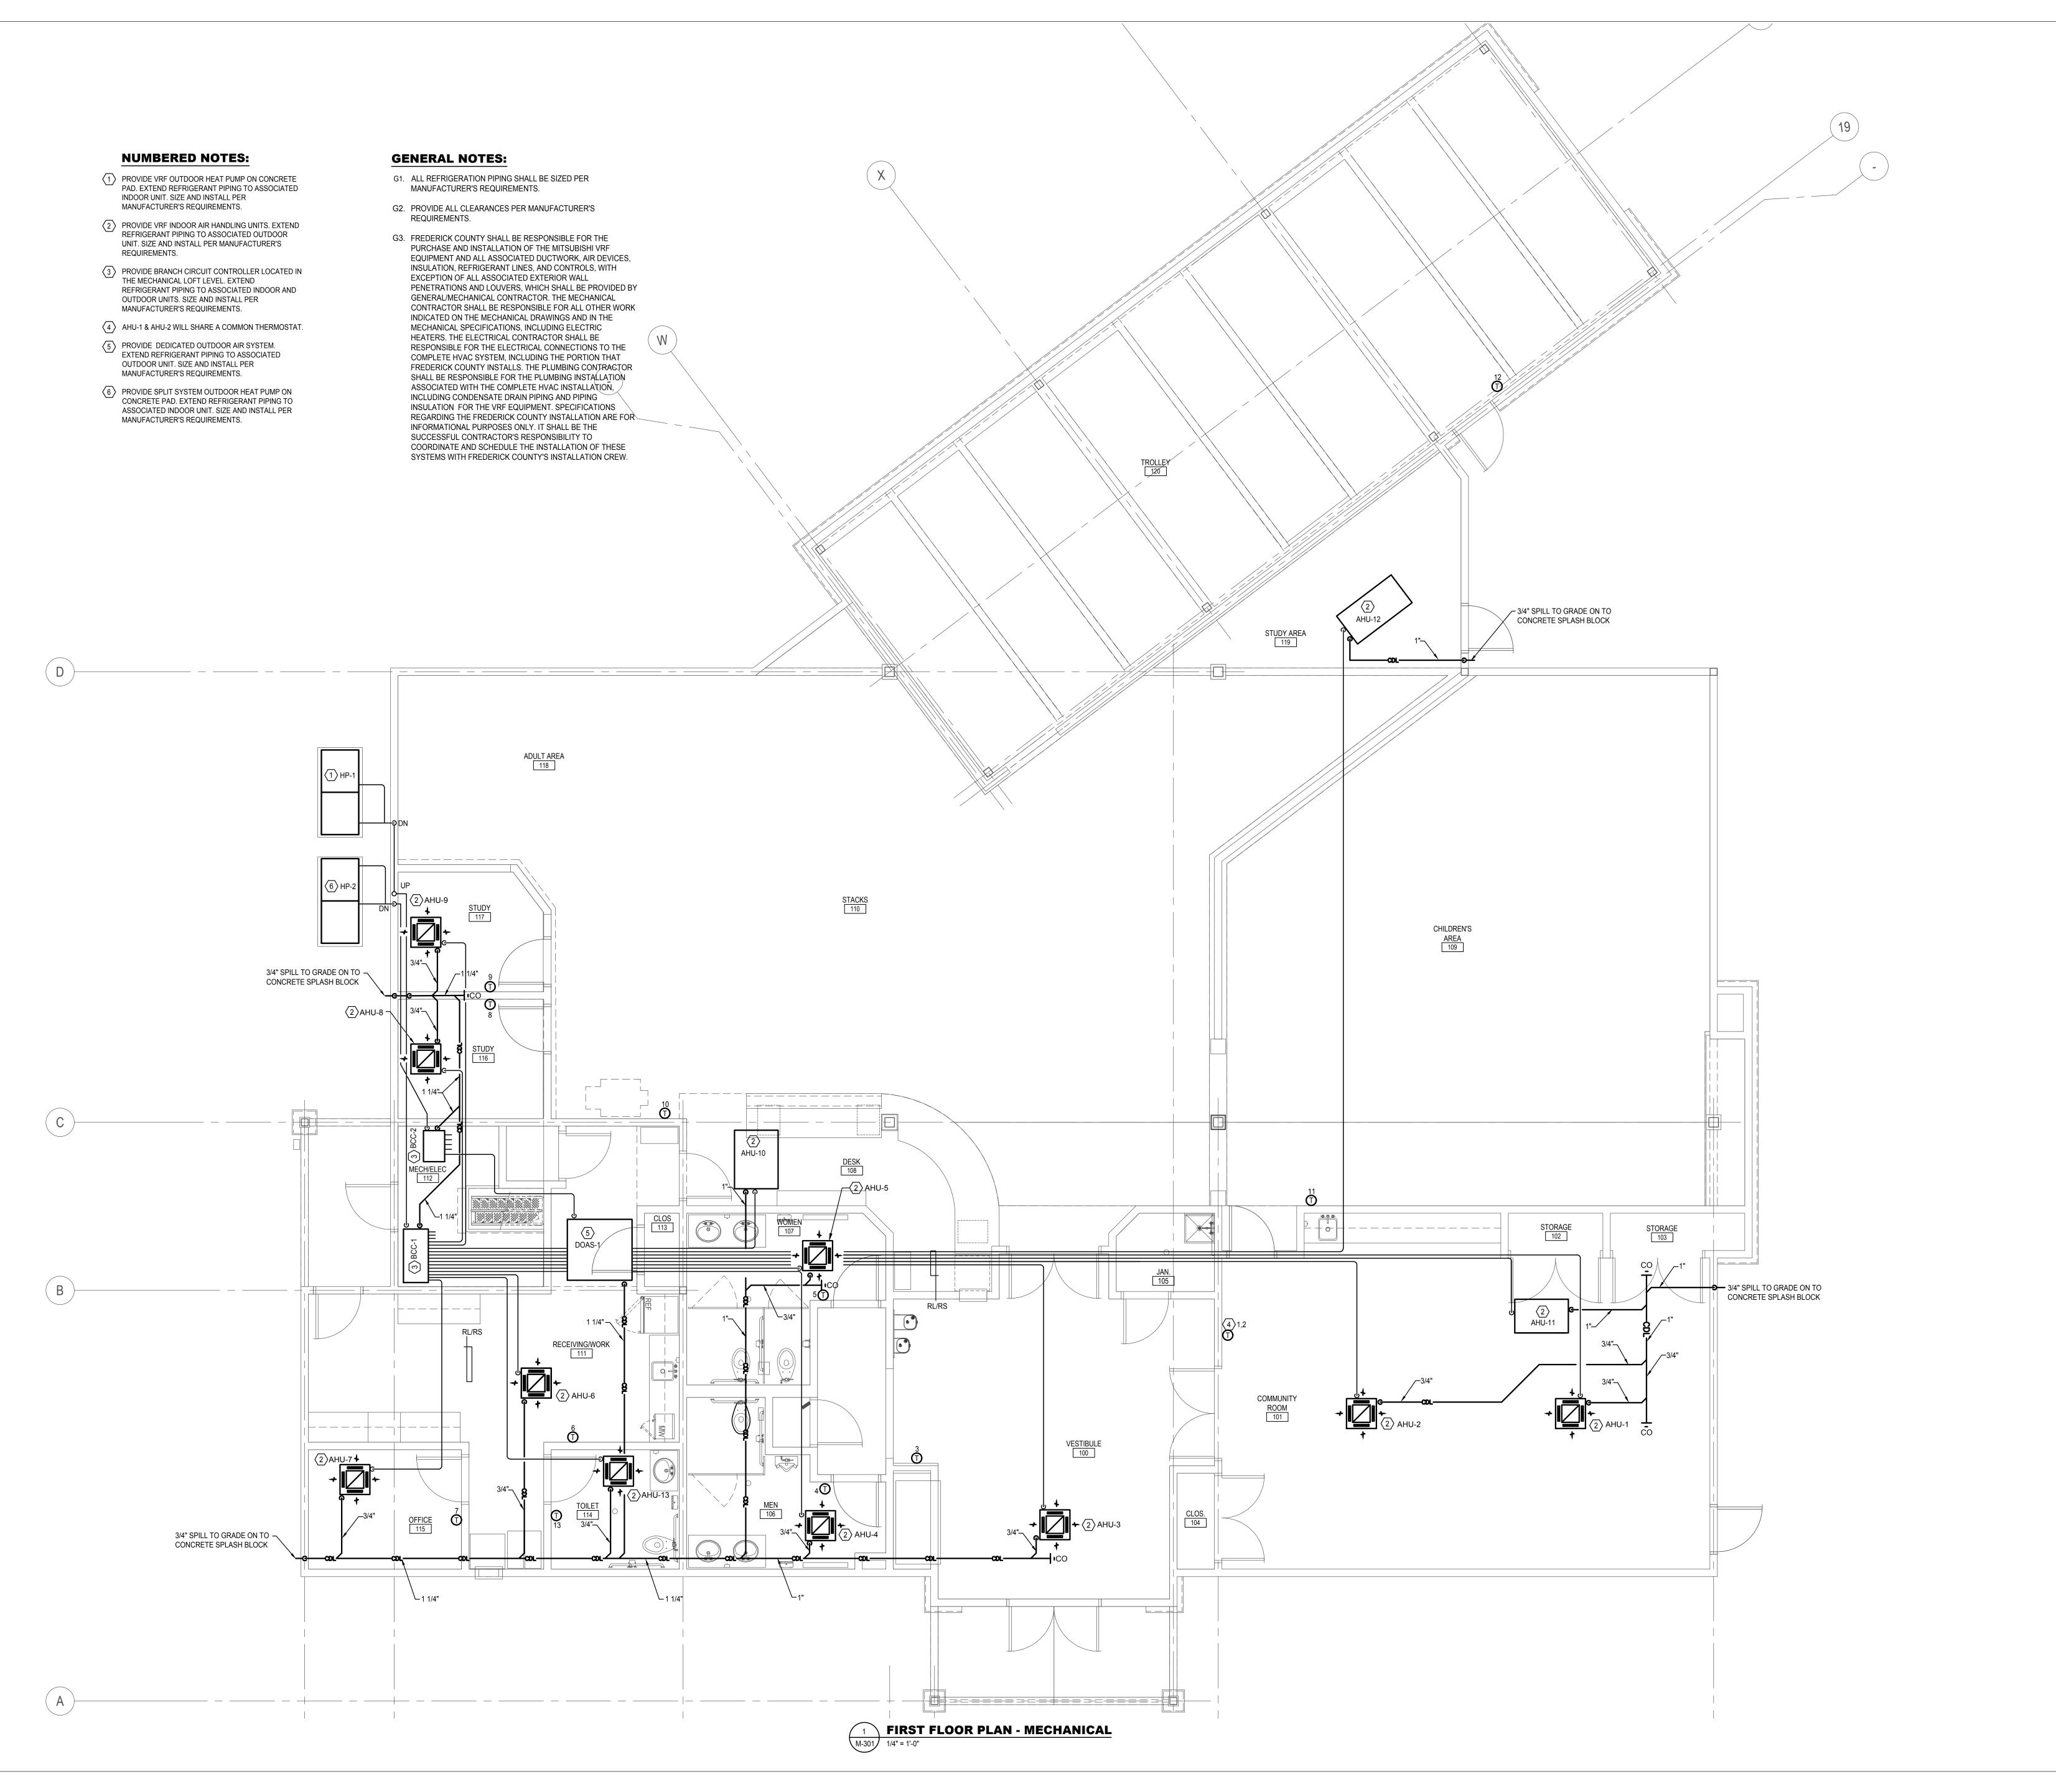

PROJECT TITLE

MYERSVILLE COMMUNITY LIBRARY

PROJECT ADDRESS

8 HARP PLACE
MYERSVILLE, MD 21773

PROJECT OWNER

FREDERICK COUNTY,
MARYLAND
DEPARTMENT OF PUBLIC
WORKS

PROJECT TEAM



NOELKER AND HULL ASSOCIATES, INC.

ASSOCIATES, INC.

6 NORTH EAST STREET, SUITE 300 FREDERICK, MD | 21701-5680 P: 301.662.8611 | F: 301.662.8632 NOELKERHULL.COM PA | MD | VA

STRUCTURAL ENGINEER

ABEL CONSULTING ENGINEERS

9055 COMPRINT COURT, SUITE 370 | GAITHERSBURG, MD | 20878 P: 301.258.8884 | F: 301.258.9457

CJL ENGINEERING

3 WEST SECOND STREET | FREDERICK, MD | 21701 P: 301.695.9424 | F: 301.293.6338

CIVIL ENGINEER

HARRIS, SMARIGA & ASSOCIATES, INC.

125 SOUTH CARROLL STREET | FREDERICK, MD | 21701
P: 301.662.4488 | F: 301.662.4906

Professional Certification. I hereby certify that these documents were prepared or approved by me, and that I am a duly licensed professional engineer under the laws of the State of Maryland. License No:45511, Expiration Date: 06/03/2020

SHEET INFORMATION

KEY PLA

	<u>revisions</u>					
EV. #:	DESCRIPTION:	DATE:				
	-	-				


PROJECT STATUS

JOB NUMBER:	16-1043
ISSUE DATE:	10 APRIL 2018
SCALE:	AS INDICATED
SHEET TITLE:	

FIRST FLOOR PLAN-MECHANICAL PIPING

SHEET NUMBER:

M301

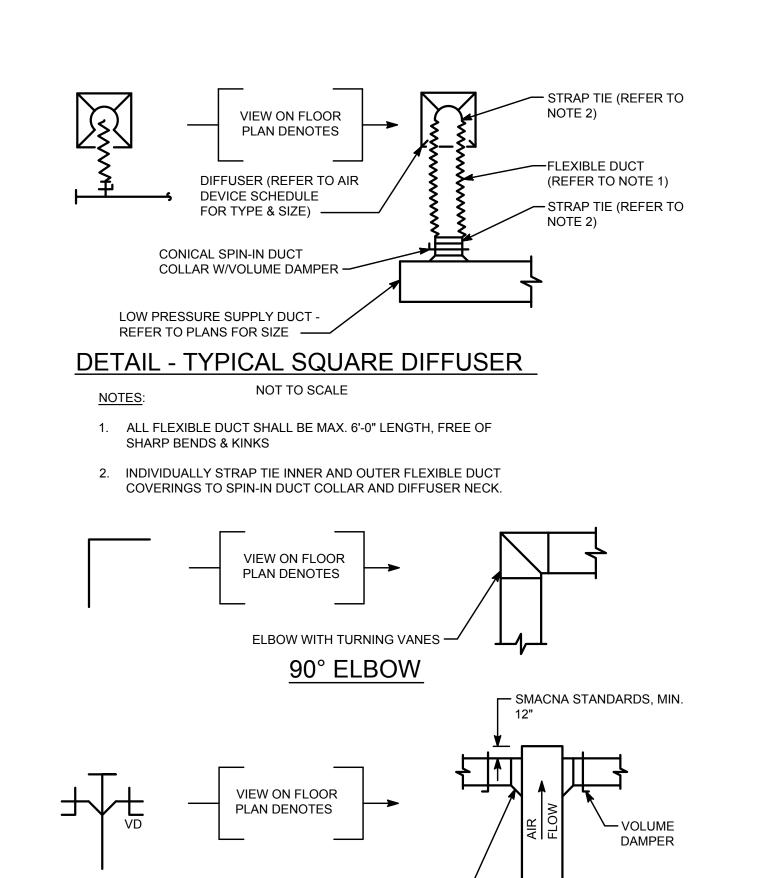


BRANCH CONNECTION

45° ENTRY TAP LENGTH -

0.25 DUCT WIDTH, (MIN. 4") 🔟


DETAIL - DUCT CONNECTIONS


NOT TO SCALE

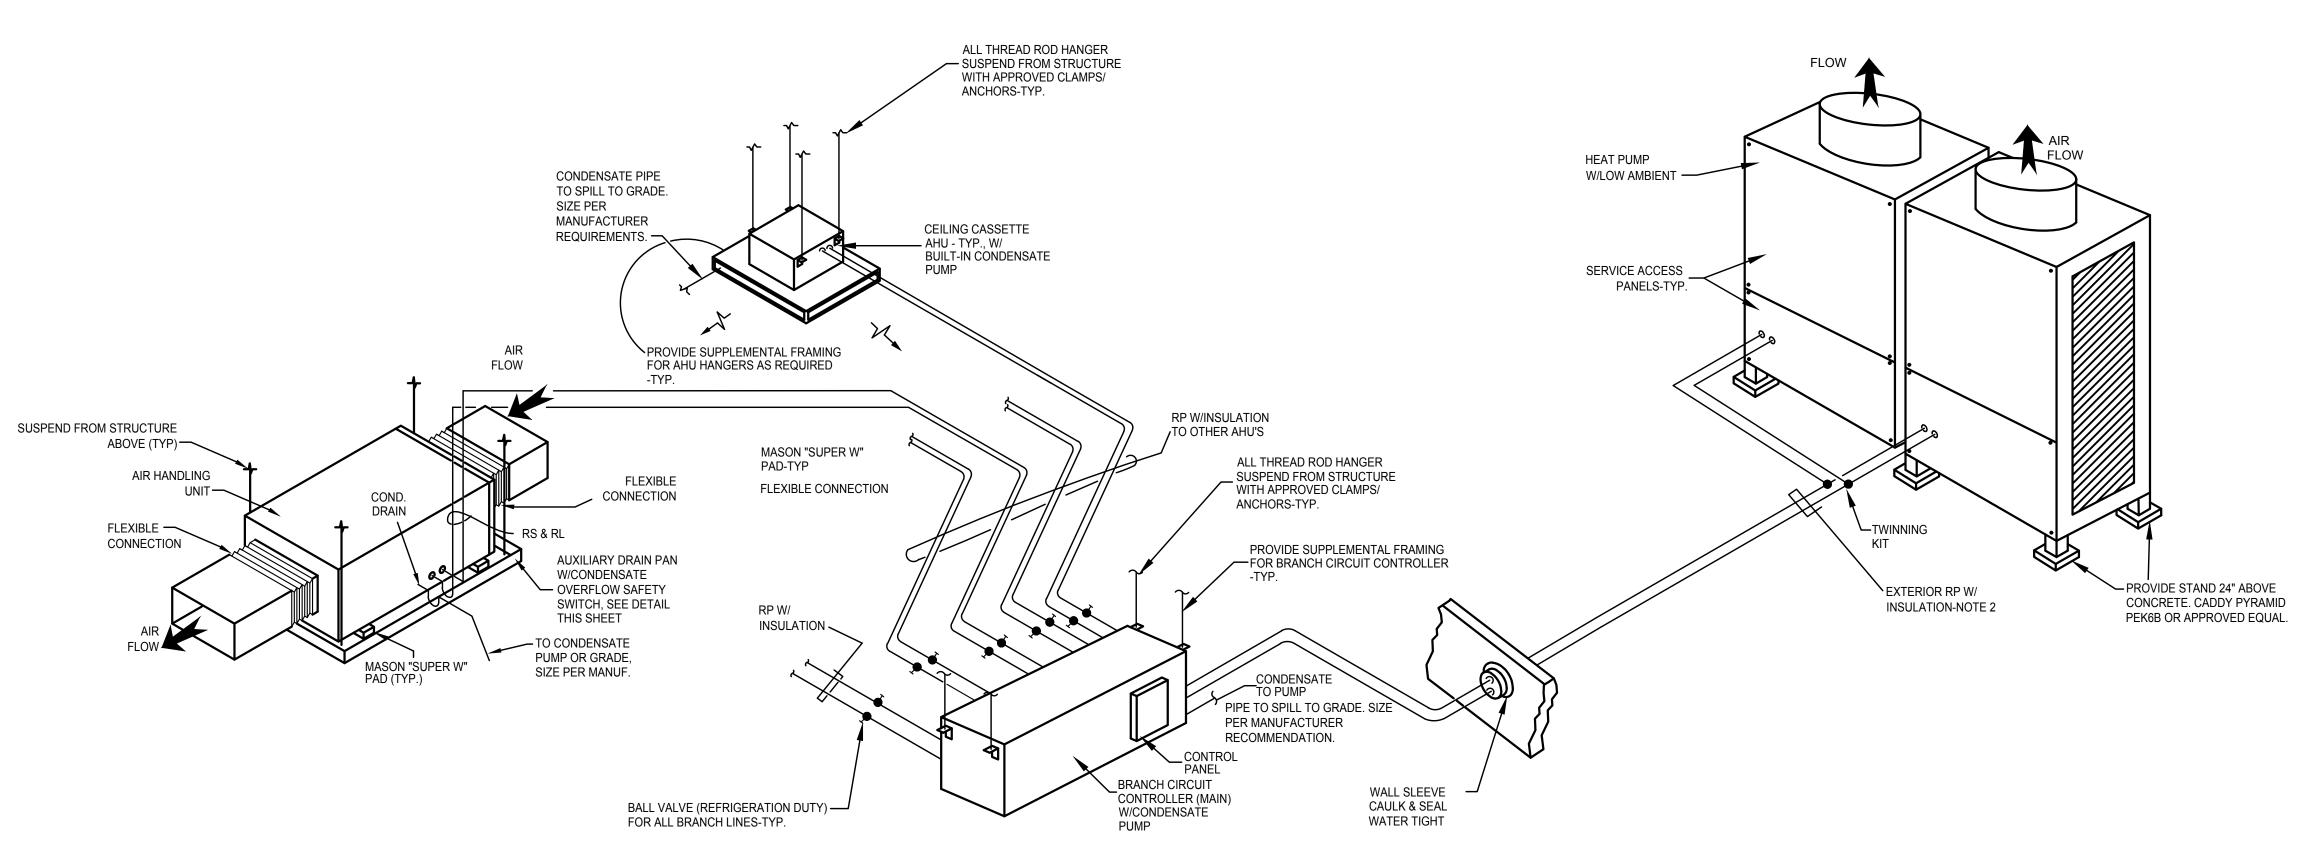


VARIABLE REFRIGERANT FLOW SIMULTANEOUS HEAT PUMP SYSTEM SCHEMATIC

NOTE 1. ALL EXTERIOR RP SHALL BE COVERED WITH VENTURE CLAD 1577CW JACKETING SYSTEM BY VENTURE TAPE OR APPROVED EQUAL.

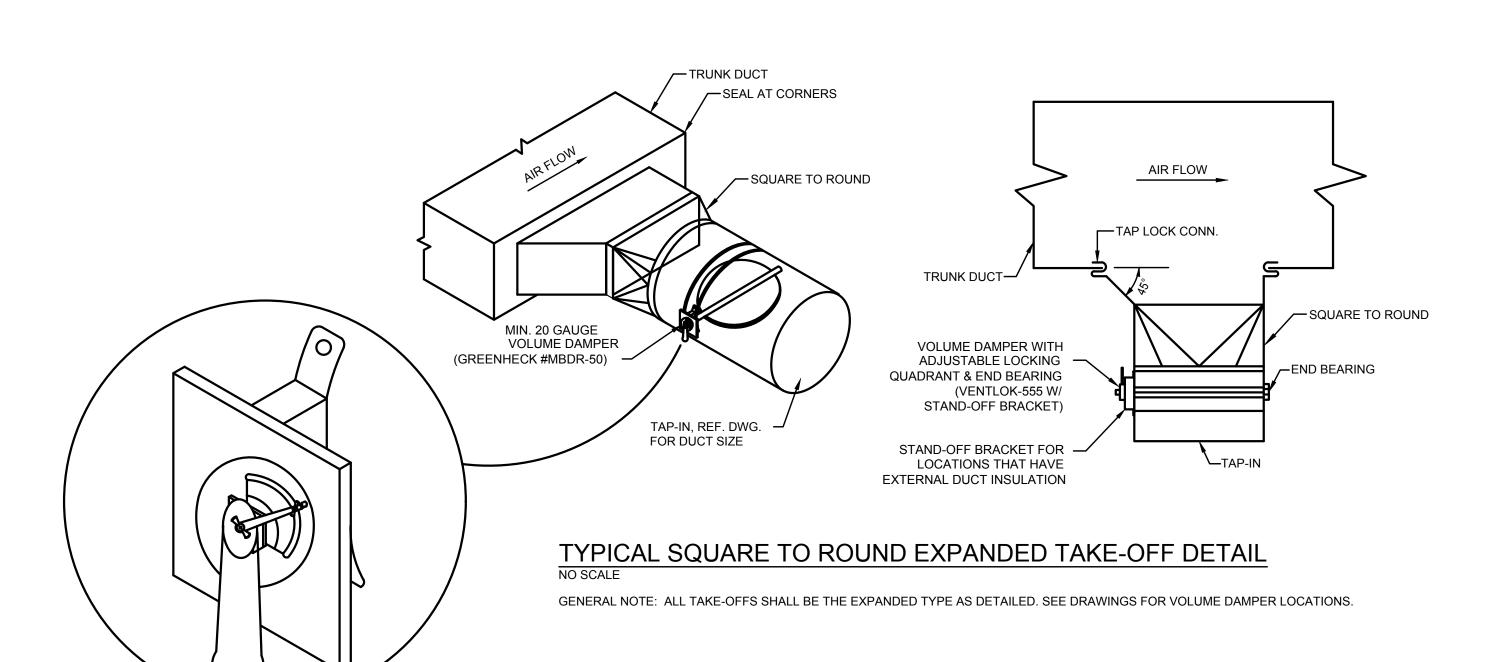


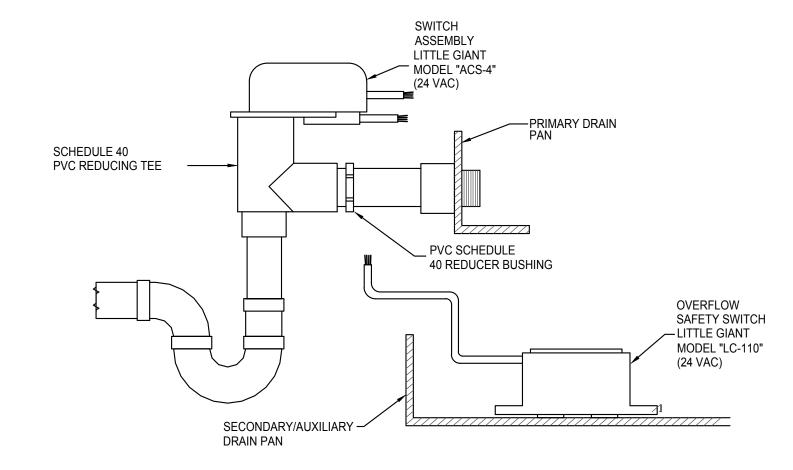

CONDENSATE OVERFLOW DETECTION SCHEMATIC NO SCALE

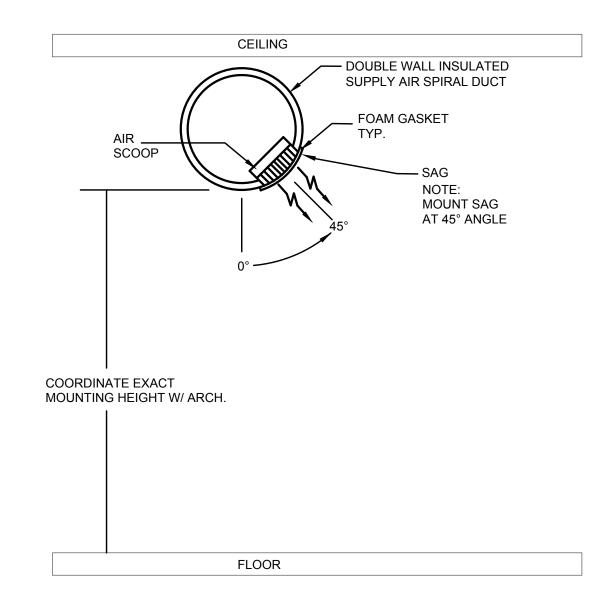

SPIRAL DUCT SUPPLY AIR GRILLE DETAIL
NO SCALE

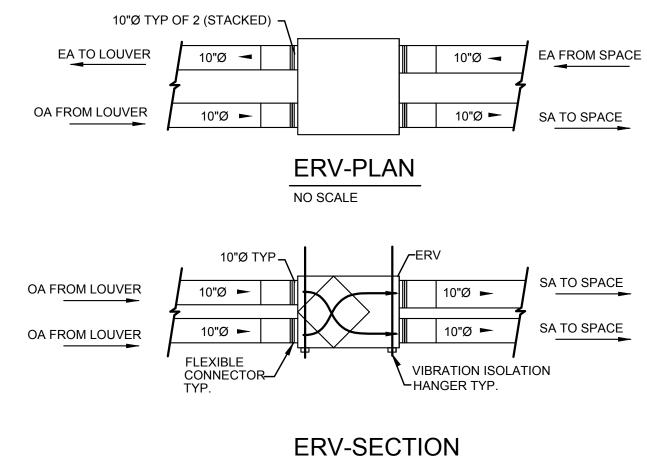

GENERAL NOTES:

G1. FREDERICK COUNTY SHALL BE RESPONSIBLE FOR THE PURCHASE AND INSTALLATION OF THE MITSUBISHI VRF EQUIPMENT AND ALL ASSOCIATED DUCTWORK, AIR DEVICES, INSULATION, REFRIGERANT LINES, AND CONTROLS, WITH EXCEPTION OF ALL ASSOCIATED EXTERIOR WALL PENETRATIONS AND LOUVERS, WHICH SHALL BE PROVIDED BY GENERAL/MECHANICAL CONTRACTOR. THE MECHANICAL CONTRACTOR SHALL BE RESPONSIBLE FOR ALL OTHER WORK INDICATED ON THE MECHANICAL DRAWINGS AND IN THE MECHANICAL SPECIFICATIONS, INCLUDING ELECTRIC HEATERS. THE ELECTRICAL CONTRACTOR SHALL BE RESPONSIBLE FOR THE ELECTRICAL CONNECTIONS TO THE COMPLETE HVAC SYSTEM, INCLUDING THE PORTION THAT FREDERICK COUNTY INSTALLS. THE PLUMBING CONTRACTOR SHALL BE RESPONSIBLE FOR THE PLUMBING INSTALLATION ASSOCIATED WITH THE COMPLETE HVAC INSTALLATION, INCLUDING CONDENSATE DRAIN PIPING AND PIPING INSULATION FOR THE VRF EQUIPMENT. SPECIFICATIONS REGARDING THE FREDERICK COUNTY INSTALLATION ARE FOR INFORMATIONAL PURPOSES ONLY. IT SHALL BE THE SUCCESSFUL CONTRACTOR'S RESPONSIBILITY TO COORDINATE AND SCHEDULE THE INSTALLATION OF THESE SYSTEMS WITH FREDERICK COUNTY'S INSTALLATION CREW.

PROJECT INFORMATION

PROJECT TITLE

MYERSVILLE COMMUNITY **LIBRARY**

PROJECT ADDRESS 8 HARP PLACE MYERSVILLE, MD 21773

PROJECT OWNER FREDERICK COUNTY, **MARYLAND** DEPARTMENT OF PUBLIC **WORKS**

PROJECT TEAM



AND HULL

ASSOCIATES, INC. ARCHITECTS

6 NORTH EAST STREET, SUITE 300 FREDERICK, MD | 21701-5680 P: 301.662.8611 | F: 301.662.8632 NOELKERHULL.COM PA | MD | VA

STRUCTURAL ENGINEER ABEL CONSULTING ENGINEERS

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Professional Certification. I hereby certify that these documents were prepared or approved by me, and that I am a duly licensed professional engineer under the laws of the State of Maryland. License No:45511, Expiration Date: <u>06/03/2020</u>

SHEET INFORMATION

	<u>revisions</u>			
REV.#:	DESCRIPTION:	DATE:		
-	-	-		

PROJECT STATUS

ISSUE DATE: SCALE:	16- 10 APRIL AS INDICA
	ASINDICA
SHEET TITLE:	
	ICAL - DETAILS

ELECTRIC UNIT HEATER SCHEDULE							
DESIG.	SERVICE	KW	VOLTAGE	NOTES	MANUF	MODEL	
EUH-1	112 MECH/ ELEC	3	240/1/60	1,2	Q MARK	MUH03-21	

1. U.L LISTED 2. SIDE MNT. T'STAT

	ELECTRIC BASE BOARD SCHEDULE								
DESIG.	SERVICE	KW	VOLTAGE	NOTES	MANUF	MODEL			
EBB-1	120 TROLLEY	2	240/1/60	1,2,3	Q MARK	CBD2004			
EBB-2	120 TROLLEY	1	240/1/60	1,2,3	Q MARK	CBD1004			

NOTES:

UL LISTED
 BUILTIN THERMOSTAT

FREDERICK COUNTY'S INSTALLATION CREW.

2. BUILTIN THERMOSTAT3. RECESSED MOUNT FRAME

	VADIADI	E DEEDI	CEDANT		ПЕ	ΛТ Г	LIMP OIL	TDOOD	LINIT COUEDINE /	NOTE 4)
	VARIAD	LE KEFKI	GERANI	FLOW	ПЕ	AIF	UNIP UU	IDOOK	<u>UNIT SCHEDULE (</u>	NOTE 4)
	COOLING TC	HEATING TC	HEATING TC	ELE	CTRICA	٩L	APRROX. UNIT			
DESIG.	MBH @ 95°F	MBH @ 47°F	MBH @ 5°F	V/PH/HZ	MCA	MOCP	WEIGHT (lbs)	REMARKS	MANUFACTURER	MODEL
HP-1	168	188	112.8	240/3/60	63	100	700	1,2,3	MITSUBISHI	PURY-P168TLMU-A
HP-2	120	135	135	240/3/60	39	60	695	1,2,3	MITSUBISHI	PURY-P120TLMU-A
NOTES:										
1.	U.L LISTED									
2.	PROVIDE SNOW	SENSOR								
3.	LOW AMBIENT CO	ONTROL TO 0°F								
4.	FREDERICK COU	NTY SHALL BE RE	SPONSIBLE FOR	THE PURC	HASE	AND INS	STALLATION OF T	THE MITSUBISH	HIVRF EQUIPMENT AND ALL ASSO	DCIATED DUCTWORK, AIR
	DEVICES, INSULA	TION, REFRIGER	ANT LINES, AND C	CONTROLS,	WITH	EXCEPT	ION OF ALL ASS	OCIATED EXTE	RIOR WALL PENETRATIONS AND	LOUVERS, WHICH SHALL
									RESPONISBLE FOR ALL OTHER W	
	MECHANICAL DR	AWINGS AND IN T	HE MECHANICAL	SPECIFICA	TIONS	, INCLUE	DING ELECTRIC H	EATERS. THE	ELECTRICAL CONTRACTOR SHAL	L BE RESPONSIBLE FOR
	THE ELECTRICAL	CONNECTIONS T	O THE COMPLETE	HVAC SY	STEM,	INCLUD	ING THE PORTIO	N THAT FREDE	RICK COUNTY INSTALLS. THE PLU	JMBING CONTRACTOR
	SHALL BE RESPO	ONSIBLE FOR THE	PLUMBING INSTA	ALLATION A	SSOC	IATED W	VITH THE COMPL	ETE HVAC INS	TALLATION, INCLUDING CONDENS	STAE DRAIN PIPING AND
	PIPING INSULATION	ON FOR THE VRF	EQUIPMENT. SPE	CIFICATION	NS REC	SARDING	THE FREDERIC	K COUNTY INS	STALLATION ARE FOR INFORMATION	NAL PURPOSES
	ONLY. IT SHALL E	BE THE SUCCESF	UL CONTRACTOR'	S RESPON	SIBILIT	Y TO CO	ORDINATE AND	SCHEDULE TH	IE INSTALLATION OF THESE SYST	EMS WITH

					IMC Ver	ntilation T	able					
System	ERV-1 (Single Zone System)											
Room	Description	Area Ft2 AZ	Area Outdoor Air Rate Per IMC Table 403.3 RA	Area Outdoor RaAz	Occupant Load Rate Per IMC Table 403.3 (People/ 1000 ft2)	Occupancy C * F/1000 PZ	Occupant Outdoor Air Rate Per Table 403.3 Rp	Occupant Outdoor Air RpPz	Breathing Zone Outdoor Air Vbz= RpPz + RaAz	Zone Air Distribution Effectiveness Ez	Zone Outdoor Air Voz= Vbz/ Ez	Supply Air Design Vpz
100 Vestibule	Main Entry	400		The second second	10							
101 Community Room		800		48	50				248			310
105 JC	Janitors Closet	35			C					0.8		1
106 Mens	Restroom	130			C					8.0		
107 Womens	Restroom	125		U	C		_	100		0.8		'
108 Desk	Office	145			5							
109 Childrens Area	Libraries	1050		0.000	10	10 (315)						
110 Stacks	Libraries	1050			10	The Control of the Co						
111 Receiving Work	Office	375		22.5	5	1.875	5	9.375	31.875			40
112 Mechanical	Mechanical	130		_	0	_				0.8		(
115 Office	Office	95	0.06	5.7	5	0.475	5	2.375	8.075	0.8	10.09375	10
116 Study	Office	100			5	0.5						
117 Study	Office	95	0.06		5	0.475	5	2.375	8.075	0.8	10.09375	
118 Adult Area	Libraries	140	0.12	16.8	10	1.4	5	5 7	23.8	0.8	29.75	
119 Study Area	Libraries	250	0.12	30	10	2.5	5	12.5	42.5	0.8	53.125	
120 Trolley	Libraries	1000	0.12	120	10	10	5	5 50	170	0.8	212.5	215
Totals		5920		539.4		82.95		414.75	954.15		1192.6875	1200
								Total Required	d Outdoor Air (Vot)		Total Outdoo	r Air Provided
									1,192.69			1,200.00
								Percentage of	f outdoor Air		Percentage (of outdoor Air
									99.4%			100.0%

DESIGN CONDITIONS SUMMER 1200																					
CFM ESP HP EAT °F DB EAT °F DB LAT °F DB LAT °F WB LAT °F B LAT °F WB LAT °F WB CFM ESP HP EAT °F RH % V/PH/HZ WEIGHT (LBS) REMARKS MANUFACTURER MODEL SUMMER 1200 0.60 0.5 0.5 0.5 0.5 0.60 0.5 0.5 0.5 0.60 0.60							E	NERG	Y REC	OVER	Y VE	NTILA	ATOR	SCH	EDULE (NOTE	2)				
CFM ESP HP EAT °F DB EAT °F WB LAT °F WB LAT °F WB CFM ESP HP EAT °F RH % V/PH/HZ WEIGHT (LBS) ERV-1 SUMMER WINTER 1200 0.60 0.5 0.5 0 0.5 0.5 0 0.5 0.5 0 0.5 0.5	DESIG.	DESIGN CONDITIONS		SUPPLY							EXHAUST ELECTRICAL			MCA	MOCP	MAX UNIT	DEMADKS	MANUEACTURED	MODEL		
ERV-1 WINTER 1200 0.60 0.5 0 -1 53.3 46.1 1200 0.60 0.5 70 35 240/1/60 7.1 15 265 1,2 MITSUBISHI LGH-F1200RX5-E			CFM	ESP	HP	EAT °F DB	EAT °F WB	LAT °F DB	LAT °F WB	CFM	ESP	HP	EAT °F	RH %	V/PH/HZ			WEIGHT (LBS)	REWARKS	MANUFACTURER	WODEL
WINTER 0 -1 53.3 46.1 70 35	EDV 4	SUMMER	1000	0.00	0.5	95	78	79.8	69.4	1000	0.00	0.5	75	50	240/4/60	7.4	4.5	205	4.0	MITOLIDIOLII	LOU E4000DVE E
NOTES:	ERV-I	WINTER	1200	0.60	0.5	0	-1	53.3	46.1	1200	0.60	0.5	70	35	240/1/60	7.1	15	200	1,2	MITSORISHI	LGH-F 1200RX5-E
NOTES:																					
	NOTES:																				

1. U.L LISTED

2. FREDERICK COUNTY SHALL BE RESPONSIBLE FOR THE PURCHASE AND INSTALLATION OF THE MITSUBISHI VRF EQUIPMENT AND ALL ASSOCIATED DUCTWORK, AIR DEVICES, INSULATION, REFRIGERANT LINES, AND CONTROLS, WITH EXCEPTION OF ALL ASSOCIATED EXTERIOR WALL PENETRATIONS AND LOUVERS, WHICH SHALL BE PROVIDED BY THE GENERAL/MECHANICAL CONTRACTOR. THE MECHANICAL CONTRACTOR SHALL BE RESPONSIBLE FOR ALL OTHER WORK INDICATED ON THE MECHANICAL DRAWINGS AND IN THE MECHANICAL SPECIFICATIONS, INCLUDING ELECTRIC HEATERS. THE ELECTRICAL CONTRACTOR SHALL BE RESPONSIBLE FOR THE ELECTRICAL CONNECTIONS TO THE COMPLETE HVAC SYSTEM, INCLUDING THE PORTION THAT FREDERICK COUNTY INSTALLS. THE PLUMBING CONTRACTOR SHALL BE RESPONSIBLE FOR THE PLUMBING INSTALLATION ASSOCIATED WITH THE COMPLETE HVAC INSTALLATION, INCLUDING CONDENSTAE DRAIN PIPING AND PIPING INSULATION FOR THE VRF EQUIPMENT. SPECIFICATIONS REGARDING THE FREDERICK COUNTY INSTALLATION ARE FOR INFORMATIONAL PURPOSES ONLY. IT SHALL BE THE SUCCESFUL CONTRACTOR'S RESPONSIBILITY TO COORDINATE AND SCHEDULE THE INSTALLATION OF THESE SYSTEMS WITH FREDERICK COUNTY'S INSTALLATION CREW.

				DEDIC	ATED	OUTSIE	DE AIR	SYSTE	M SCI	HEDU	LE (NOTE	1)		
DESIG.	DESIGN CONDITIONS			SI	JPPLY			ELECTRICAL	MCA	MOCP	MAX UNIT	REMARKS	MANUFACTURER	MODEL
		CFM	ESP	EAT °F DB	EAT °F WB	LAT °F DB	RH %	V/PH/HZ			WEIGHT (LBS)	KEWAKKS	WANDFACTURER	WODEL
DOAS-1	SUMMER	1200	0.8	81.4	70.6	75	50	240/1/60	4.31	15	310	1	MITSUBISHI	PEFY-AF1200CFMR
DOAS-1	WINTER	1200	0.0	52.1	41.5	70	30	240/1/00	4.31	13	310		MITOUDISHI	PEFT-AFTZ00CFWIK
NOTES:														

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	NOMINAL	COOLI	NG MBH	HEATING		ELECT	RICAL		CONNE	ECTED TO			
DESIG.	AIRFLOW	TC	SC	MBH @ 0°F	STYLE	V/PH/HZ	MCA	MOCP	HP	BCC	REMARKS	MANUFACTURER	MODEL
AHU-1	390	15	11.25	17	CEILING CASSETTE	240/1/60	0.35	15	1	1	1,2,3,5	MITSUBISHI	PLFY-P15NCMU
AHU-2	390	15	11.25	17	CEILING CASSETTE	240/1/60	0.35	15	1	1	1,2,3,5	MITSUBISHI	PLFY-P15NCMU
AHU-3	390	12	9	13.5	CEILING CASSETTE	240/1/60	0.35	15	1	1	1,2,3,5	MITSUBISHI	PLFY-P12NCMU
AHU-4	390	8	6	9	CEILING CASSETTE	240/1/60	0.29	15	1	1	1,2,3,5	MITSUBISHI	PLFY-P08NCM
AHU-5	350	8	6	9	CEILING CASSETTE	240/1/60	0.29	15	1	1	1,2,3,5	MITSUBISHI	PLFY-P08NCMU
AHU-6	350	12	9	13.5	CEILING CASSETTE	240/1/60	0.35	15	1	1	1,2,3,5	MITSUBISHI	PLFY-P08NCMU
AHU-7	350	8	6	9	CEILING CASSETTE	240/1/60	0.29	15	1	1	1,2,3,5	MITSUBISHI	PLFY-P12NCMU
AHU-8	350	8	6	9	CEILING CASSETTE	240/1/60	0.29	15	1	1	1,2,3,5	MITSUBISHI	PLFY-P08NCM
AHU-9	350	8	6	9	CEILING CASSETTE	240/1/60	0.29	15	1	1	1,2,3,5	MITSUBISHI	PLFY-P08NCM
AHU-10	1,410	54	40.5	60	CEILING CONCEALED	240/1/60	4.73	15	1	1	1,2,3,4	MITSUBISHI	PEFY-P54NMA
AHU-11	740	27	20.25	30	CEILING CONCEALED	240/1/60	2.49	15	1	1	1,2,3,4	MITSUBISHI	PEFY-P27NMA
AHU-12	1,165	36	27	40	CEILING CONCEALED	240/1/60	3.33	15	1	1	1,2,3,4	MITSUBISHI	PEFY-P36NMA
AHU-13 350 8 6 9 CEILING CASSETTE 240/1/60 0.29 15 1 1 1,2,3,4 MITSUBISHI PLFY-P08NCMU-E													
NOTES:													
1. U.L. LISTED													
2. WALL MNT. T'STAT													
	WASHABLE F												
	PROVIDE SAU			ENSATE PUM	0								
	B.I. CONDENS												
6.					BLE FOR THE PURCHASE								
			•		S, AND CONTROLS, WITH								
	BE PROVIDED	BY THE	GENER	AL/MECHANIC	CAL CONTRACTOR. THE M	MECHANICAL	CONTRAC	CTOR SHALL	BE RES	SPONISBLE	FOR ALL OTHE	R WORK INDICATED	ON THE

SHALL BE RESPONSIBLE FOR THE PLUMBING INSTALLATION ASSOCIATED WITH THE COMPLETE HVAC INSTALLATION, INCLUDING CONDENSTAE DRAIN PIPING AND

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	BRANCH CIRCUIT CONTROLLER SCHEDULE (NOTE 2)										
DESIG.	BRANCH	VOLTAGE	MCA	MOCP	APPROX. UNIT	REMARKS	DETAILS	MANUFACTURER	MODEL		
	NUMBERS				WEIGHT (LBS)						
BCC-1	16	240V/1Ø/60HZ	1.93	15	172	U.L., MAIN	1,2	MITSUBISHI	CMB-P1016NU-HA		
BCC-2	5	240V/1Ø/60HZ	0.4	15	72	U.L., MAIN	1,2	MITSUBISHI	CMB-P105NU-G		
NOTES:											

PROVIDE SAUERMANN CONDENSATE PUMP

FREDERICK COUNTY'S INSTALLATION CREW.

FREDERICK COUNTY'S INSTALLATION CREW.

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			AIR DEV	ICE SCH	EDULE (NOTE 2)		
				# OF	INLET/NECK	MAX		
DESIG.	SERVICE	DESCRIPTION	NOMINAL SIZE	SLOTS/	SIZE	N.C.	FINISH	REMARKS
			(INCHES)	SLOT WIDTH	(INCHES)	LEVEL		
				(INCHES)				
S1	SUPPLY	LOUVERED CEILING DIFFUSER	18x 18	-	4"ø	24	#26 FINISH	TITUS TDC, TYPE 3, 24"x24" MODULE (NOTE 1)
S2	SUPPLY	LOUVERED CEILING DIFFUSER	18x 18	-	6"ø	24	#26 FINISH	TITUS TDC, TYPE 3, 24"x24" MODULE (NOTE 1)
S3	SUPPLY	LOUVERED CEILING DIFFUSER	18x 18	-	10"ø	24	#26 FINISH	TITUS TDC, TYPE 3, 24"x24" MODULE (NOTE 1)
S4	SUPPLY	LINEAR SLOT DIFFUSER	48x6	4	6"ø	24	#26 FINISH	TITUS ML-38, TYPE 3, 48"x6" MODULE (NOTE 1)
S5	SUPPLY	SUPPLY AIR REGISTER	10x6	-	-	24	#26 FINISH	TITUS S301FL AIR SCOOP
R1	RETURN	RETURN AIR GRILLE	22x22	-	-	24	#26 FINISH	TITUS 350RL, 24"x24" MODULE (NOTE 1)
R2	RETURN	LINEAR SLOT DIFFUSER	48X6	4	6"ø	24	#26 FINISH	TITUS MLR-38, TYPE 3, 48"x6" MODULE (NOTE 1)
E1	EXHAUST	EXHAUST AIR GRILLE	22x22	1=.	6"ø	24	#26 FINISH	TITUS 350RL, TYPE 3, 24"x24" MODULE (NOTE 1)
E2	EXHAUST	EXHAUST AIR GRILLE	22x22	-	8"ø	24	#26 FINISH	TITUS 350RL, TYPE 3, 24"x24" MODULE (NOTE 1)
E3	EXHAUST	EXHAUST AIR GRILLE	22x22	=.	10"ø	24	#26 FINISH	TITUS 350RL, TYPE 3, 24"x24" MODULE (NOTE 1)
E4	EXHAUST	EXHAUST AIR GRILLE	22x22	-	-	24	#26 FINISH	TITUS 350RL, TYPE 1, 24"x24" MODULE (NOTE 1)
E5	EXHAUST	LINEAR SLOT DIFFUSER	48x6	4	6"ø	24	#26 FINISH	TITUS MLR-38, TYPE 3, 48"x6" MODULE (NOTE 1)

NOTES:

1. PROVIDE A SQUARE TO ROUND ADAPTOR

2. FREDERICK COUNTY SHALL BE RESPONSIBLE FOR THE PURCHASE AND INSTALLATION OF THE MITSUBISHI VRF EQUIPMENT AND ALL ASSOCIATED DUCTWORK, AIR DEVICES, INSULATION, REFRIGERANT LINES, AND CONTROLS, WITH EXCEPTION OF ALL ASSOCIATED EXTERIOR WALL PENETRATIONS AND LOUVERS, WHICH SHALL BE PROVIDED BY THE GENERAL/MECHANICAL CONTRACTOR. THE MECHANICAL CONTRACTOR SHALL BE RESPONSIBLE FOR ALL OTHER WORK INDICATED ON THE MECHANICAL DRAWINGS AND IN THE MECHANICAL SPECIFICATIONS, INCLUDING ELECTRIC HEATERS. THE ELECTRICAL CONTRACTOR SHALL BE RESPONSIBLE FOR THE ELECTRICAL CONNECTIONS TO THE COMPLETE HVAC SYSTEM, INCLUDING THE PORTION THAT FREDERICK COUNTY INSTALLS. THE PLUMBING CONTRACTOR SHALL BE RESPONSIBLE FOR THE PLUMBING INSTALLATION ASSOCIATED WITH THE COMPLETE HVAC INSTALLATION, INCLUDING CONDENSTAE DRAIN PIPING AND PIPING INSULATION FOR THE VRF EQUIPMENT. SPECIFICATIONS REGARDING THE FREDERICK COUNTY INSTALLATION ARE FOR INFORMATIONAL PURPOSES ONLY. IT SHALL BE THE SUCCESFUL CONTRACTOR'S RESPONSIBILITY TO COORDINATE AND SCHEDULE THE INSTALLATION OF THESE SYSTEMS WITH

PROJECT INFORMATION

PROJECT TITLE

MYERSVILLE COMMUNITY LIBRARY

PROJECT ADDRESS

8 HARP PLACE
MYERSVILLE, MD 21773

FREDERICK COUNTY,
MARYLAND
DEPARTMENT OF PUBLIC
WORKS

PROJECT TEAM



AND HULL ASSOCIATES, INC.

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Professional Certification. I hereby certify that these documents were prepared or approved by me, and that I am a duly licensed professional engineer under the laws of the State of Maryland.

License No: 45511,
Expiration Date: 06/03/2020

SHEET INFORMATION

	REVISIONS	
REV. #:	DESCRIPTION:	DATE:
-	-	-

PROJECT STATUS

	SCHEDULES	
SHEET TITLE:		
SCALE:		AS INDICATED
ISSUE DATE:		10 APRIL 2018
JOB NUMBER:		16-1043

SHEET NUMBER:

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MATERIAL PROPERTY MATE	PLUM	BING ABBREVIATIONS	PLUM	IBING ABBREVIATIONS (CONT.)	PLUMBING PIPIN	G ABBREVIATIONS
March Marc			JT	JOINT	AV	ACID VENT PIPING (AV)
19	ABV	ABOVE				
Michael Control Ander Control 19	AFF	ABOVE FINISHED FLOOR			———AW———	ACID WASTE PIPING (AW)
March	AHAP	AS HIGH AS POSSIBLE			————A———	COMPRESSED AIR PIPING (A)
Commonwealth Comm	AMP	AMPERE	LH	LATENT HEAT		()
## ## ## ## ## ## ## ## ## ## ## ## ##	ATC	AUTOMATIC TEMPERATURE CONTROL	LTG	LIGHTING	——————————————————————————————————————	CONDENSATE DRAIN PIPING (CDL)
ASSECTION SCRIPTON PLANESSESSION AND ADMINISTRATION		AMERICAN SOCIETY OF HEATING, REFRIGERATION AND				CADRON DIOVIDE DIDING (CO2)
A		AMERICAN SOCIETY OF MECHANICAL ENGINEERS	MAX	MAXIMUM		CARBON DIOXIDE FIFING (CO2)
March Marc	ATM	ATMOSPHERE	MC	MECHANICAL CONTRACTOR		COLD WATER PIPING (CW)
Maintage	AV	ACID VENT	MFGR	MANUFACTURER		
BLEAN MEDIUM MIT MODIFIED MIT MODIFIED MIT MODIFIED MIT MODIFIED MIT MODIFIED MIT			MH	MANHOLE	———DE———	DEIONIZED WATER PIPING (DE)
Description Section			MTD	MOUNTED	———DI———	DISTILLED WATER PIPING (DI)
March Marc	BFV	BUTTERFLY VALVE	MTR		DI .	DIOTIELES WITTERT II INO (DI)
March Marc					———F———	FIRE PROTECTION PIPING (F OR FP)
Campaigness						
SECOLAMBRID SECOLAMBRID SECONAMBRID	CFM	CUBIC FEET PER MINUTE				GAS PIPING (G)
Color	CIRC	CIRCULATING				HOT WATER PIPING (HW)
COLUMN C	CLG	CEILING				THE TWATERT II IN COMMY
ONSTRUCTION ON PROPERTY OF THE	COL	COLUMN			————140°———	140° HOT WATER PIPING (HW)
ONTHACTOR PO	CONST	CONSTRUCTION				
U. U. C. U	CONTR	CONTRACTOR	PD	PRESSURE DROP		HOT WATER RETURN PIPING (HWR)
Color Note	CU FT	CUBIC FEET	PH	PHASE	140°	140° HOT WATER RETURN PIPING (HWR)
DE DESCRIPTOR PS PS PS POUNDS PER SURARE FOOT ASSOLATE Y LAS VACUUM PPING (V) DE DE <td></td> <td></td> <td>PRESS</td> <td>PRESSURE</td> <td></td> <td></td>			PRESS	PRESSURE		
DI DI STILLED WATER PSIA POWINS FER SOLARE NOT ASSOLUTE A MEDICAL AIR PIPMO (A)			PS	PIPE SUPPORT	V	LAB VACUUM PIPING (V)
DISCHARGE DISC	DI	DISTILLED WATER	PSIA	POUNDS PER SQUARE INCH ABSOLUTE		
ELECTRICAL CONTRACTOR					————A———	MEDICAL AIR PIPING (A)
EFF EFFORMOY REV REVOLUTIONS — N NTROGEN PIPING (N) EQUIP EQUIPMENT RO REVERSE OSMOSIS — N NITROGEN PIPING (N) ECTE ETCELAR RPM REVOLUTIONS PER NINUTE — N NITROGEN PIPING (N) ETC ETCELAR RPM REVOLUTIONS PER NINUTE — N NITROGEN PIPING (N) ETC ETCELAR RPM REVOLUTIONS PER NINUTE — N NITROGEN PIPING (N) ETC ETCHANGO REVOLUTIONS PER NINUTE — O OXYGEN PIPING (N) ETC ETCHANGO SOLOTO — O OXYGEN PIPING (N) FE FARRENHEIT S SCOOND — O OXYGEN PIPING (N) FE FARRENHEIT S SCOOND — REVERSE OSMOSIS PIPING (R) FE FARRENHEIT S SCOOND — REVERSE OSMOSIS PIPING (R) FE FARRENHEIT S SCOOND — REVERSE OSMOSIS PIPING (R) FE FARRENHEIT S SCOOND — SAI ASAITARY PIPING (R) FE <td>DWG</td> <td>DRAWING</td> <td></td> <td></td> <td>V</td> <td>MEDICAL VACUUM PIPING (V)</td>	DWG	DRAWING			V	MEDICAL VACUUM PIPING (V)
SOUPMENT			REV	REVOLUTIONS		
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EXSING					NO	NITPOLIS OVIDE DIDING (NO)
F	EXIST					NITROUS OAIDE FIFING (NO)
FIRE PROTECTION			S	SECOND	0	OXYGEN PIPING (O)
FOM BELOW	F	FIRE PROTECTION	SAN	SANITARY		
FLO	FB	FROM BELOW	SCH	SCHEDULE	———RO——	REVERSE OSMOSIS PIPING (RO)
FLOOR	FD	FLOOR DRAIN	SOV	SHUT-OFF VALVE	SAN	SANITARY PIPING (SAN)
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IPS INTERNATIONAL PIPE STANDARD		INVERT ELEVATION INSULATION				

——	PIPE TEE UP
	PIPE TEE DOWN
o	PIPE ELBOW UP
c	PIPE ELBOW DOWN
_	
	DIRECTION OF FLOW GATE VALVE OR
×	GENERIC ISOLATION VALVE
Ю	BALL VALVE
——-П	BUTTERFLY VALVE
5	STRAINER
	BALANCING VALVE
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——	UNION, SCREWED
E	CAPPED PIPE
a	CLEAN OUT
Ø 	PRESSURE GAUGE WITH SHUT OFF COCK
<u>[]</u>	THERMOMETER WITH
\$	SEPARABLE WELL SAFETY OR RELIEF VALVE
.	PRESSURE REDUCING VALVE
<u>.</u>	CONNECT TO EXISTING
——XI——	THERMOSTATIC MIXING VALVE
-	EXTERIOR WALL HYDRANT
₫	HOSE-BIBB
.	HOT & COLD WATER HOSE-BIBB
	PIPE CONNECTION
	NEW SANITARY/STORM CONNECTION
	PIPE BREAK
0	ROOF PENETRATION
(0)	ROOF PENETRATION ON ROOF
\otimes	SITE CURB BOX
<u> </u>	PRESSURE / FLOW SWITCH
—	WATER HAMMER ARRESTOR
\$ ^{ES}	EMERGENCY PUSHBUTTON
	DUALCHECK BACKFLOW PREVENTER
	REDUCED PRESSURE ZONE (RPZ)
0	BACKFLOW PREVENTER
_	FLOOR DRAIN (FD)
0	FLOOR SINK (FS)
₩ M	FUNNEL FLOOR DRAIN (FFD)
——————————————————————————————————————	SOLENOID VALVE
── ऄ──	NATURAL GAS COCK
$\langle x \rangle$	NUMBERED NOTE PER DRAWING
X	EQUIPMENT BY OTHERS

ELECTRICAL REQUIREMENTS FOR PLUMBING

GENERAL REQUIREMENTS

- A. PLUMBING CONTRACTOR SHALL PROVIDE MECHANICAL EQUIPMENT WITH VOLTAGES AND OTHER ELECTRICAL CHARACTERISTICS AS INDICATED ON THE DRAWINGS AND WITHIN THE SPECIFICATIONS.
- B. ALL STARTERS, DISCONNECT SWITCHES, MOTOR CONTROL CENTERS, AND VARIABLE FREQUENCY DRIVES, FOR EQUIPMENT PROVIDED UNDER DIVISION 22, SHALL BE FURNISHED UNDER DIVISION 22 AND INSTALLED UNDER DIVISION 26. FACTORY MOUNTED STARTERS, DISCONNECTS SWITCHES, AND VARIABLE FREQUENCY DRIVES SHALL BE FURNISHED AND INSTALLED UNDER DIVISION 22. PLUMBING CONTRACTOR SHALL PROVIDE STARTERS, DISCONNECT SWITCHES, MOTOR CONTROL CENTERS AND VARIABLE FREQUENCY DRIVES IN ACCORDANCE WITH DIVISION 26.
- C. PLUMBING CONTRACTOR SHALL SUBMIT WIRING DIAGRAMS TO THE ARCHITECT/ENGINEER FOR APPROVAL AND PROVIDE APPROVED DIAGRAMS TO THE ELECTRICAL CONTRACTOR SO THAT THE ELECTRICAL WORK MAY BE PROPERLY ACCOMPLISHED.
- D. PLUMBING CONTRACTOR SHALL FULLY COOPERATE WITH THE OTHER DIVISIONS AND TRADES ON THE PROJECT, AND THEIR MANUFACTURERS, IN PROMPTLY PROVIDING THE INFORMATION REQUIRED FOR PROPER COORDINATION OF MOTOR PROTECTION, CONTROL EQUIPMENT AND WIRING, AND THE OTHER CHARACTERISTICS OF THE EQUIPMENT.
- E. IT SHALL BE THE RESPONSIBILITY OF THE DIVISION 23 AND DIVISION 26 CONTRACTORS TO CHECK FOR ADEQUACY OF SUPPLY WIRING. OVERCURRENT PROTECTION, PROPER VOLTAGE, PHASE ROTATION AND FINAL LOCATION OF EQUIPMENT PROVIDED PRIOR TO THE RUNNING OF ANY CONDUIT OR WIRING. COORDINATE WITH DIVISION 26 TO ASSURE PROPER ELECTRICAL SERVICE IS PROVIDED TO **EQUIPMENT UNDER DIVISION 22.**
- F. EQUIPMENT CONNECTIONS SHALL BE MADE THROUGH CONDUIT OR RACEWAYS IN ACCORDANCE WITH DIVISION 26, WITH THE EXCEPTION THAT CONNECTIONS TO MOTORS SHALL BE MADE THROUGH LIQUID TIGHT FLEXIBLE METAL CONDUIT WITH EQUIPMENT GROUNDING CONDUCTOR.
- POWER REQUIREMENTS A. ALL POWER WIRING FOR MECHANICAL EQUIPMENT PROVIDED UNDER DIVISION 22 SHALL BE FURNISHED AND INSTALLED UNDER DIVISION 26 TO THE POINT OF FINAL CONNECTION. EXCEPT WHERE SPECIFICALLY INDICATED OTHERWISE, ALL POWER WIRING TO THE
- B. FINAL ELECTRICAL POWER CONNECTIONS TO ALL EQUIPMENT SHALL BE FURNISHED AND INSTALLED UNDER DIVISION 26. IN GENERAL, THE POINT OF FINAL CONNECTION SHALL BE THE EQUIPMENT CONTROL PANEL PROVIDED BY DIVISION 22. WIRE LEADS OF ADEQUATE LENGTH TO ENSURE A PROPER CONNECTION AT THE FINAL LOCATION SHALL BE FURNISHED AND INSTALLED

DIVISION 22 SHALL BE ACCOMPLISHED UNDER DIVISION 26.

POINT OF FINAL CONNECTION FOR EQUIPMENT PROVIDED UNDER

C. WIRING, OVERCURRENT PROTECTION DEVICES, VOLTAGE, PHASE, ROTATION AND FINAL LOCATION OF ALL EQUIPMENT PROVIDED UNDER DIVISION 22 SHALL BE COORDINATED WITH ALL SIMILAR DEVICES AND POWER WIRING FURNISHED AND INSTALLED UNDER DIVISION 26. COORDINATION SHALL BE ACCOMPLISHED PRIOR TO THE RUNNING OF ANY CONDUIT OR WIRING.

. CONTROL REQUIREMENTS

UNDER DIVISION 26.

- A. ALL CONTROL WIRING (LINE VOLTAGE AND/OR LOW VOLTAGE) FOR MECHANICAL EQUIPMENT PROVIDED UNDER DIVISION 22, SHALL BE FURNISHED AND INSTALLED UNDER DIVISION 22. WIRING FROM THE POWER SOURCE TO ALL CONTROL PANELS, DDC CONTROL PANELS, STARTERS, AND OTHER CONTROL EQUIPMENT REQUIRED FOR A COMPLETE AND OPERABLE CONTROL SYSTEM SERVING MECHANICAL EQUIPMENT PROVIDED UNDER DIVISION 22 SHALL BE FURNISHED AND INSTALLED UNDER DIVISION 22.
- B. ALL WIRING FROM CONTROL PANELS TO CONTROL DEVICES FOR MECHANICAL EQUIPMENT PROVIDED UNDER DIVISION 22 SHALL BE FURNISHED AND INSTALLED UNDER DIVISION 22. ALL CONTROL WIRE AND CONDUIT SHALL COMPLY WITH THE NATIONAL ELECTRIC CODE AND DIVISION 26 OF THE SPECIFICATIONS. ALL CONTROL WIRING SHALL BE IN CONDUIT.

SPECIALTIES

- A. EMERGENCY SHUT-DOWN SYSTEMS SHALL BE PROVIDED UNDER DIVISION 22, INCLUDING ALL CONDUIT WIRING BETWEEN VALVES, RELAY PANELS, PUSHBUTTONS, AND ANY OTHER PIECE OF EQUIPMENT REQUIRED FOR A COMPLETE AND OPERABLE CONTROL SYSTEM.
- B. POWER WIRING FOR THE EMERGENCY SHUT-DOWN SYSTEMS SHALL BE PROVIDED UNDER DIVISION 22. THE POINT OF CONNECTION FOR THE ELECTRICAL CONTRACTOR SHALL BE THE RELAY PANELS PROVIDED BY THE PLUMBING CONTRACTOR.
- C. ALL CONTROL WIRING FROM MEDICAL GAS PRESSURE-SENSING DEVICES TO MEDICAL GAS ALARM PANELS SHALL BE UNDER DIVISION 22. THE ELECTRICAL CONTRACTOR SHALL PROVIDE POWER WIRING TO THE ALARM PANEL.

PROJECT GENERAL NOTES

CODES AND REGULATIONS.

- 1. PROVIDE ALL MATERIALS AND EQUIPMENT AND PERFORM ALL LABOR REQUIRED TO INSTALL COMPLETE AND OPERABLE MECHANICAL SYSTEMS AS INDICATED ON THE DRAWINGS, AS SPECIFIED AND AS REQUIRED BY CODE.
- 2. CONTRACT DOCUMENT DRAWINGS FOR PLUMBING WORK ARE DIAGRAMMATIC AND ARE INTENDED TO CONVEY SCOPE AND GENERAL ARRANGEMENT ONLY.
- 3. INSTALL ALL PLUMBING EQUIPMENT AND APPURTENANCES IN ACCORDANCE WITH MANUFACTURERS' RECOMMENDATIONS, CONTRACT DOCUMENTS AND APPLICABLE
- 4. PROVIDE VIBRATION ISOLATION FOR ALL PLUMBING EQUIPMENT TO PREVENT TRANSMISSION OF VIBRATION TO BUILDING STRUCTURE.
- PROVIDE VIBRATION ISOLATORS FOR ALL PIPING SUPPORTS CONNECTED TO, AND WITHIN 50 FT OF ISOLATED EQUIPMENT (EXCEPT AT BASE ELBOW SUPPORTS AND ANCHOR POINTS) THROUGHOUT MECHANICAL EQUIPMENT ROOMS.
- 6. THE LOCATION OF EXISTING EQUIPMENT AND UTILITIES IS SHOWN IN AN APPROXIMATE WAY ONLY. THE CONTRACTOR SHALL DETERMINE THE EXACT LOCATION OF ALL EXISTING UTILITIES BEFORE COMMENCING WORK. THE CONTRACTOR SHALL PAY FOR AND REPAIR ALL DAMAGES CAUSED BY FAILURE TO EXACTLY LOCATE AND PRESERVE ANY AND ALL UNDERGROUND UTILITIES UNLESS OTHERWISE INDICATED.
- 7. COORDINATE CONSTRUCTION OF ALL PLUMBING WORK WITH ARCHITECTURAL, STRUCTURAL, CIVIL, ELECTRICAL, HVAC WORK, ETC., SHOWN ON OTHER CONTRACT DOCUMENT DRAWINGS.
- MAINTAIN A MINIMUM OF 6'-8" CLEARANCE TO THE UNDERSIDE OF PIPES, DUCTS. CONDUITS, SUSPENDED EQUIPMENT, ETC., THROUGHOUT ACCESS ROUTES IN MECHANICAL ROOMS.
- 9. CEILING AREAS DIRECTLY BELOW HEATING EQUIPMENT MUST BE KEPT CLEAR OF ALL OTHER UTILITIES. INCLUDING FIRE PROTECTION COMPONENTS. TO ALLOW FOR UNIT ACCESS FOR SERVICING AND/OR REMOVAL. WHERE PIPING, CONDUIT, AND LIKE ITEMS ARE SHOWN IN THIS AREA. IT IS THE ENGINEER'S INTENTION THAT THIS PIPING BE INSTALLED ABOVE THE EQUIPMENT AND THAT BRANCH VALVING, WHERE APPLICABLE, BE INSTALLED IN AN ACCESSIBLE LOCATION. PROVIDE NECESSARY OFFSETS, ETC., TO ACCOMPLISH THIS CLEARANCE REQUIREMENT.
- 10. ALL TESTS SHALL BE COMPLETED BEFORE ANY MECHANICAL EQUIPMENT OR PIPING INSULATION IS APPLIED.
- 11. LOCATE ALL TEMPERATURE, PRESSURE, AND FLOW MEASURING DEVICES IN ACCESSIBLE LOCATIONS WITH THE STRAIGHT SECTION OF PIPE OR DUCT UP- AND
- DOWNSTREAM AS RECOMMENDED BY THE MANUFACTURER FOR PROPER ACCURACY. 12. TESTING, ADJUSTING, AND BALANCING AGENCY SHALL BE A MEMBER OF THE ASSOCIATED AIR BALANCE COUNCIL (AABC) OR THE NATIONAL ENVIRONMENTAL BALANCING BUREAU (NEBB). TESTING, ADJUSTING, AND BALANCING SHALL BE PERFORMED IN ACCORDANCE WITH THE AABC STANDARDS.
- 13. WHERE TWO OR MORE ITEMS OF THE SAME TYPE OF EQUIPMENT ARE REQUIRED, THE PRODUCT OF ONE MANUFACTURER SHALL BE USED.

COORDINATE ALL PIPING DIMENSIONS BEFORE FABRICATION.

- 14. COORDINATE ALL EQUIPMENT CONNECTIONS WITH MANUFACTURERS' CERTIFIED DRAWINGS. COORDINATE AND PROVIDE ALL PIPING TRANSITIONS REQUIRED FOR FINAL EQUIPMENT CONNECTIONS TO FURNISHED EQUIPMENT. FIELD VERIFY AND
- 15. ALL CONTROL WIRE AND CONDUIT SHALL COMPLY WITH THE NATIONAL ELECTRIC CODE AND DIVISION 26 OF THE SPECIFICATION.
- 16. CONCRETE HOUSEKEEPING PADS FOR PLUMBING EQUIPMENT SHALL BE SIZED AND LOCATED BY THE PLUMBING CONTRACTOR. MINIMUM CONCRETE PAD THICKNESS SHALL BE 6 INCHES. PAD SHALL EXTEND BEYOND THE EQUIPMENT A MINIMUM OF 3 INCHES ON EACH SIDE. CONCRETE HOUSEKEEPING PADS SHALL BE PROVIDED BY THE GENERAL CONTRACTOR. IT SHALL BE THE RESPONSIBILITY OF THE PLUMBING CONTRACTOR TO COORDINATE THE SIZE AND LOCATION OF CONCRETE HOUSEKEEPING PADS WITH THE GENERAL CONTRACTOR.
- 17. REINFORCEMENT, DETAILING, AND PLACEMENT OF CONCRETE SHALL CONFORM TO ASTM 315 AND ACI 318. CONCRETE SHALL CONFORM TO ASTM C94. CONCRETE WORK SHALL CONFORM TO ACI 318, PART ENTITLED "CONSTRUCTION REQUIREMENTS." COMPRESSIVE STRENGTH IN 28 DAYS SHALL BE 3,000 PSI. TOTAL AIR CONTENT OF EXTERIOR CONCRETE SHALL BE BETWEEN 5 AND 7 PERCENT BY VOLUME. SLUMP SHALL BE BETWEEN 3 AND 4IN. CONCRETE SHALL BE CURED FOR 7 DAYS AFTER PLACEMENT.
- 18. WHEN PLUMBING WORK IS SUBCONTRACTED, IT SHALL BE THE PLUMBING CONTRACTOR'S RESPONSIBILITY TO COORDINATE SUBCONTRACTORS AND THE ASSOCIATED CONTRACTS. WHEN DISCREPANCIES ARISE PERTAINING TO WHICH CONTRACTOR PROVIDED A PARTICULAR ITEM OF THE PLUMBING CONTRACT OR WHICH CONTRACTOR PROVIDES FINAL CONNECTIONS FOR A PARTICULAR ITEM OF THE PLUMBING CONTRACT, IT SHALL BE BROUGHT TO THE ATTENTION OF THE PLUMBING CONTRACTOR, WHOSE DECISION SHALL BE FINAL.
- 19. THE LOCATIONS OF ALL ITEMS SHOWN ON THE DRAWINGS OR CALLED FOR IN THE SPECIFICATIONS THAT ARE NOT DEFINITELY FIXED BY DIMENSIONS ARE APPROXIMATE ONLY. THE EXACT LOCATIONS NECESSARY TO SECURE THE BEST CONDITIONS AND RESULTS MUST BE DETERMINED BY THE PROJECT SITE CONDITIONS AND SHALL HAVE THE APPROVAL OF THE ENGINEER BEFORE BEING INSTALLED. DO NOT SCALE DRAWINGS.
- 20. ALL MISCELLANEOUS STEEL REQUIRED TO ENSURE PROPER INSTALLATION AND AS SHOWN IN DETAILS FOR PIPING AND EQUIPMENT (UNLESS OTHERWISE NOTED) SHALL BE FURNISHED AND INSTALLED BY THE PLUMBING CONTRACTOR.
- 21. PROVIDE ACCESS PANELS FOR INSTALLATION IN WALLS AND CEILINGS, WHERE REQUIRED TO SERVICE VALVES AND OTHER CONCEALED PLUMBING EQUIPMENT. ACCESS PANELS SHALL BE TURNED OVER TO THE GENERAL CONTRACTOR FOR
- 22. ALL EQUIPMENT, PIPING, ETC. SHALL BE SUPPORTED AS DETAILED, SPECIFIED AND REQUIRED TO PROVIDE A VIBRATION-FREE INSTALLATION.
- 23. ALL PIPING AND EQUIPMENT SUPPORTED FROM STRUCTURAL STEEL SHALL BE COORDINATED WITH THE GENERAL CONTRACTOR. ALL ATTACHMENTS TO STEEL BAR JOISTS, TRUSSES, OR JOISTS GIRDERS SHALL BE AT PANEL POINTS. PROVIDE BEAM CLAMPS MEETING MSS STANDARDS. WELDING TO STRUCTURAL MEMBERS SHALL NOT BE PERMITTED. THE USE OF C-CLAMPS SHALL NOT BE PERMITTED.
- 24. MECHANICAL EQUIPMENT, AND PIPING SHALL NOT SUPPORTED FROM A METAL DECK.
- 25. LOCATIONS AND SIZES OF FLOOR, WALL AND ROOF OPENINGS SHALL BE COORDINATED WITH ALL OTHER TRADES INVOLVED.
- 26. ALL OPENINGS IN FIRE AND/OR SMOKE RATED CONSTRUCTION DUE TO PIPING, CONDUIT, ETC. SHALL BE FIRE STOPPED WITH AN APPROVED LISTED AND LABELED FIRE STOPPING MATERIAL
- 27. CONTRACTOR SHALL DETERMINE THE EXACT LOCATION OF ALL EXISTING EQUIPMENT AND UTILITIES BEFORE COMMENCING WORK.

PLUMBING PIPING GENERAL NOTES

JURISDICTION.

- 1. ALL SANITARY PIPING BELOW SLAB SHALL BE A MINIMUM OF 4" Ø, UNLESS NOTED OR AS REQUIRED BY THE LOCAL AUTHORITY HAVING
- ALL SANITARY AND STORM PIPING 2" AND SMALLER SHALL BE SLOPED AT A MINIMUM 1/4" PER FOOT, AND ALL SANITARY AND STORM PIPING 3" AND LARGER SHALL BE SLOPED AT A MINIMUM OF 1/8" PER FOOT, UNLESS

OTHERWISE NOTED OR AS REQUIRED BY THE LOCAL AUTHORITY HAVING

- 3. ALL PIPING WORK SHALL BE COORDINATED WITH ALL TRADES INVOLVED. OFFSETS IN PIPING AROUND OBSTRUCTIONS SHALL BE PROVIDED AT NO
- ADDITIONAL COST TO THE OWNER. 4. PROVIDE HOSE END DRAIN VALVES AT THE BOTTOM OF ALL RISERS AND
- LOW POINTS.
- 5. UNLESS OTHERWISE NOTED, ALL PIPING IS OVERHEAD, TIGHT TO THE UNDERSIDE OF THE STRUCTURE OR SLAB, WITH SPACE FOR INSULATION IF REQUIRED.
- 6. INSTALL PIPING SO ALL VALVES, STRAINERS, UNIONS, TRAPS, FLANGES, AND OTHER APPURTENANCES REQUIRING ACCESS ARE ACCESSIBLE.
- 7. ALL VALVES SHALL BE INSTALLED SO THAT THE VALVE REMAINS IN SERVICE WHEN EQUIPMENT OR PIPING ON THE EQUIPMENT SIDE OF THE VALVE IS REMOVED.
- 8. ALL BALANCING VALVES AND BUTTERFLY VALVES SHALL BE PROVIDED WITH POSITION INDICATORS AND THE MAXIMUM ADJUSTABLE STOPS (MEMORY STOPS).
- 9. PROVIDE CHAINWHEEL OPERATORS FOR ALL VALVES IN EQUIPMENT ROOMS MOUNTED GREATER THAN 7'-0" ABOVE FLOOR LEVEL: CHAIN SHALL EXTEND TO 7'-0" ABOVE FLOOR LEVEL.
- 10. ALL VALVES (EXCEPT CONTROL VALVES) AND STRAINERS SHALL BE THE FULL SIZE OF THE PIPE BEFORE REDUCING IN SIZE TO MAKE CONNECTIONS TO EQUIPMENT AND CONTROLS.
- 11. PROVIDE A LINE SIZE STRAINER UPSTREAM OF EACH AUTOMATIC VALVE. PROVIDE A SHUTOFF VALVE ON EACH SIDE OF A STRAINER.
- 12. UNIONS AND/OR FLANGES SHALL BE INSTALLED AT EACH PIECE OF EQUIPMENT, IN BYPASSES, AND IN LONG PIPING RUNS (100 FT OR MORE)
- TO PERMIT DISASSEMBLY FOR ALTERNATION AND REPAIRS. 13. INSTALL ALL PIPING WITHOUT FORCING OR SPRINGING.
- 14. ALL VALVES SHALL BE ADJUSTED FOR SMOOTH AND EASY OPERATION.
- 15. PLUMBING CONTRACTOR SHALL ROUGH-IN AND CONNECT ALL EQUIPMENT REQUIRING GAS, WATER, WASTE, VENT, AND/OR COMPRESSED AIR WHETHER OR NOT EQUIPMENT IS FURNISHED UNDER THIS CONTRACT. ALSO, PLUMBING CONTRACTOR TO FURNISH AND INSTALL ALL NECESSARY PIPE, FITTINGS, VALVES, TRAPS, ETC., REQUIRED FOR A COMPLETE INSTALLATION, LEAVING SAME READY FOR SERVICE.
- 16. ALL CEILING AREAS THROUGHOUT THE BUILDING AS A PART OF THIS PROJECT ARE TO BE CONSIDERED 'PLENUM AREAS' AND THEREFORE THE CONTRACTOR MUST BE AWARE OF THE ACCEPTABLE PIPING MATERIAL TO BE USED. REFERENCE MUST BE MADE TO THE PLUMBING SPECIFICATIONS FOR ADDITIONAL INFORMATION.

MYERSVILLE

COMMUNITY

PROJECT INFORMATION

PROJECT TITLE

PROJECT ADDRESS 8 HARP PLACE MYERSVILLE, MD 21773

FREDERICK COUNTY, **MARYLAND DEPARTMENT OF PUBLIC WORKS**

PROJECT TEAM



ASSOCIATES, INC.

ARCHITECTS

FREDERICK, MD | 21701-5680 P: 301.662.8611 | F: 301.662.8632 NOELKERHULL.COM PA | MD | VA

STRUCTURAL ENGINEER

6 NORTH EAST STREET, SUITE 300


ABEL CONSULTING ENGINEERS 9055 COMPRINT COURT, SUITE 370 | GAITHERSBURG, MD | 20878 P: 301.258.8884 | F: 301.258.9457

> CJL ENGINEERING 3 WEST SECOND STREET | FREDERICK, MD | 21701

> > P: 301.695.9424 | F: 301.293.6338

HARRIS, SMARIGA & ASSOCIATES, INC. 125 SOUTH CARROLL STREET | FREDERICK, MD | 21701 P: 301.662.4488 | F: 301.662.4906

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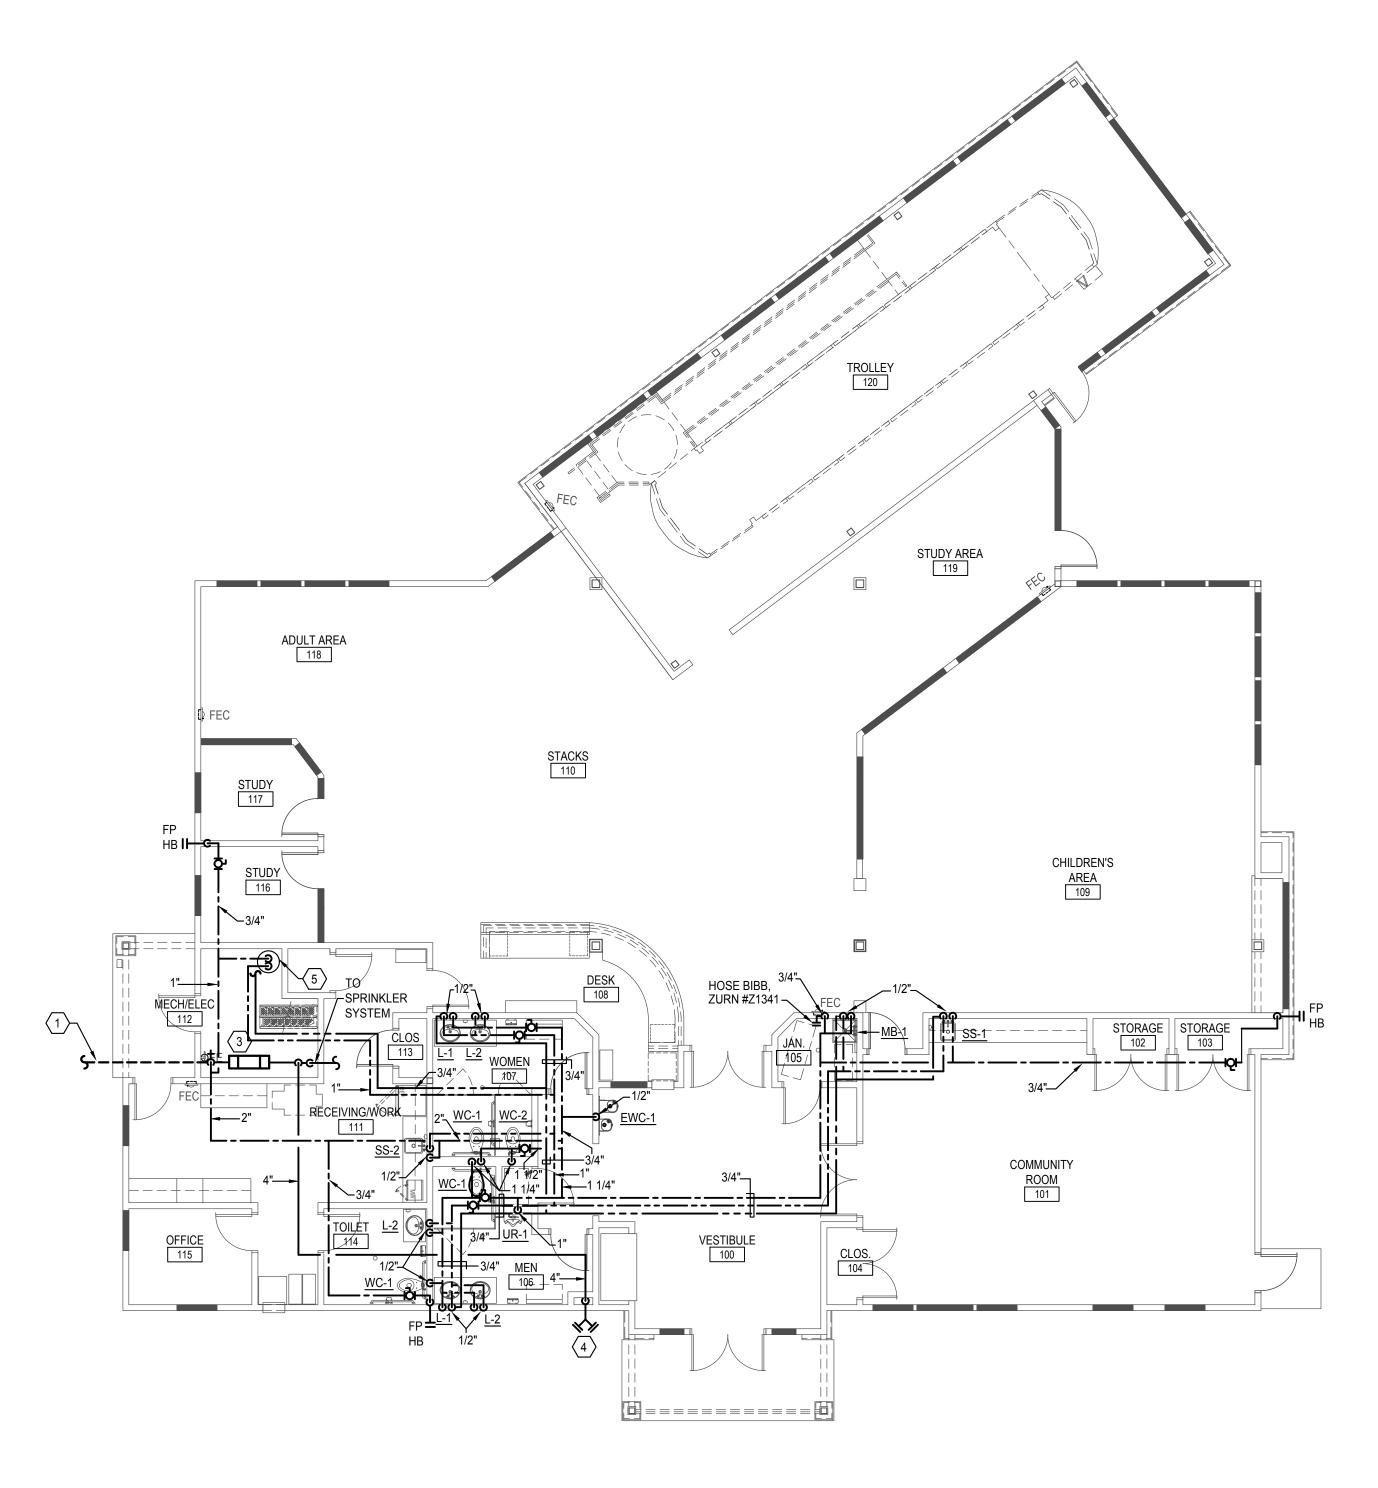
SHEET INFORMATION

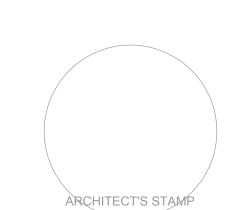	<u>REVISIONS</u>	
REV. #:	DESCRIPTION:	DATE:
-	-	-


PROJECT STATUS

16-1043 JOB NUMBER: 10 APRIL 2018 ISSUE DATE: **AS INDICATED**


PLUMBING SYMBOLS, ABBREVIATIONS, AND NOTES



1 FLOOR PLAN - DOMESTIC WATER

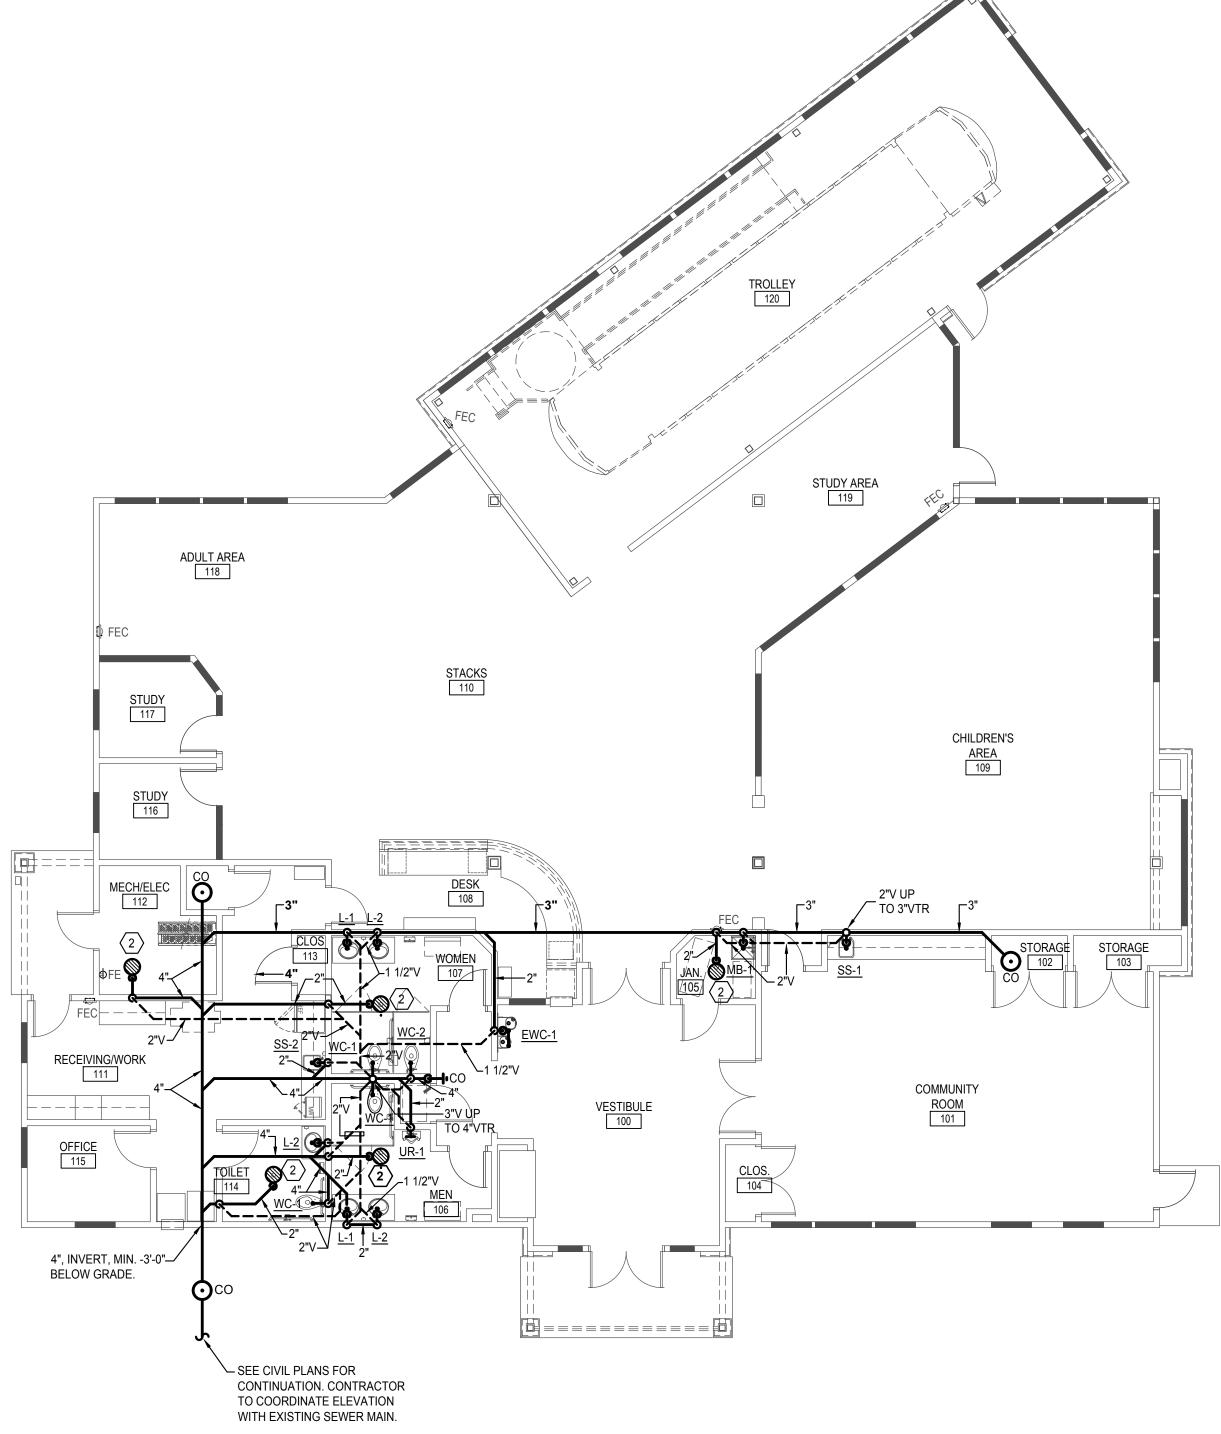

FLOOR PLAN - SOIL AND VENT

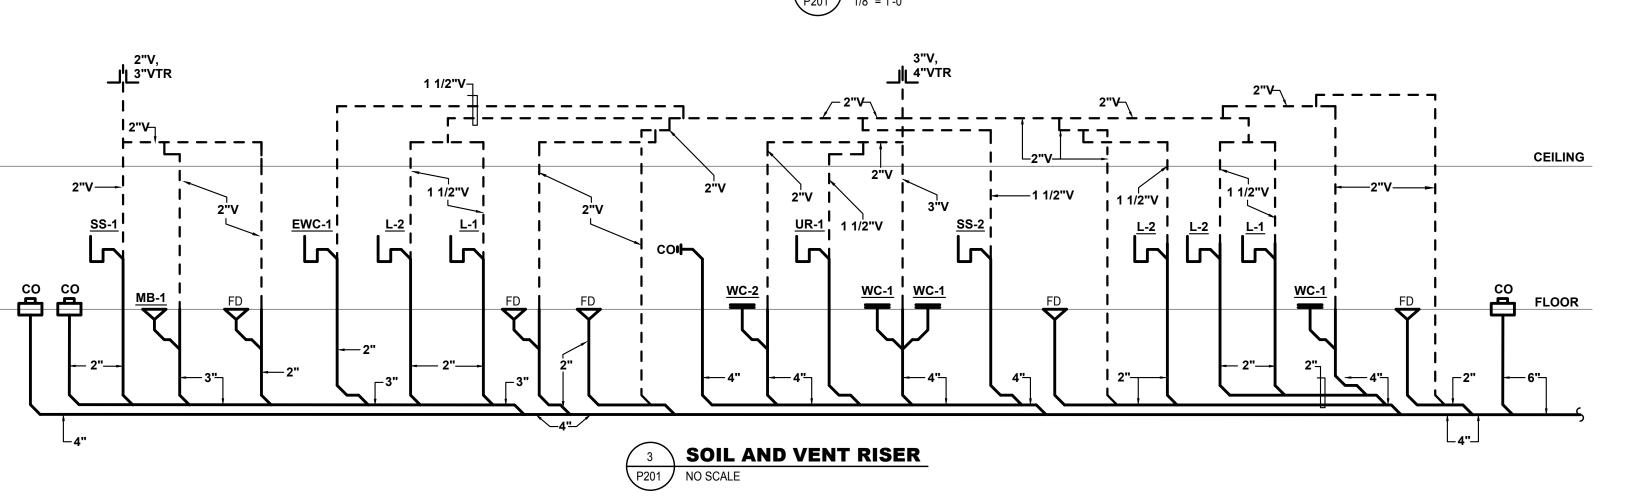

NUMBERED NOTES:

- (1) 6" SPRINKLER/WATER ENTRANCE. SEE DETAIL #1/P701.
 (2) FLOOR DRAIN, PROVIDE TRAP PRIMER. SEE DETAIL #3/P701.
- SPRINKLER DOUBLE CHECK BACKFLOW PREVENTER. MAINTAIN MIN. 3'-0" CLEARANCE IN FRONT.
- 3'-0" CLEARANCE IN FRONT.

 REMOTE FIRE DEPT. CONNECTION. COORDINATE FINAL LOCATION WITH LOCAL FIRE MARSHAL.
- 5 ELECTRIC WATER HEATER (DWH-1). SEE DETAIL #2/P701. 1" HW, CW AND 3/4" HW RECIRC.

GENERAL NOTES:

G1. CONTRACTOR TO PROVIDE ACCESS PANELS FOR VALVES ABOVE DRYWALL CEILINGS.

PROJECT INFORMATION

PROJECT TITLE

MYERSVILLE COMMUNITY LIBRARY

PROJECT ADDRESS

8 HARP PLACE
MYERSVILLE, MD 21773

FREDERICK COUNTY,
MARYLAND
DEPARTMENT OF PUBLIC
WORKS





NOELKER AND HULL associates, inc.

6 NORTH EAST STREET, SUITE 300 FREDERICK, MD | 21701-5680 P: 301.662.8611 | F: 301.662.8632 NOELKERHULL.COM PA | MD | VA

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ABEL CONSULTING ENGINEERS

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M/E/P ENGINEER


CJL ENGINEERING

3 WEST SECOND STREET | FREDERICK, MD | 21701 P: 301.695.9424 | F: 301.293.6338

HARRIS, SMARIGA & ASSOCIATES, INC.

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REV. #: DESCRIPTION: DATE:
- - -

PROJECT STATUS

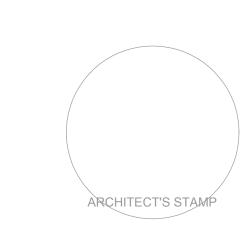
JOB NUMBER: 16-1043
ISSUE DATE: 10 APRIL 2018
SCALE: AS INDICATED
SHEET TITLE:

FLOOR PLANS - PLUMBING

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SHEET NUMBER:


P201

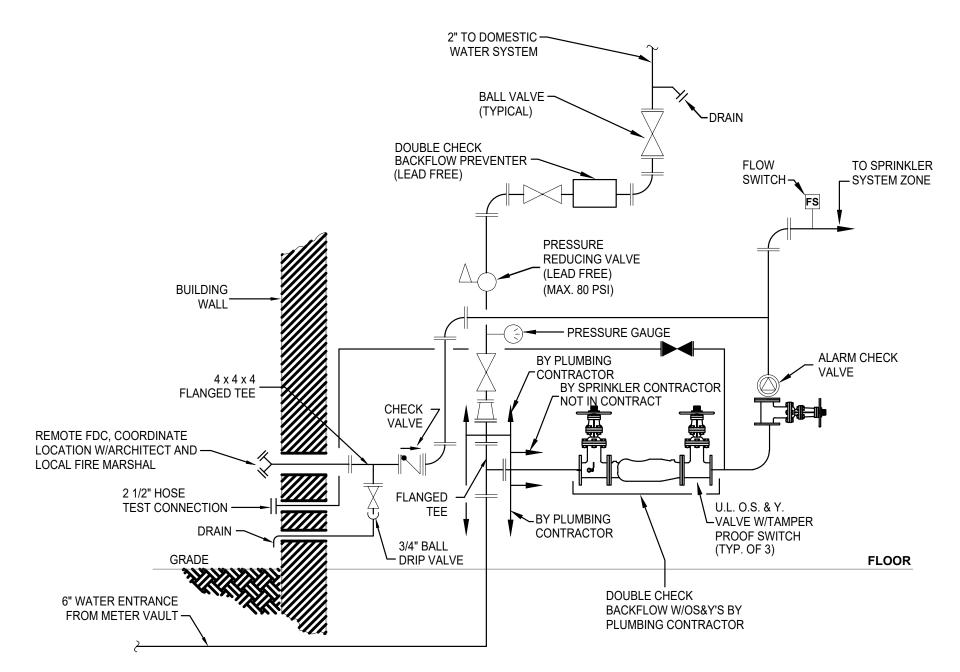

TEST DATE: 10/18/17

HYDRANT LOCATION: HARP PLACE

FOR DIMENSIONS & ROUGH-IN LOCATIONS. SPRINKLER DESIGN CRITERIA: GPM: 1126 STATIC: 80 PSI RESIDUAL: 76 PSI

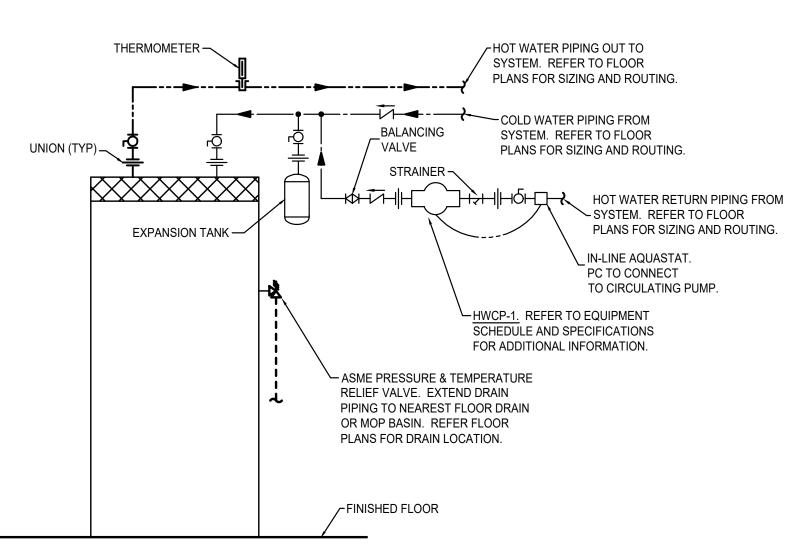

ELECTRIC WATER HEATER PIPING SCHEMATIC (WITH CIRCULATING PUMP)

CO - IRON FERRULE (TAMPER PROOF)

W/METAL COUNTER-SUNK

FLOOR COVER

SCREW PLUG AND FINISHED —

NO SCALE NOTE: PROVIDE LEAD FREE PIPING, FITTINGS, VALVES ETC.

	PLUMBING	G FIXTURE SCHEDULE			
<u>ID#</u>	PLUMBING FIXTURE DESCRIPTION	WASTE & VENT CONNECTION SIZES	WATER SUPPLY CONNECTION SIZES	LOCATION	COMMENTS
EWC-1	WALL MOUNTED DUAL HEIGHT WATER COOLER W/BOTTLE FILLER - STANDARD & ADA HEIGHT	1 1/4" WASTE & VENT	1/2" CW	VESTIBULE	NOTE 1
<u>FD-1</u>	FLAT FINISHED TOP FOR FINISHED AREAS	2" WASTE CONNECTION	1/2" CW	SEE FLOOR PLAN	NOTE 1, 2
<u>L-1</u>	INTEGRAL COUNTER BOWL WITH METERING FAUCET - STD. HEIGHT	1 1/2" WASTE & VENT	1/2" HW & CW	TOILET ROOMS	NOTE 1
<u>L-2</u>	INTEGRAL COUNTER BOWL WITH METERING FAUCET - ADA HEIGHT	1 1/2" WASTE & VENT	1/2" HW & CW	TOILET ROOMS	NOTE 1
<u>SS-1</u>	UNDER COUNTER MOUNT STAINLESS STEEL SINGLE BOWL WITH MANUAL FAUCET - ADA HEIGHT	1 1/2" WASTE & VENT	1/2" HW & CW	COMMUNITY ROOM	NOTE 1
<u>SS-2</u>	UNDER COUNTER MOUNT STAINLESS STEEL SINGLE BOWL WITH MANUAL FAUCET - ADA HEIGHT	1 1/2" WASTE & VENT	1/2" HW & CW	RECEIVING	NOTE 1
<u>WC-1</u>	FLOOR MOUNTED WATER CLOSET WITH MANUAL FLUSH VALVE - ADA HEIGHT	4" SOIL, 2" VENT	1 1/4" CW	TOILET ROOMS	NOTE 1
<u>WC-2</u>	FLOOR MOUNTED WATER CLOSET WITH MANUAL FLUSH VALVE - STANDARD HEIGHT	4" SOIL, 2" VENT	1 1/4" CW	TOILET ROOMS	NOTE 1
<u>MB-1</u>	FLOOR MOUNTED MOP BASIN	3" WASTE & 2" VENT	1/2" HW & CW	JANITOR 105	NOTE 1
<u>UR-1</u>	WALL MOUNTED URINAL WITH MANUAL FLUSH VALVE - ADA HEIGHT	2" WASTE & 2" VENT	1" CW	TOILET ROOM	NOTE 1


NOTES:

1. REFER TO SPECIFICATIONS FOR MANUFACTURER INFORMATION, TRIM INFORMATION, ACCESSORIES, AND ADDITIONAL INFORMATION.

2. PROVIDE TRAP PRIMER.


PUMP SCHEDULE									
ID#	SYSTEM	GPM	FT. HD	HP	RPM	VOLTAGE	REMARKS	MANUF	MODEL
HWCP-1	DOMESTIC RECIRC. PUMP 140°	8	15	FRAC	1750	120V/1Ø	ALL BRONZE - "IN-LINE"	B & G	PR SERIES

ELECTRIC WATER HEATER SCHEDULE										
MARK GALLONS GPH @										
DWH-1	30	21	4.5	240V/1Ø	U.L., ASHRAE 90-80 W/DRAIN PAN	AO SMITH	ENT-30			

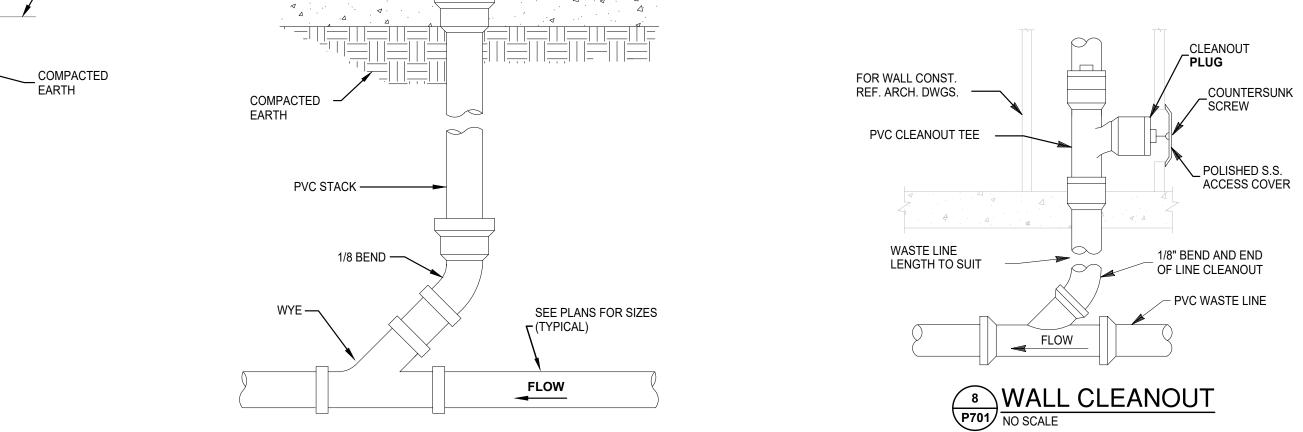



1 SPRINKLER/WATER ENTRANCE (WET) NO SCALE


NOTE 1. SEE STANDARD FREDERICK COUNTY DRAWINGS NOTE 2. PROVIDE LEAD FREE PIPING, FITTINGS, VALVES ETC. INTENDED TO DISPENSE WATER FOR HUMAN CONSUMPTION.

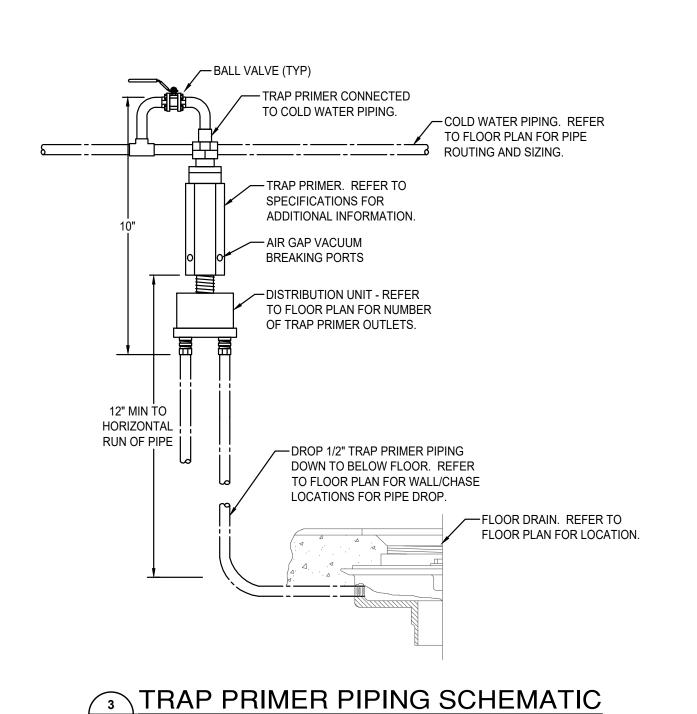


P701 NO SCALE

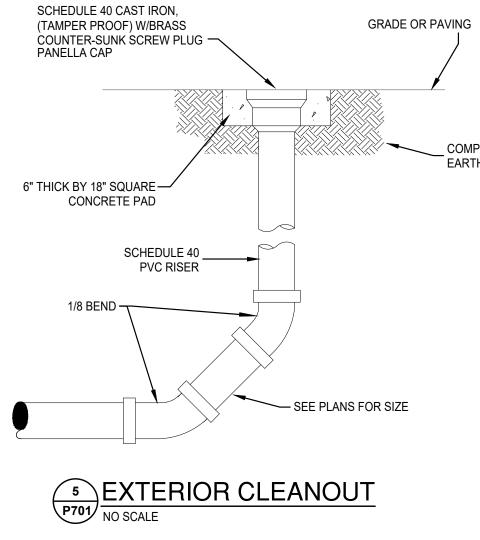

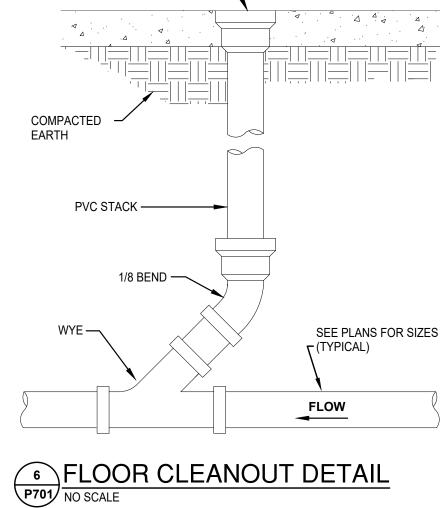

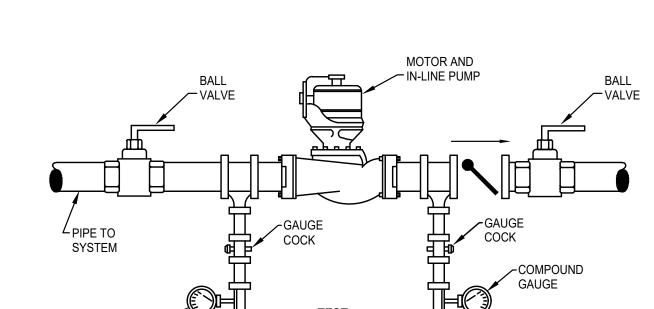

IN-LINE PUMP CONNECTIONS P701 NO SCALE

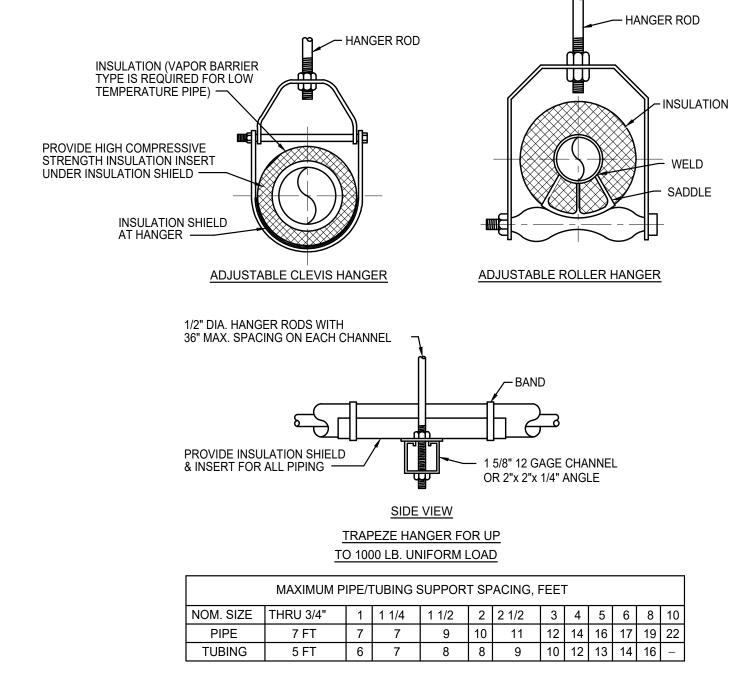

FOR TRAPEZE HANGER TAKE SPACING OF SMALLEST SIZE ON TRAPEZE.

P701 PIPE HANGERS
NO SCALE

PROJECT INFORMATION

PROJECT TITLE

MYERSVILLE COMMUNITY **LIBRARY**

PROJECT ADDRESS **8 HARP PLACE** MYERSVILLE, MD 21773

PROJECT OWNER FREDERICK COUNTY, **MARYLAND** DEPARTMENT OF PUBLIC WORKS

PROJECT TEAM



NOELKER AND HULL ASSOCIATES, INC.

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SHEET INFORMATION

REV. #: DESCRIPTION:

PROJECT STATUS

JOB NUMBER: 16-1043 10 APRIL 2018 ISSUE DATE: AS INDICATED SHEET TITLE: PLUMBING DETAILS AND **SCHEDULES** SHEET NUMBER:

RECEPTACLES SINGLE 125V-20A RECEPTACLE DUPLEX 125V-20A RECEPTACLE DUPLEX RECEPTACLE GROUND FAULT INTERRUPTER TYPE DUPLEX RECEPTACLE GROUND FAULT INTERRUPTER TYPE. INSTALL IN WEATHERPROOF HOUSING DOUBLE DUPLEX RECEPTACLE RECEPTACLE ELECTRIC WATER COOLER TAMPERPROOF RECEPTACLE SPECIAL RECEPTACLE - COORDINATE EXACT TYPE WITH EQUIPMENT AT SITE FLUSH FLOOR BOX WITH DUPLEX RECEPTACLE & TELE/DATA OUTLET AND INDICATES MOUNT DEVICE ABOVE COUNTER TOP TIME CLOCK JUNCTION BOX JUNCTION BOX - CEILING HARDWIRE CONNECTION NON-FUSIBLE SAFETY SWITCH FUSIBLE SAFETY SWITCH MOTOR MOTOR STARTING SWITCH HAND DRYER PAPER TOWEL DISPENSER

TELECOMMUNICATIONS

DATA OUTLET(S) @ 18" AFF. U.N.O. WITH 3/4" RACEWAY TERMINATED 18" ABOVE NEAREST ACCESSIBLE CEILING. CONDUITS IN SLAB SHALL BE 2".

COMBINATION TELEPHONE/DATA OUTLET(S) @ 18" AFF. U.N.O. WITH 1" RACEWAY TERMINATED 18" ABOVE NEAREST ACCESSIBLE CEILING.

 ∇ WAP DATA OUTLET FOR WIRELESS ACCESS POINT - N.I.C.

CEILING DATA OUTLET FOR COUNTER - N.I.C.

LIGHTING FIXTURE - SEE FIXTURE SCHEDULE FOR MORE INFORMATION -0 | NORMAL/EMERGENCY LIGHTING FIXTURE -SEE FIXTURE SCHEDULE FOR MORE INFORMATION \vdash **⊢** O DOWNLIGHT LIGHTING FIXTURE ON NORMAL/EMERGENCY → WALL WASHER WALL MOUNTED LIGHT FIXTURE CHANDELIER EXIT SIGN - DIRECTIONAL ARROWS AS INDICATED ON DRAWINGS SINGLE POLE SWITCH \$LV LOW VOLTAGE SWITCH

\$ LOW VOLTAGE DIMMER SWITCH

LIGHTING CONTACTOR

BOLLARD

FIXTURE

OVERRIDE SWITCH

CEILING MOUNTED OCCUPANCY SENSOR

WALL MOUNTED OCCUPANCY SENSOR

POLE MOUNTED SITE LIGHTING FIXTURE-

SMALL CASE LETTERS REPRESENTS LAMP(S) / SWITCHES. WHEN USED WITH AN OCCUPANCY

SENSOR THIS INDICATES SENSOR WITH MANUAL

NUMBER OF FIXTURES PER POLE AS

POLE TOP MOUNTED SITE LIGHTING

INDICATED ON DRAWINGS

CEILING MOUNTED PHOTOSENSOR

LIGHTING

SECURITY & DOOR CONTROL SECURITY CAMERA, BY OWNER CONTRACTOR TO PROVIDE BACKBOX AND CONDUIT TO 18" ABOVE FINISHED CEILING. CARD READER, BY OWNER CONTRACTOR TO PROVIDE BACKBOX AND CONDUIT TO 18" ABOVE FINISHED CEILING. ELECTRIC STRIKE **AUDIO/VISUAL** VOLUME CONTROL SOUND SYSTEM SPEAKER CEILING MOUNTED **MISCELLANEOUS** BRANCH CIRCUIT WIRING CONCEALED IN WALLS OR ABOVE CEILING BRANCH CIRCUIT WIRING - #10 AWG HOME RUN BACK TO PANEL CONDUIT TURNED DOWN CONDUIT TURNED UP —LV — LOW VOLTAGE WIRING AND CONDUIT ➤ INDICATES CONTINUATION OF LINE

FIRE ALARM CONTROL PANEL FIRE ALARM ANNUNCIATOR PANEL ZONE ADDRESSABLE MODULE CONTROL MODULE RELAY FIRE ALARM PULL STATION FIRE ALARM STROBE - WALL MOUNTED FIRE ALARM AUDIBLE/STROBE - WM FIRE ALARM HORN/STROBE - WM FIRE ALARM SPEAKER/STROBE - WM FIRE ALARM AUDIBLE - CEILING MOUNTED FIRE ALARM AUDIBLE AND VISIBLE - CM FIRE ALARM SPEAKER AND VISIBLE - CM FIRE ALARM STROBE - CM DUCT DETECTOR - PROVIDED BY EC, INSTALLED BY MC AND CONNECTED BY FLOW SWITCH - PROVIDED BY OTHERS, AND CONNECTED BY EC TAMPER SWITCH - PROVIDED BY OTHERS, AND CONNECTED BY EC REMOTE INDICATOR / TEST STATION

HVAC SHUTDOWN PUSH BUTTON

FIRE ALARM - N.I.C.

ABOVE FINISHED FLOOR CEILING MOUNTED CLOSED CIRCUIT TELEVISION DOUBLE DEVICE DOOR OPEN **EMERGENCY** ELECTRICAL CONTRACTOR ELECTRIC WATER COOLER FIRE ALARM FLUSH FLOOR MOUNTED GROUND FAULT INTERRUPTER GENERAL CONTRACTOR LOW VOLTAGE MOTOR MECHANICAL CONTRACTOR NON-FUSED SAFETY SWITCH PLUMBING CONTRACTOR REFRIGERATOR s SOUND SYSTEM SEC SECURITY SYSTEM TP TAMPER PROOF UE UNDERGROUND ELECTRIC UNDERGROUND TELEPHONE WALL MOUNTED WP WEATHERPROOF

GENERAL PROJECT NOTES:

G1. UNLESS OTHERWISE NOTED, PROVIDE ALL EQUIPMENT SHOWN ON THE PLANS. THE ELECTRICAL CONTRACTOR SHALL COORDINATE ALL SYMBOLS SHOWN ON THE PLANS WITH THE SYMBOL LIST. IT SHALL BE THE RESPONSIBILITY OF THE CONTRACTOR TO VERIFY THE INTENT OF ANY SYMBOL THAT IS SHOWN ON THE PLANS AND NOT INDICATED ON THE SYMBOL LIST WITH

G2. COORDINATE THE FINAL LOCATIONS OF ALL LIGHT FIXTURES WITH THE ARCHITECT'S REFLECTED CEILING PLANS. REPORT ANY DISCREPANCIES TO THE ARCHITECT PRIOR

G3. THE CONTRACTOR SHALL VERIFY THE LOCATION OF ALL UNDERGROUND UTILITIES WITHIN THE CONSTRUCTION AREA THREE (3) WORKING DAYS NOTICE BEFORE COMMENCE DIGGING. NOTIFY THE LOCAL OR STATE AUTHORITY HAVING JURISDICTION AND WAIT THE REQUIRED TIME BEFORE COMMENCING TO DIG.

TRADE CONTRACTORS TO AVOID CONFLICTS.

DENOTATIONS & ABBREVIATIONS

ELECTRICAL ENGINEER.

TO INSTALLATION.

G4. IT SHALL BE THE RESPONSIBILITY OF THE CONTRACTOR TO NOTIFY THE PROFESSIONAL IF A SYMBOL IS USED ON THE PROJECT BUT DOES NOT SHOW IN THE SYMBOL LIST PRIOR TO BID.

G5. THE CONTRACTOR SHALL COORDINATE CONDUIT RUNS, CABLE TRAY, LIGHTING FIXTURES AND OTHER EQUIPMENT LOCATIONS WITH THE OTHER

PROJECT TEAM

NOELKER AND HULL ASSOCIATES, INC.

PROJECT INFORMATION

PROJECT TITLE

MYERSVILLE

COMMUNITY

LIBRARY

PROJECT ADDRESS **8 HARP PLACE** MYERSVILLE, MD 21773

PROJECT OWNER

FREDERICK COUNTY,

MARYLAND

DEPARTMENT OF PUBLIC

WORKS

ARCHITECTS

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STRUCTURAL ENGINEER ABEL CONSULTING ENGINEERS 9055 COMPRINT COURT, SUITE 370 | GAITHERSBURG, MD | 20878

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HARRIS, SMARIGA & ASSOCIATES, INC.

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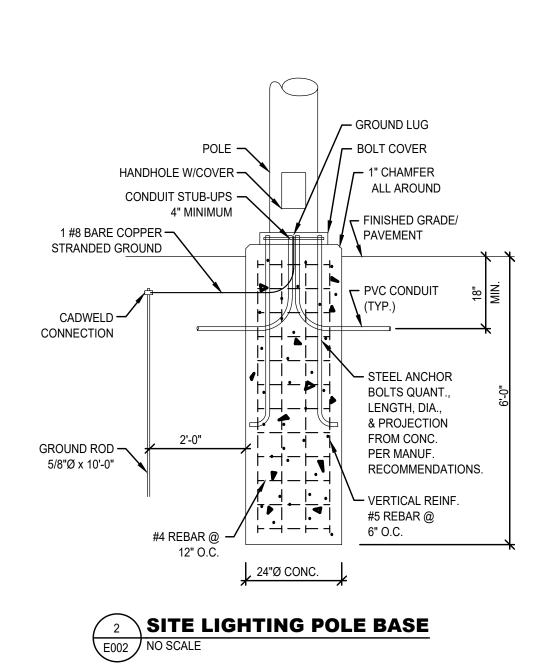
SHEET INFORMATION


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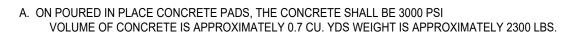
PROJECT STATUS

16-1043 JOB NUMBER: 10 APRIL 2018 **AS INDICATED** SYMBOLS, ABBREVIATIONS, AND **NOTES**

SHEET NUMBER:






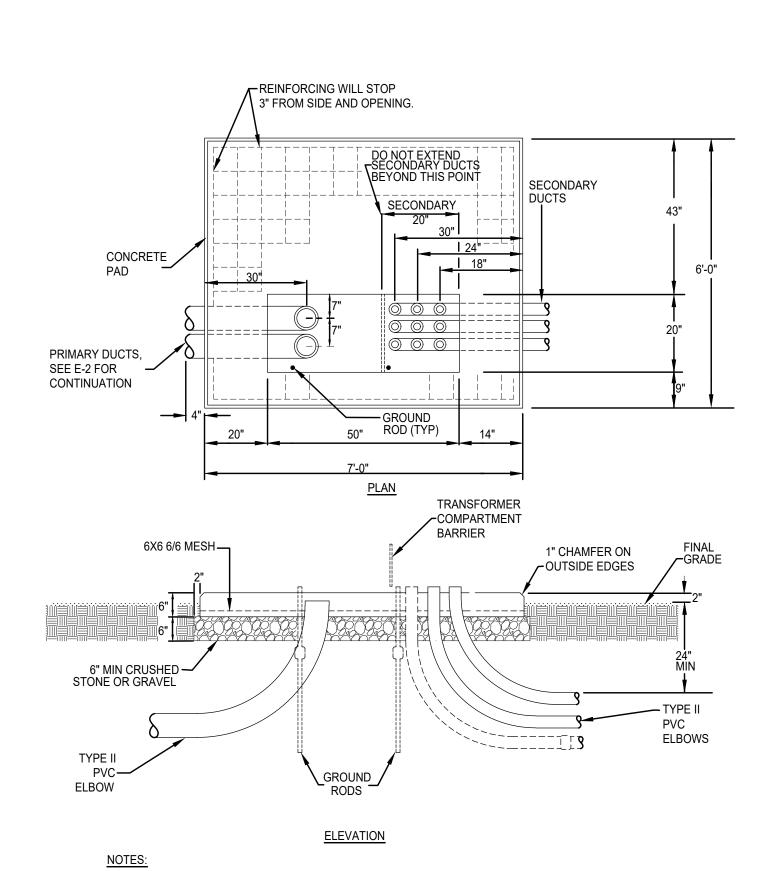

- B. SECONDARY DUCTS SHOULD NOT EXTEND MORE THAN 2" ABOVE THE TOP OF THE FOUNDATION TO ALLOW FOR TERMINATING THE CABLES.
- C. EXTEND GROUND RODS 2" ABOVE THE TOP OF THE FOUNDATION TO ACCOMODATE A GROUND JUMPER.

CONCRETE PAD FOUNDATION
PAD MOUNTED TRANSFORMER

NO SCALE

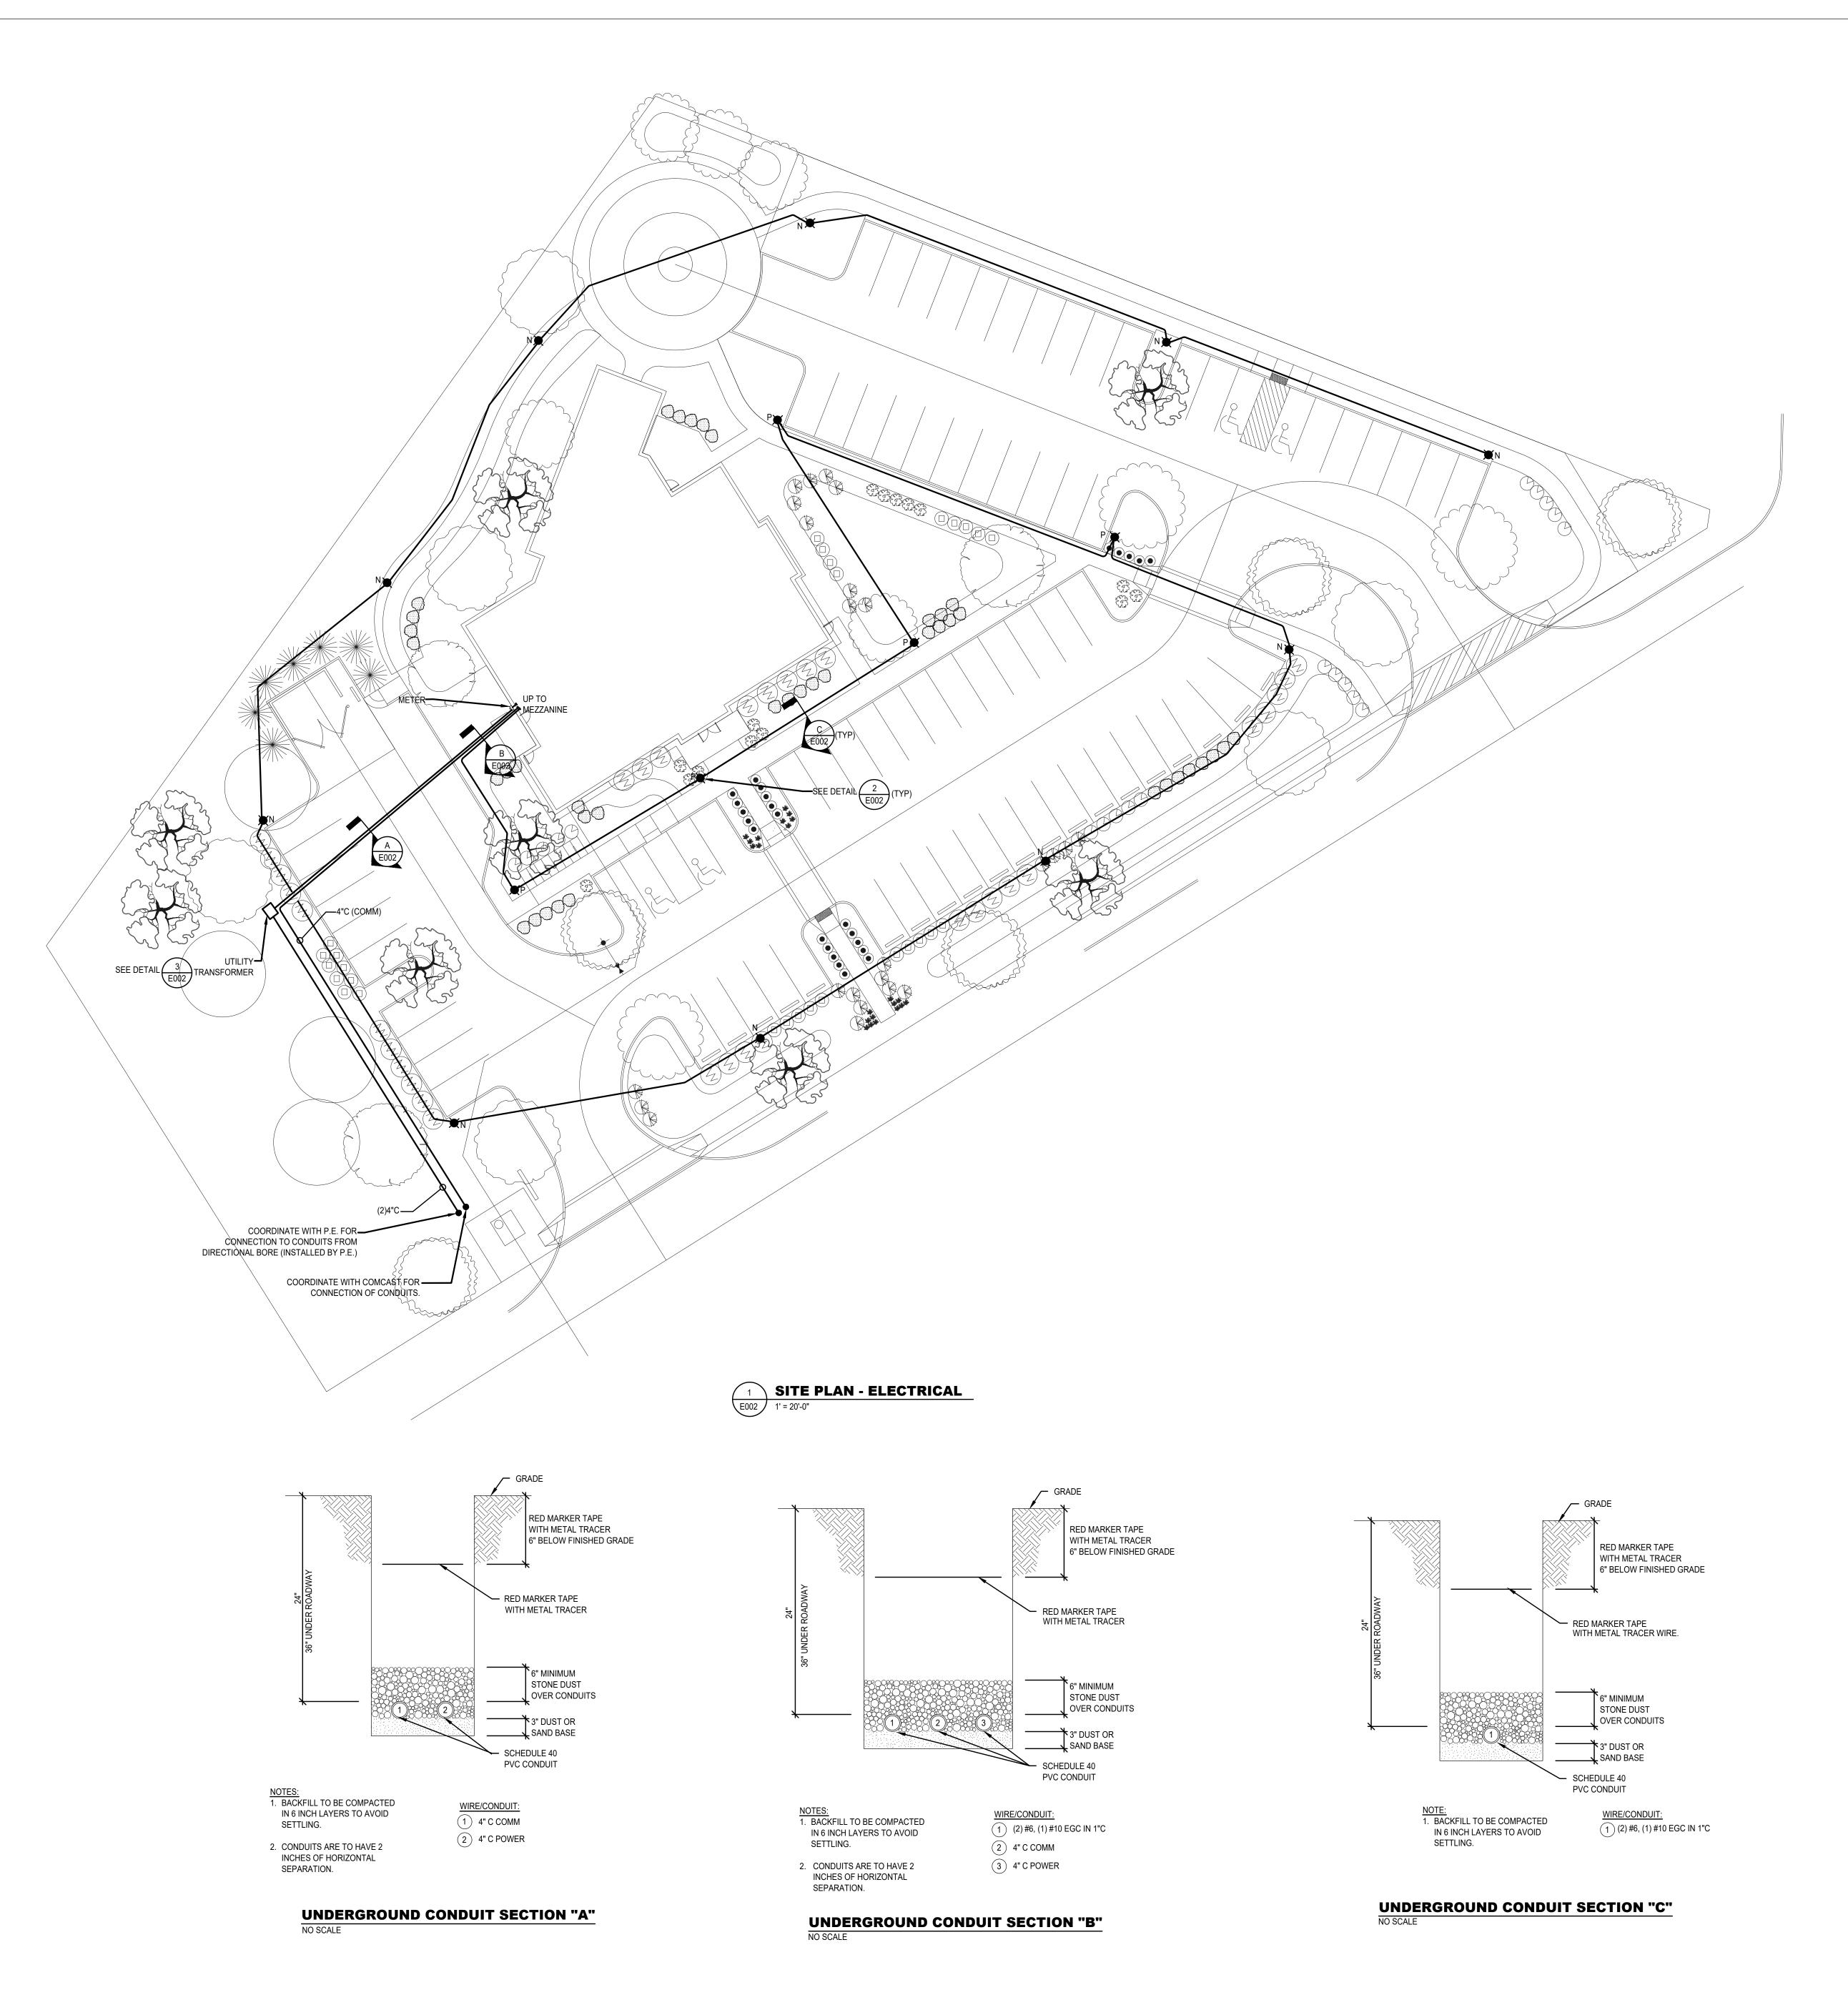

PROJECT INFORMATION

PROJECT TITLE


MYERSVILLE COMMUNITY LIBRARY

PROJECT ADDRESS

8 HARP PLACE
MYERSVILLE, MD 21773

FREDERICK COUNTY,
MARYLAND
DEPARTMENT OF PUBLIC
WORKS

PROJECT TEAM

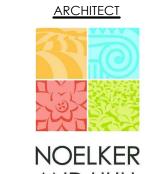

NOELKER AND HULL ASSOCIATES, INC.

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Expiration Date: 06/03/2020

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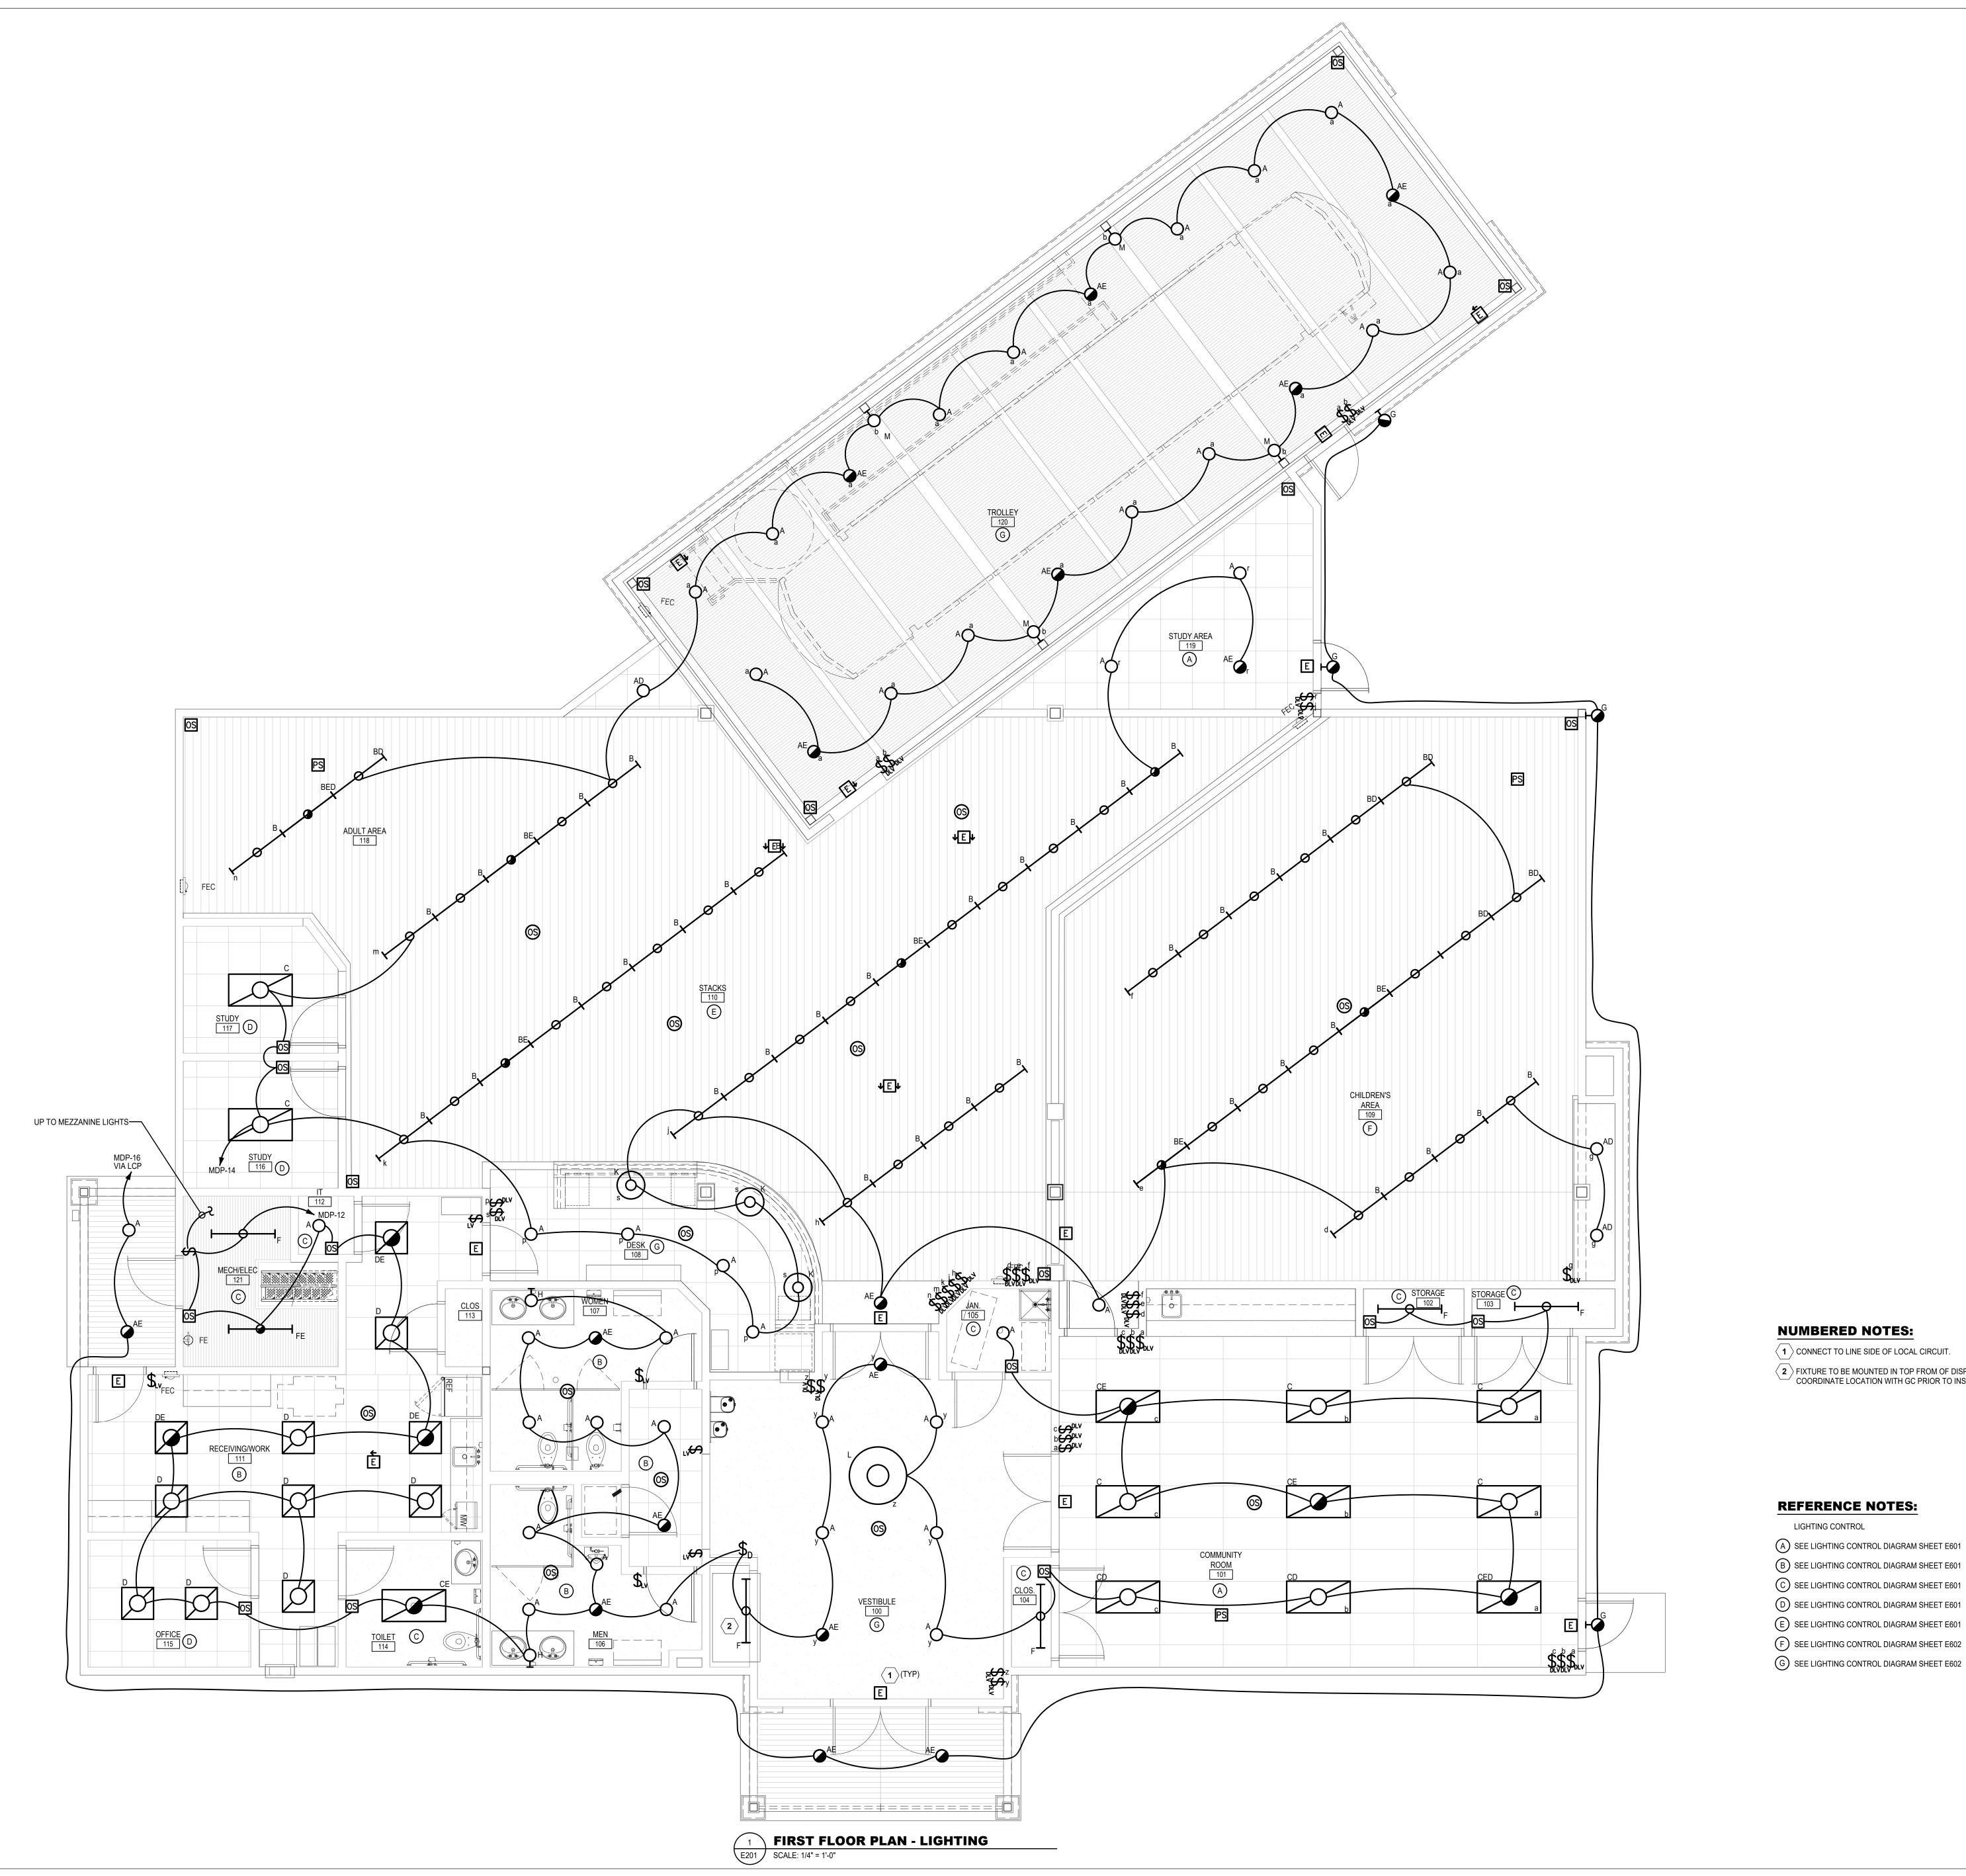
PROJECT STATUS

JOB NUMBER: 16-1043
ISSUE DATE: 10 APRIL 2018
SCALE:
SHEET TITLE: AS INDICATED

SITE PLAN - ELECTRICAL

SHEET NUMBER:

E002



PROJECT TITLE

MYERSVILLE COMMUNITY LIBRARY

PROJECT ADDRESS 8 HARP PLACE MYERSVILLE, MD 21773

PROJECT OWNER FREDERICK COUNTY, **MARYLAND** DEPARTMENT OF PUBLIC **WORKS**

PROJECT TEAM



NOELKER AND HULL ASSOCIATES, INC.

ARCHITECTS

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STRUCTURAL ENGINEER ABEL CONSULTING ENGINEERS

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License No: 45511,

Expiration Date: 06/03/2020

SHEET INFORMATION

NUMBERED NOTES:

 \langle **1** \rangle CONNECT TO LINE SIDE OF LOCAL CIRCUIT.

FIXTURE TO BE MOUNTED IN TOP FROM OF DISPLAY CABINET. COORDINATE LOCATION WITH GC PRIOR TO INSTALLING.

REFERENCE NOTES:

LIGHTING CONTROL

A SEE LIGHTING CONTROL DIAGRAM SHEET E601

© SEE LIGHTING CONTROL DIAGRAM SHEET E601

D SEE LIGHTING CONTROL DIAGRAM SHEET E601

E SEE LIGHTING CONTROL DIAGRAM SHEET E601

F SEE LIGHTING CONTROL DIAGRAM SHEET E602

G SEE LIGHTING CONTROL DIAGRAM SHEET E602


REV. #: DESCRIPTION:

PROJECT STATUS

JOB NUMBER: 16-1043 ISSUE DATE: 10 APRIL 2018 SCALE: AS INDICATED SHEET TITLE:

FIRST FLOOR PLAN-LIGHTING

SHEET NUMBER:

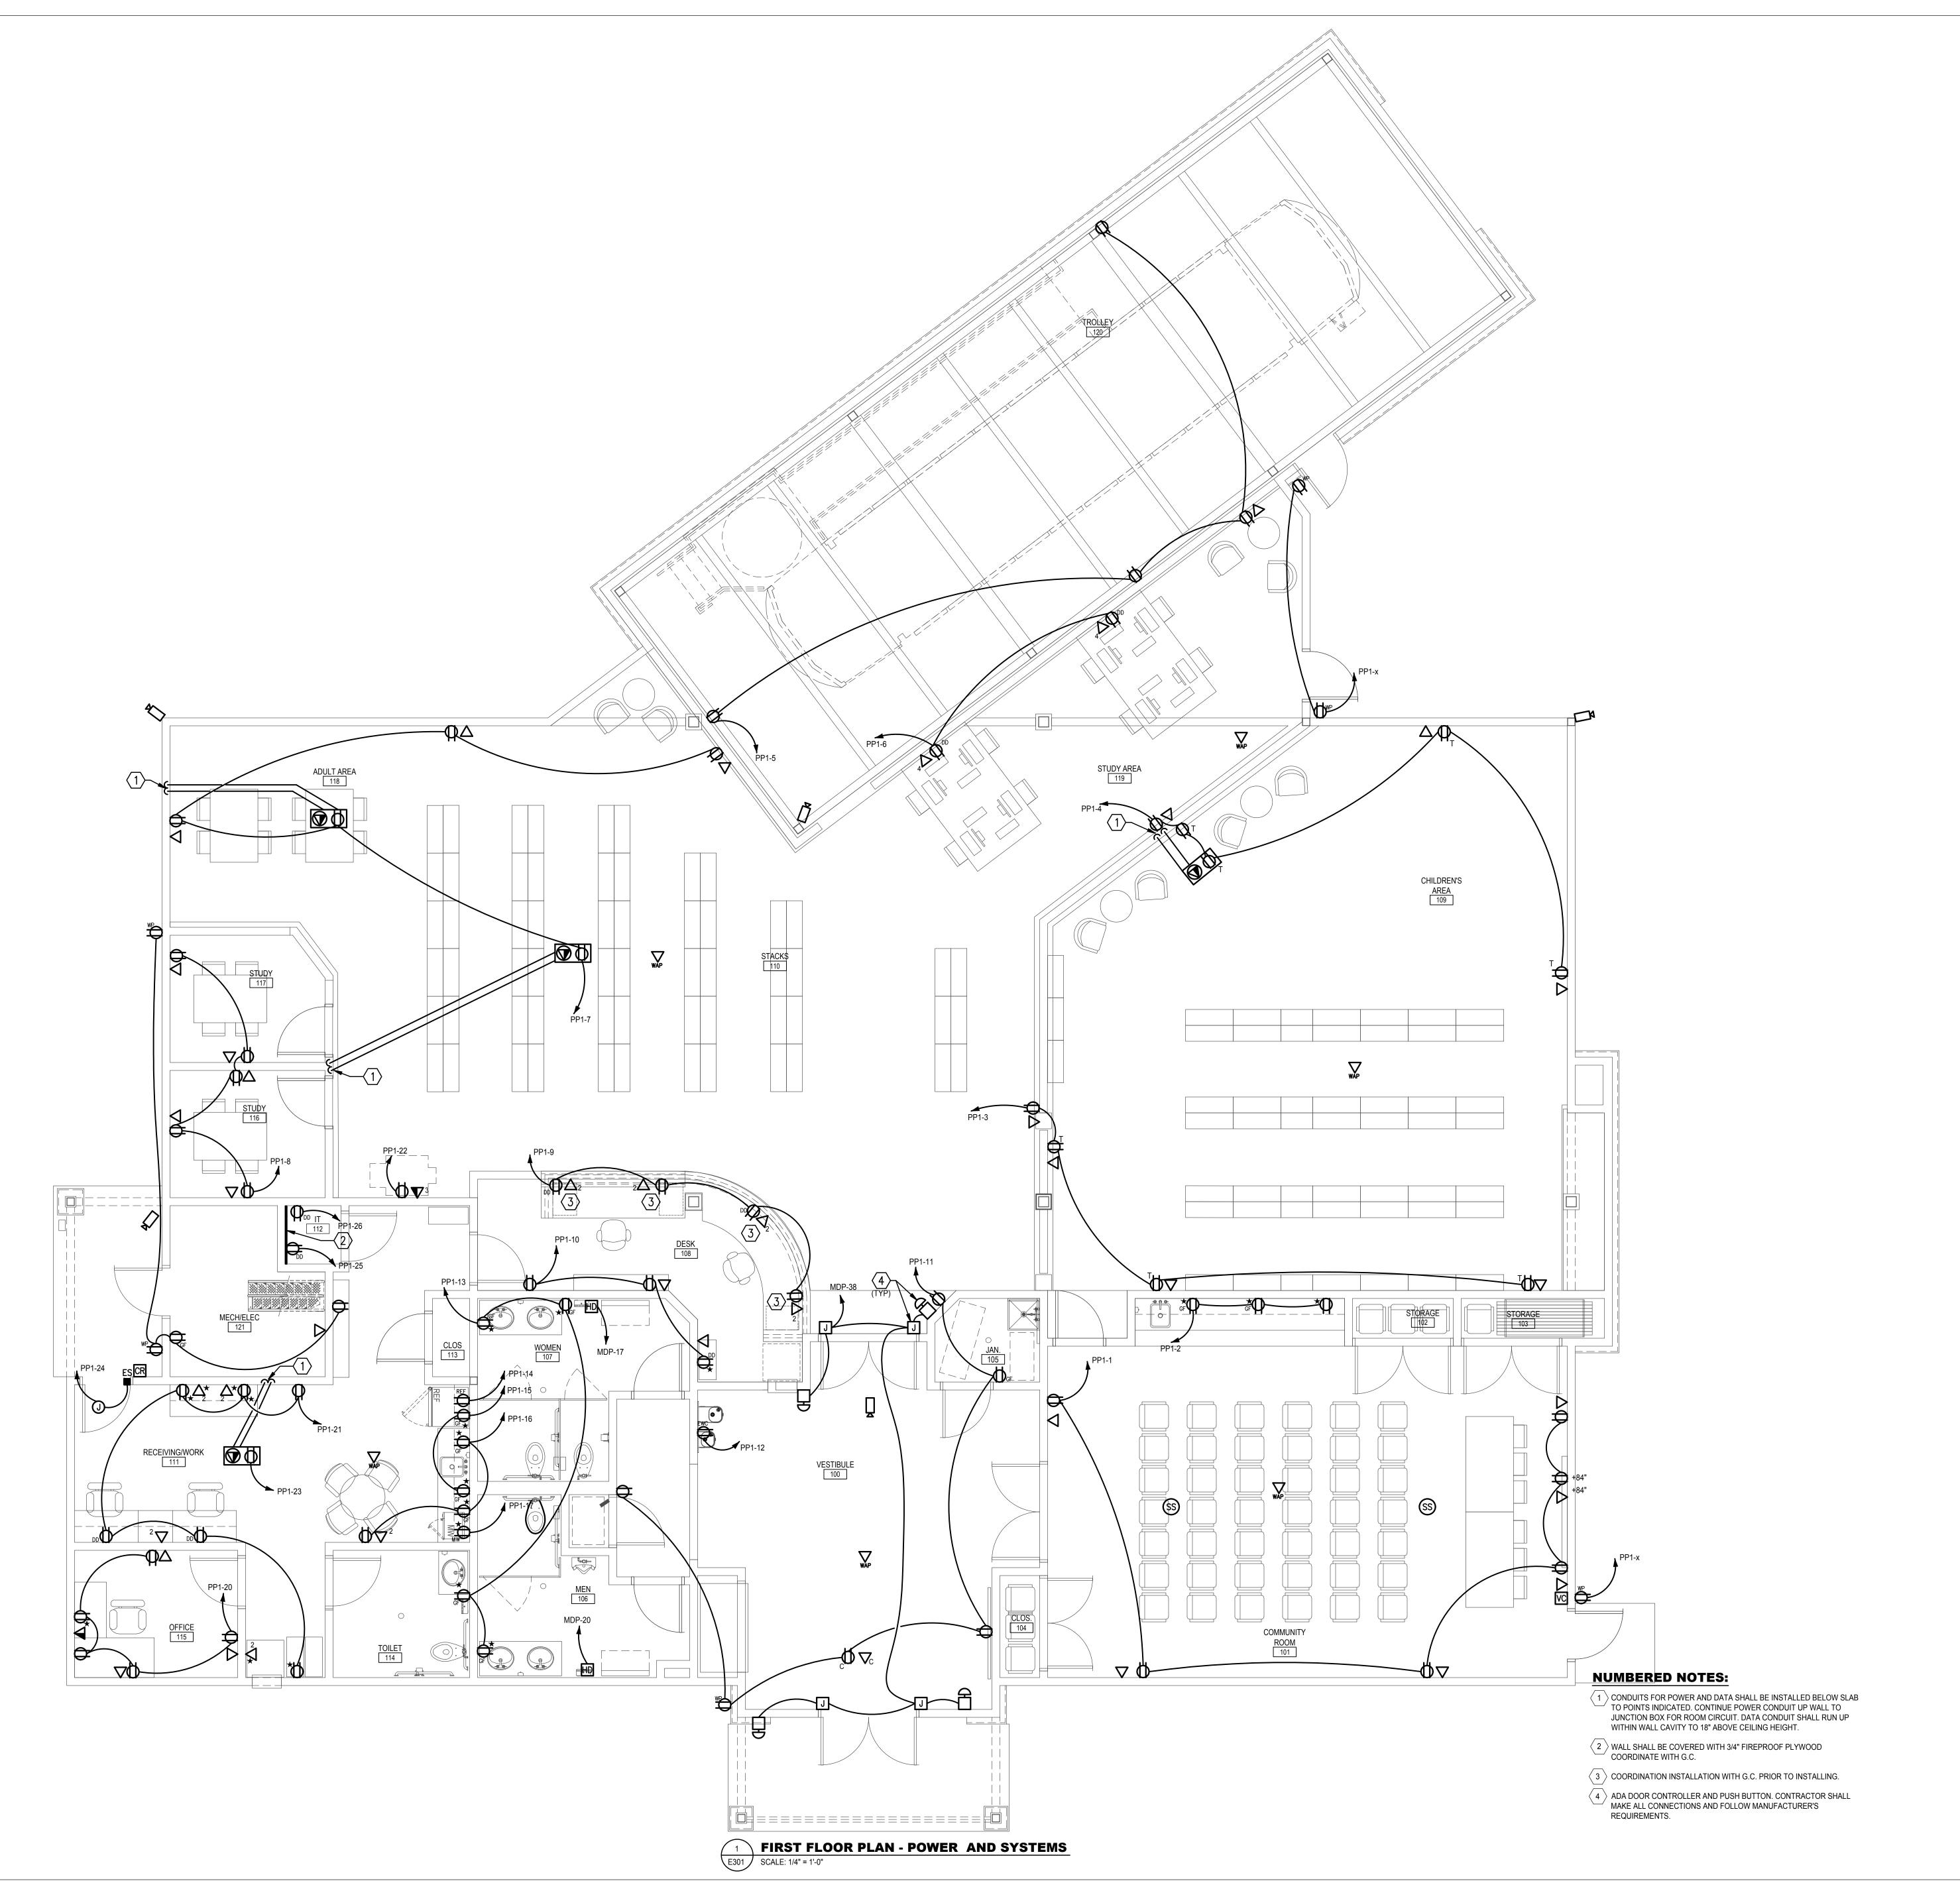

PROJECT TITLE

MYERSVILLE COMMUNITY LIBRARY

PROJECT ADDRESS

8 HARP PLACE
MYERSVILLE, MD 21773

FREDERICK COUNTY,
MARYLAND
DEPARTMENT OF PUBLIC
WORKS

PROJECT TEAM



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ARCHITECTS

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P: 301.662.4488 | F: 301.662.4906

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License No: 45511,
Expiration Date: 06/03/2020

SHEET INFORMATION

REV. #: DESCRIPTION: DATE:
- - -

PROJECT STATUS


JOB NUMBER: 16-1043
ISSUE DATE: 10 APRIL 2018
SCALE:
SHEET TITLE: AS INDICATED

FIRST FLOOR PLAN-POWER AND SYSTEMS

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SHEET NUMBER:

E301

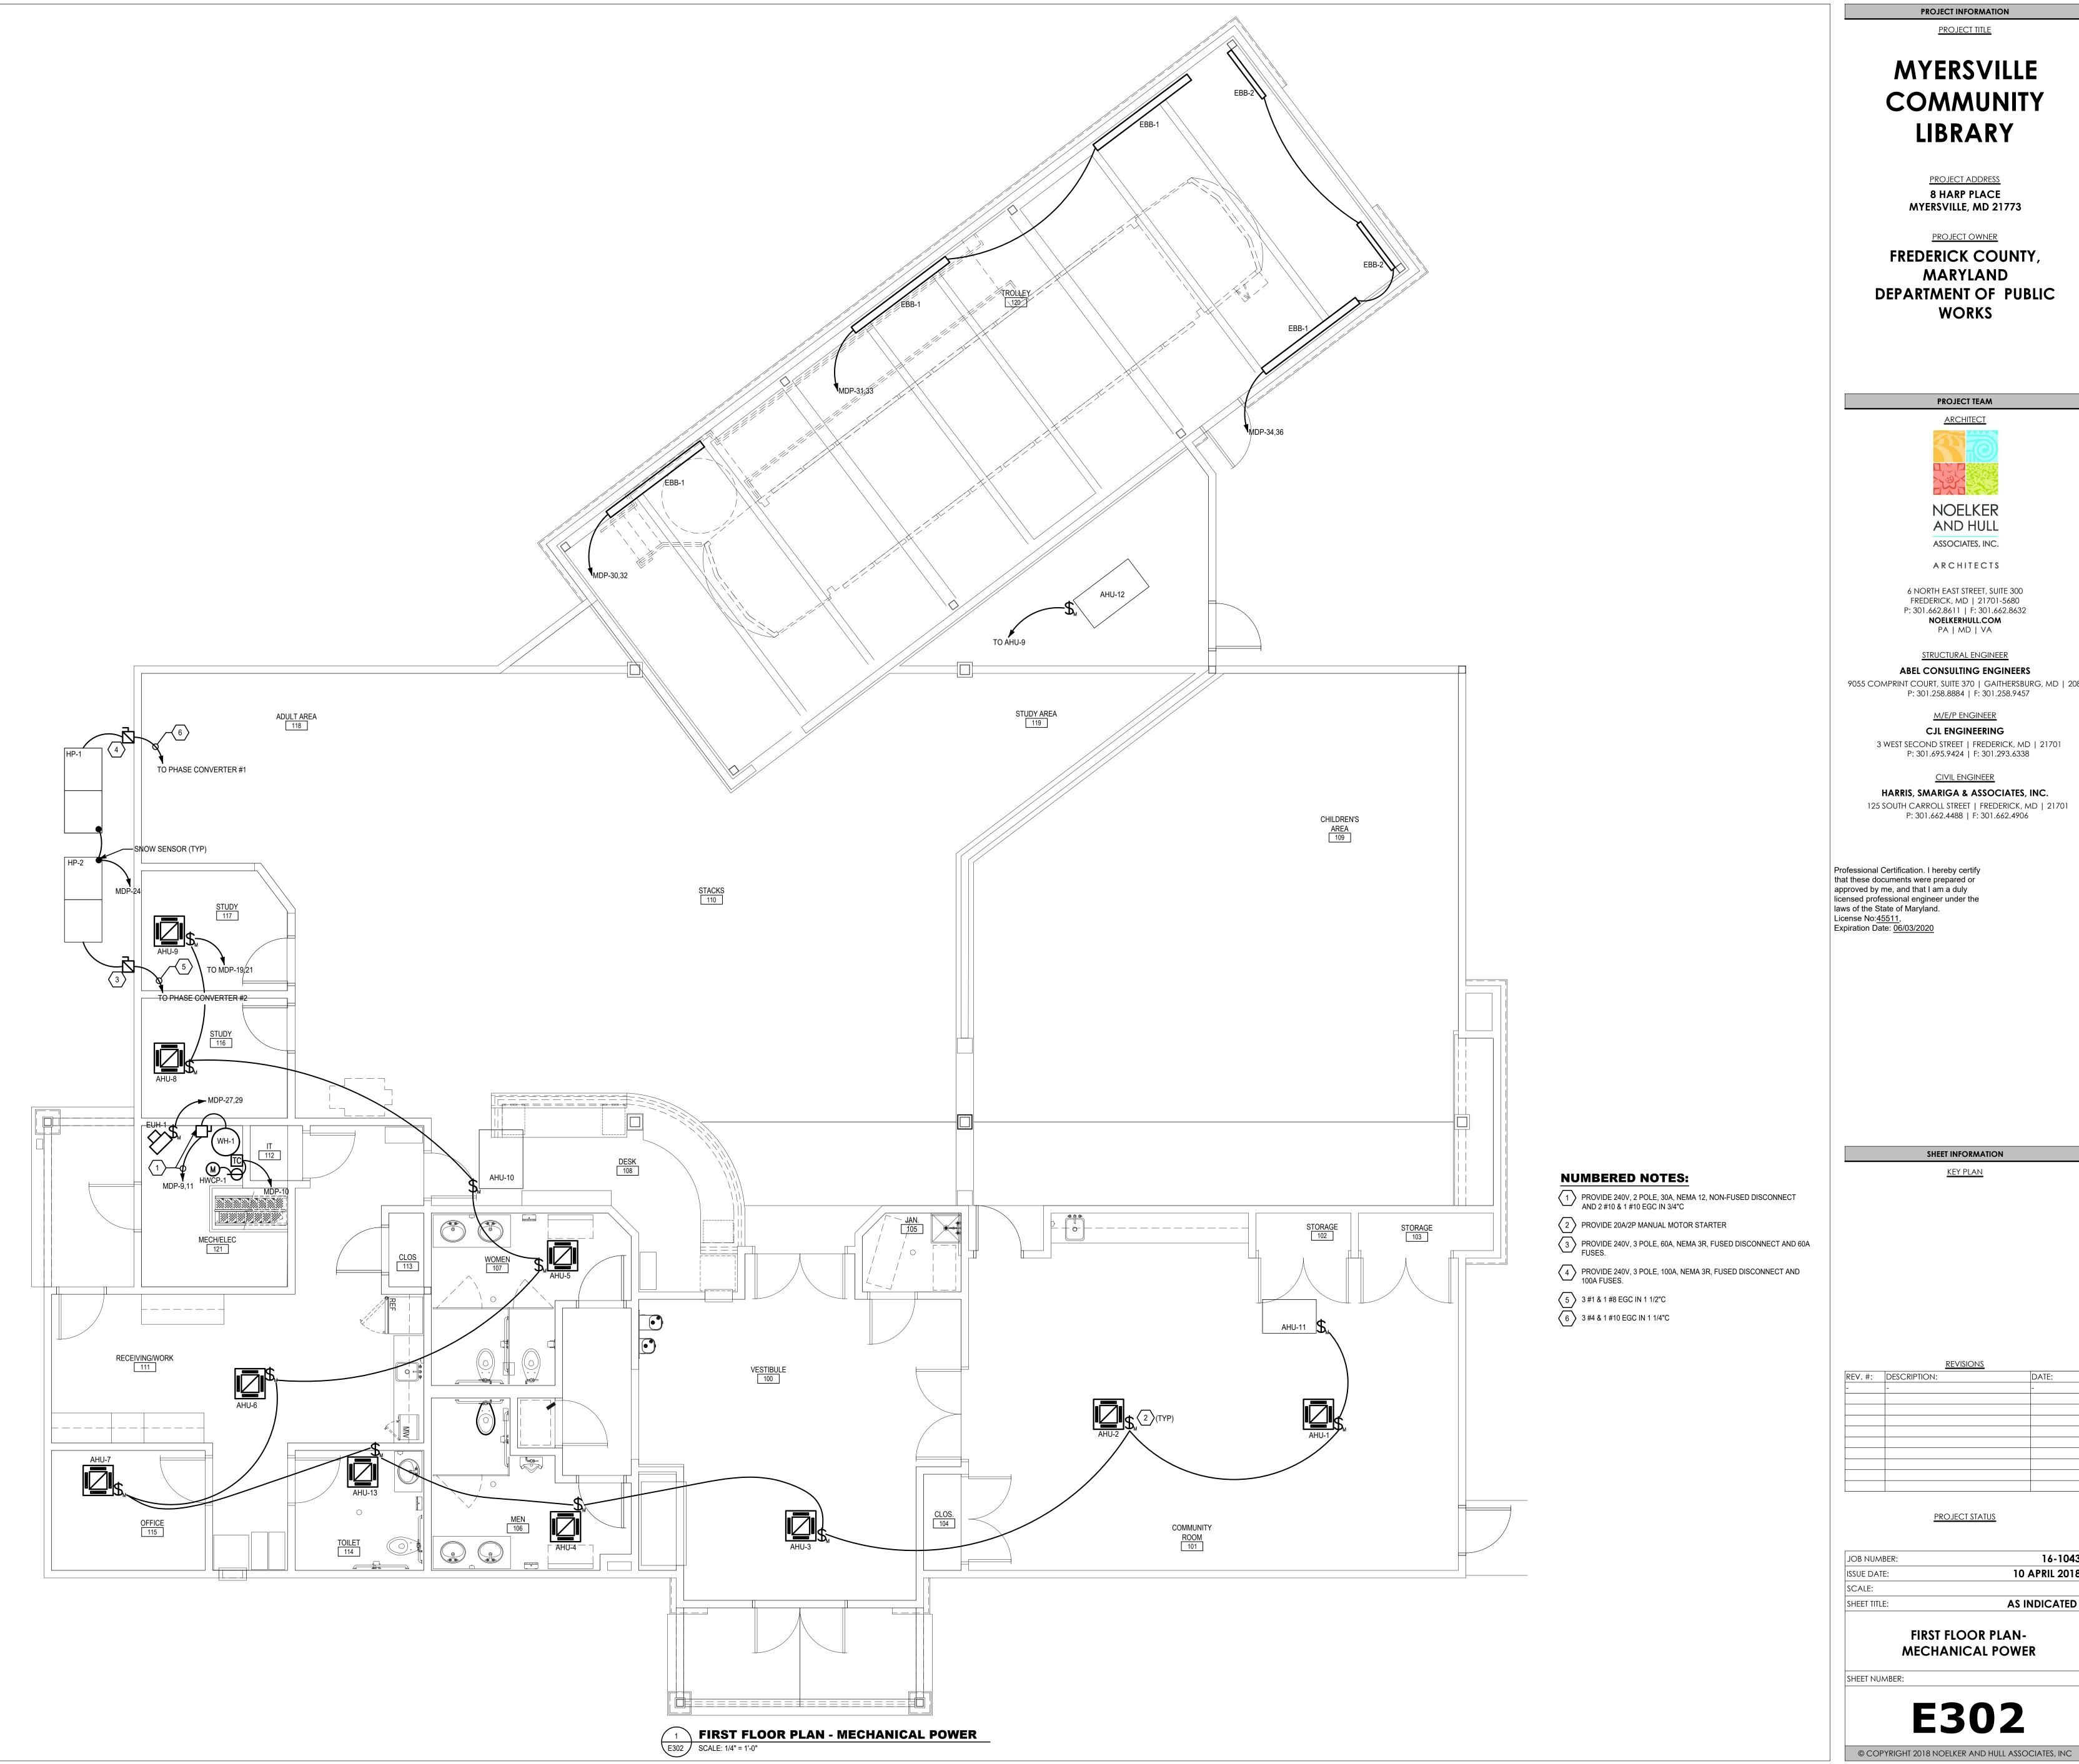

PROJECT TITLE

MYERSVILLE COMMUNITY LIBRARY

PROJECT ADDRESS 8 HARP PLACE MYERSVILLE, MD 21773

PROJECT OWNER FREDERICK COUNTY, **MARYLAND** DEPARTMENT OF PUBLIC WORKS

PROJECT TEAM



NOELKER AND HULL

ASSOCIATES, INC. ARCHITECTS

6 NORTH EAST STREET, SUITE 300 FREDERICK, MD | 21701-5680 P: 301.662.8611 | F: 301.662.8632 NOELKERHULL.COM PA | MD | VA

STRUCTURAL ENGINEER ABEL CONSULTING ENGINEERS

9055 COMPRINT COURT, SUITE 370 | GAITHERSBURG, MD | 20878 P: 301.258.8884 | F: 301.258.9457

3 WEST SECOND STREET | FREDERICK, MD | 21701 P: 301.695.9424 | F: 301.293.6338

HARRIS, SMARIGA & ASSOCIATES, INC. 125 SOUTH CARROLL STREET | FREDERICK, MD | 21701 P: 301.662.4488 | F: 301.662.4906

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SHEET INFORMATION


REV. #: DESCRIPTION:

PROJECT STATUS


16-1043 JOB NUMBER: 10 APRIL 2018 ISSUE DATE: AS INDICATED SHEET TITLE:

FIRST FLOOR PLAN-**MECHANICAL POWER**

E302

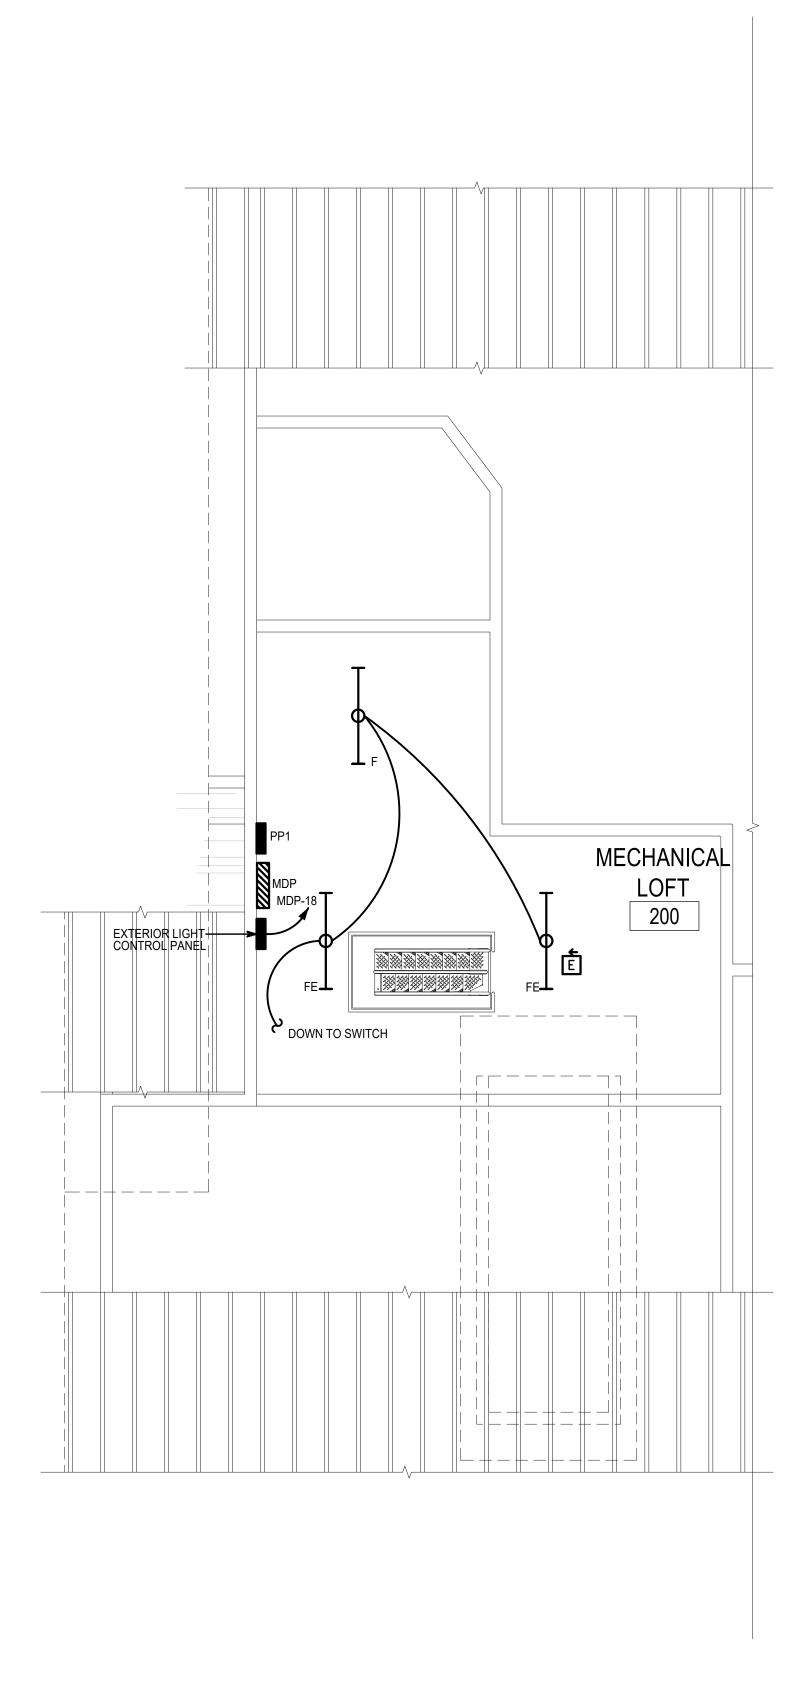

1 PART PLAN LOFT - LIGHTING
E401 SCALE: 1/4" = 1'-0"

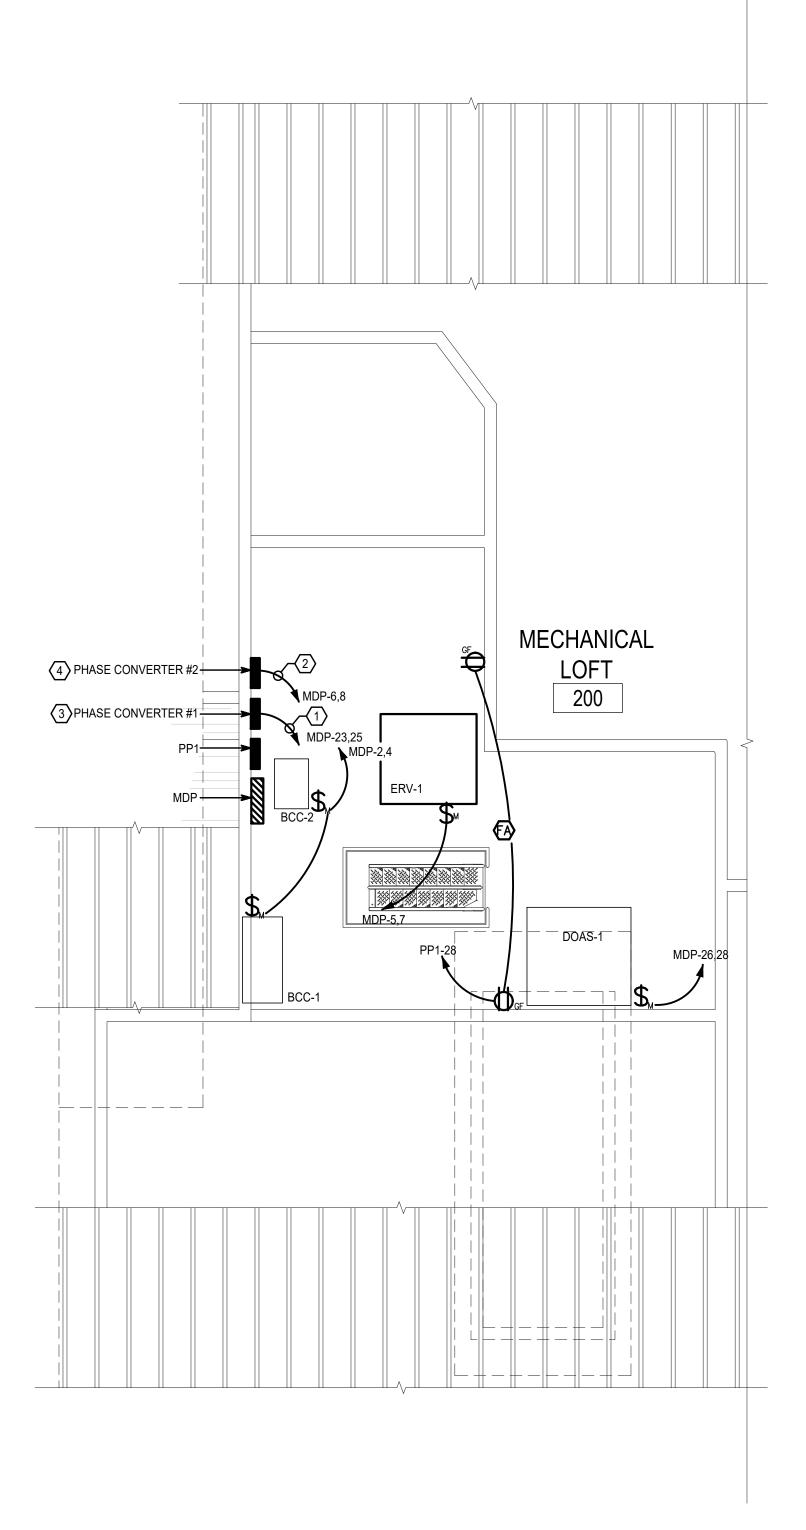

PART PLAN LOFT - POWER & SYSTEMS

SCALE: 1/4" = 1'-0"

NUMBERED NOTES:

- 1 2 # 1 & 1 #6 EGC IN 1 1/4"C
- 2 2 #3 & 1 #8 EGC IN 1"C
- PROVIDE PHASE PERFECT MODEL PT-3-110 PHASE CONVERTER OR APPROVED EQUAL.
- PROVIDE PHASE PERFECT MODEL PT-3-80 PHASE CONVERTER OR APPROVED EQUAL.

PROJECT INFORMATION

PROJECT TITLE

MYERSVILLE COMMUNITY LIBRARY

PROJECT ADDRESS

8 HARP PLACE
MYERSVILLE, MD 21773

FREDERICK COUNTY,
MARYLAND
DEPARTMENT OF PUBLIC
WORKS

PROJECT TEAM



NOELKER AND HULL ASSOCIATES, INC.

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PRINT COURT, SUITE 370 | GAITHERSBURG, MD | 2

9055 COMPRINT COURT, SUITE 370 | GAITHERSBURG, MD | 20878 P: 301.258.8884 | F: 301.258.9457

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Expiration Date: 06/03/2020

SHEET INFORMATION

KEY

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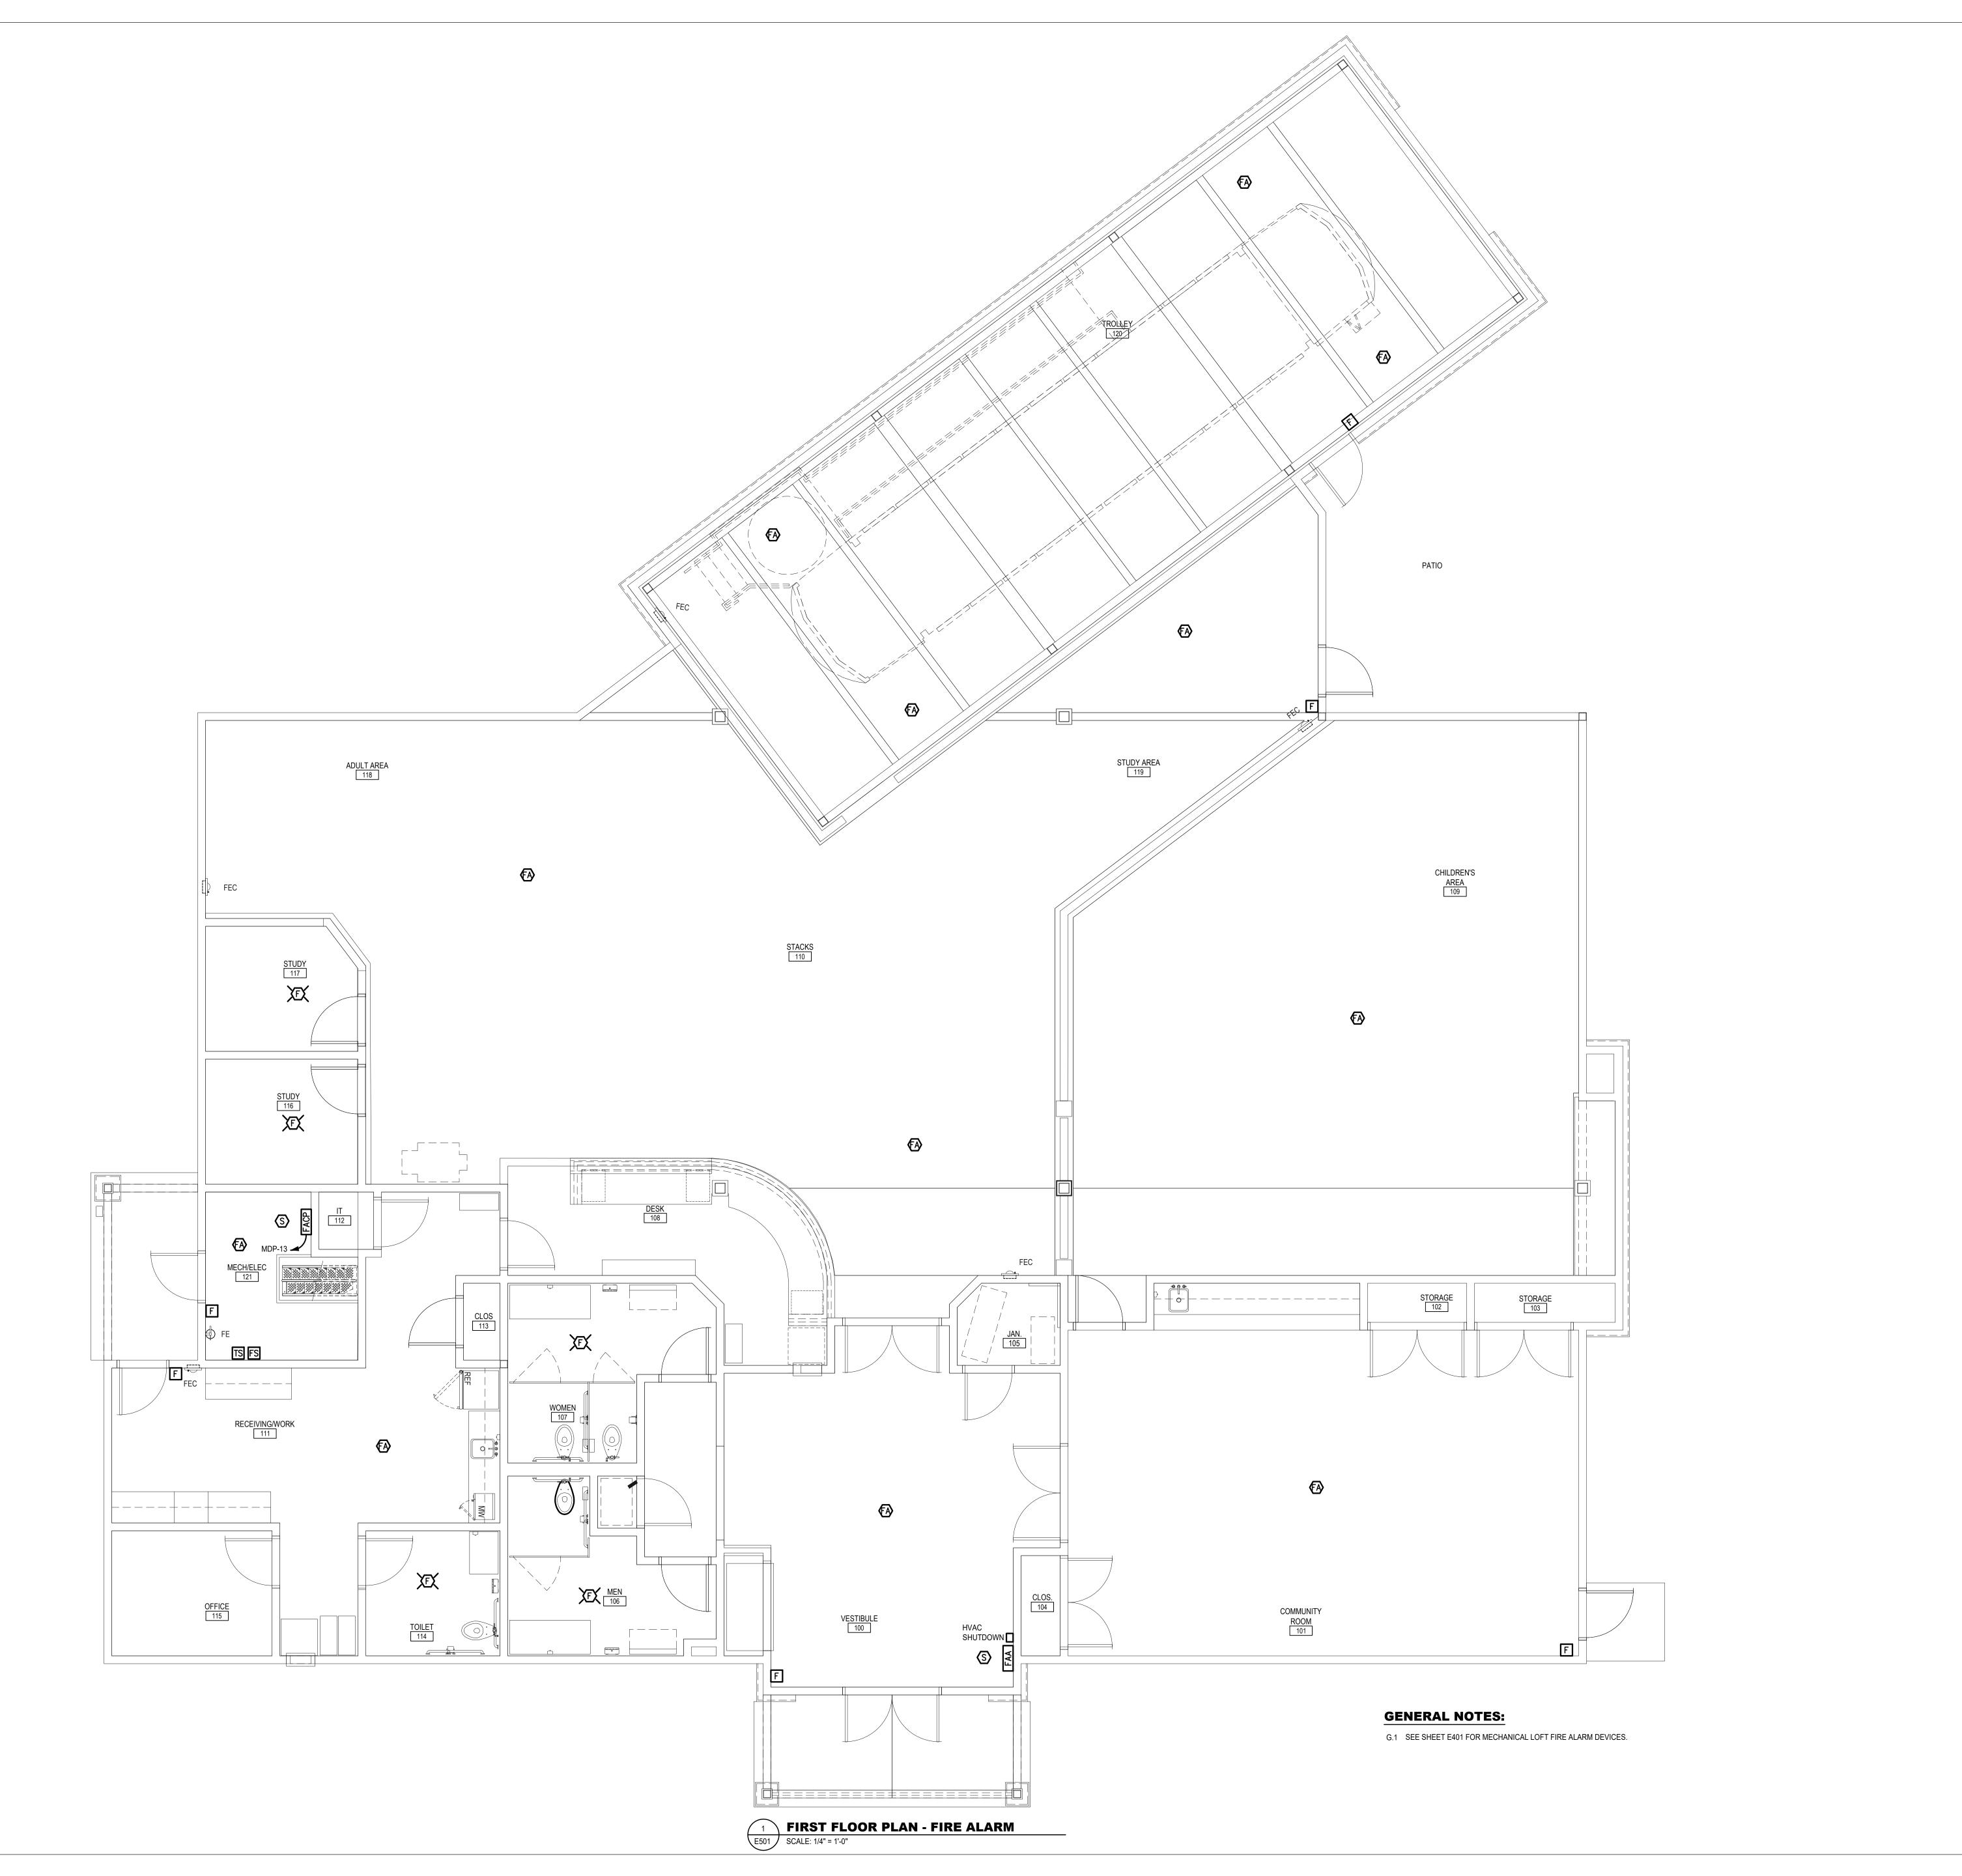
JOB NUMBER: 16-1043
ISSUE DATE: 10 APRIL 2018
SCALE:
SHEET TITLE: AS INDICATED

PART PLAN LOFT-ELECTRICAL

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LIEET NILLADED:

E401



PROJECT TITLE

MYERSVILLE COMMUNITY LIBRARY

PROJECT ADDRESS 8 HARP PLACE MYERSVILLE, MD 21773

PROJECT OWNER FREDERICK COUNTY, **MARYLAND** DEPARTMENT OF PUBLIC WORKS

PROJECT TEAM



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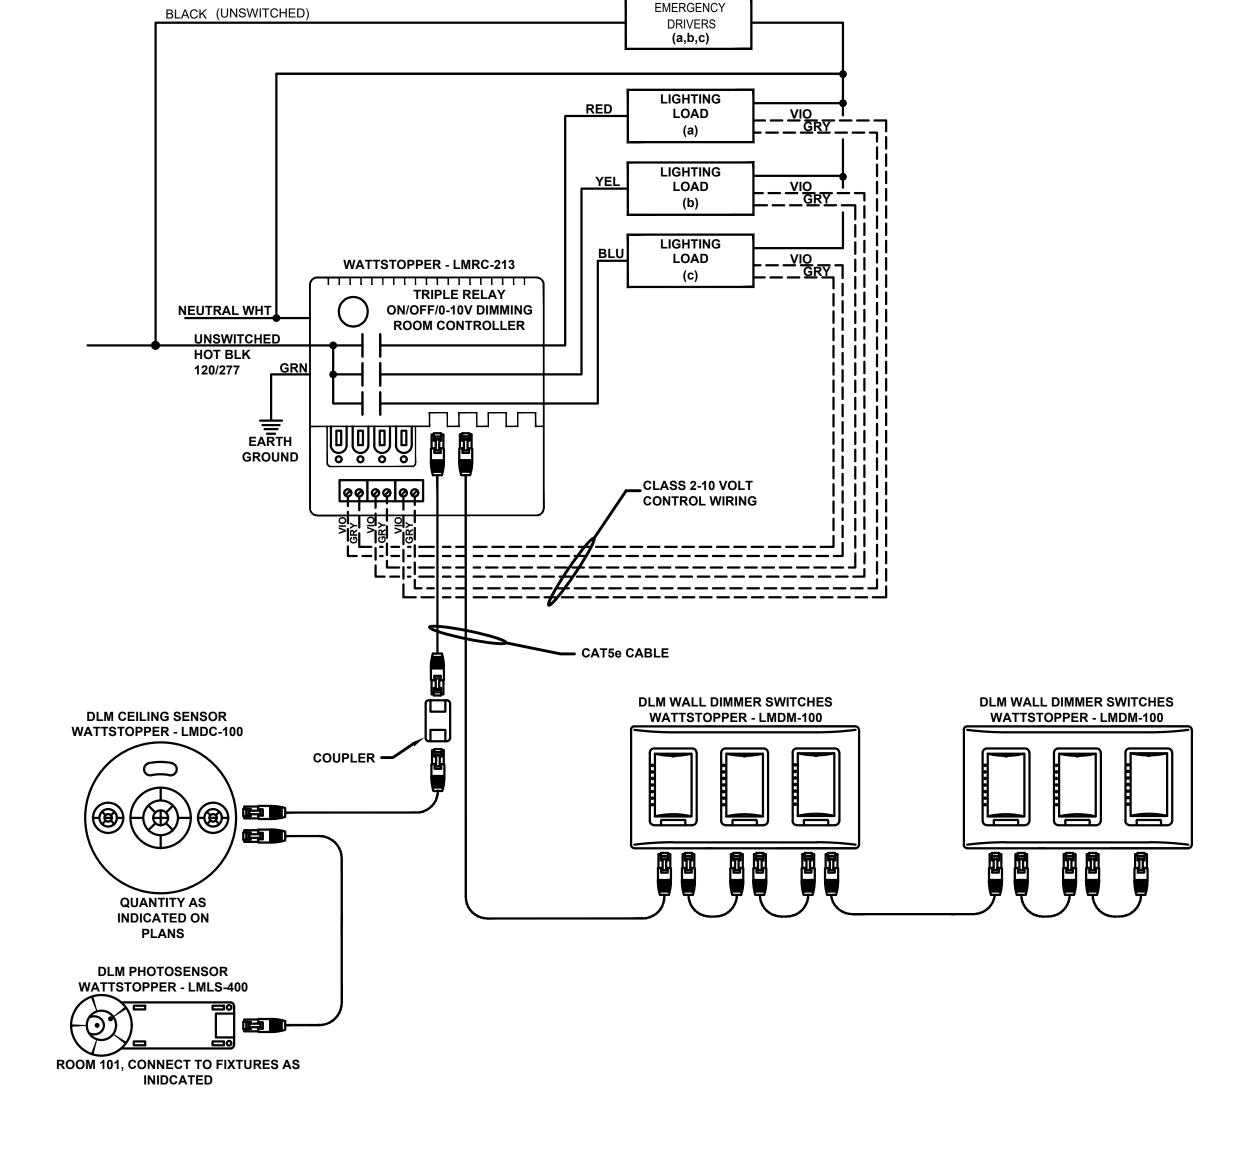
REV. #: DESCRIPTION:

PROJECT STATUS

16-1043 JOB NUMBER: ISSUE DATE: SCALE: 10 APRIL 2018 AS INDICATED FIRST FLOOR PLAN-FIRE ALARM


SHEET NUMBER:

LIGHTING FIXTURE SCHEDULE **NUMBER OF LAMPS** DRIVER TYPE OF REMARKS MARK **MANUFACTURE CATALOG NUMBER** AND WATTAGE VOLTAGE | MOUNTING AE = PROVIDE EM OPTION FOR EMERGENCY LIGHTING DLED-AFK6-30-DLEDT-R640-UNV-DM LED (30 W) **DECO LIGHTING** RECESSED AD = FIXTURES SHALL BE CONNECTED TO AD BE = PROVIDE IEM OPTION FOR EMERGENCY LIGHTING BE BD LED (45 W) **DECO LIGHTING** EVIAT-LED-##-45-40-UNV-Cxx-DM PENDANT BD = FIXTURES SHALL BE CONNECTED TO DAYLIGHT SENSOR CE = PROVIDE IEM OPTION FOR EMERGENCY LIGHTING CE RECESSED | CD = FIXTURES SHALL BE CONNECTED TO LED (30 W) **DECO LIGHTING** SFP-LED-24-30-40-UNV UNV DAYLIGHT SENSOR DE = PROVIDE IEM OPTION FOR EMERGENCY LIGHTING **DECO LIGHTING** SFP-LED-22-30-40-UNV LED (30W) UNV RECESSED FE = PROVIDE IEM OPTION FOR EMERGENCY LIGHTING SURFACE **DECO LIGHTING** DACH-LED-4-23-40-UNV-R-DM LED (23 W) LED (40W) **DECO LIGHTING** D458-LED-40-41-UNV-BL WALL STS LED-4-27LED/40-UNV LED (27W) **UTOPIA LIGHTING** WALL LED (14W) **HUBBARDTON FORGE** PENDANT 363010 LED (78W) **XAL LIGHTING** MIN2C573C7250H770400 PENDANT **HUBBARDTON FORGE** 302712-SKT-75 LED (6W) WALL POLE - RNTA-4-125-14-AKB-343-T4R-BZ VISIONAIRE LIGHTING PRE-2-L-T3-48-530-3K-UNV-PT-BZ POLE BASE - DCB-10-4RS-BZ LED (80W) POLE - RNTA-4-125-14-AKB-343-T4R-BZ VISIONAIRE LIGHTING PRE-2-L-T5-48-530-3K-UNV-PT-BZ POLE BASE - DCB-10-4RS-BZ CARPENTER EM LIGHT UNIVERSAL LED (3.8W) UNV



LIGHTING CONTROL WIRING DIAGRAM "A"

LIGHTING CONTROL WIRING DIAGRAM "E"

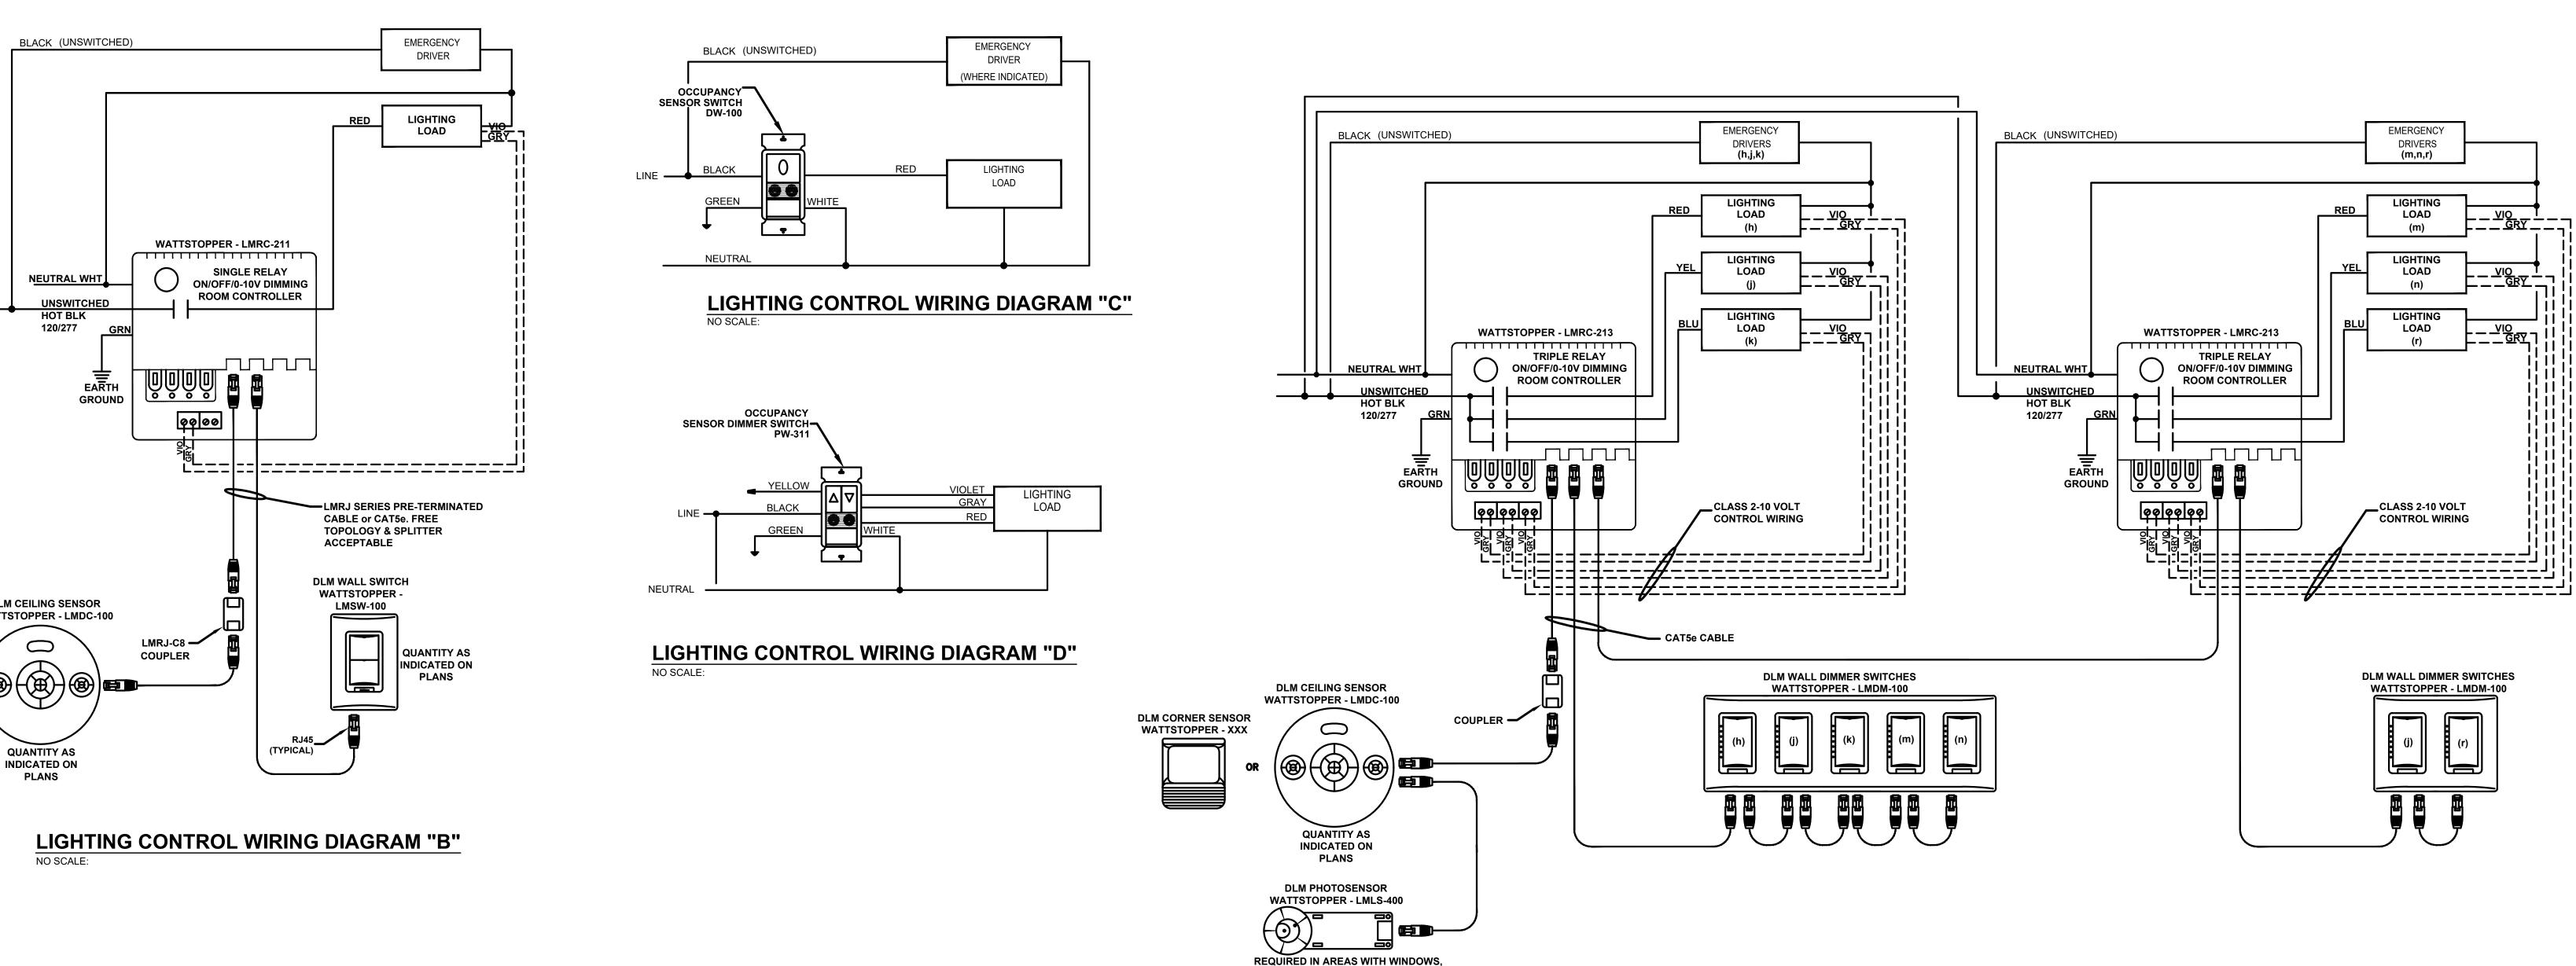

CONNECT TO FIXTURES INDICATED

PROJECT TITLE

PROJECT INFORMATION

MYERSVILLE COMMUNITY **LIBRARY**

> PROJECT ADDRESS **8 HARP PLACE** MYERSVILLE, MD 21773

PROJECT OWNER FREDERICK COUNTY, **MARYLAND** DEPARTMENT OF PUBLIC WORKS



NOELKER

AND HULL ASSOCIATES, INC.

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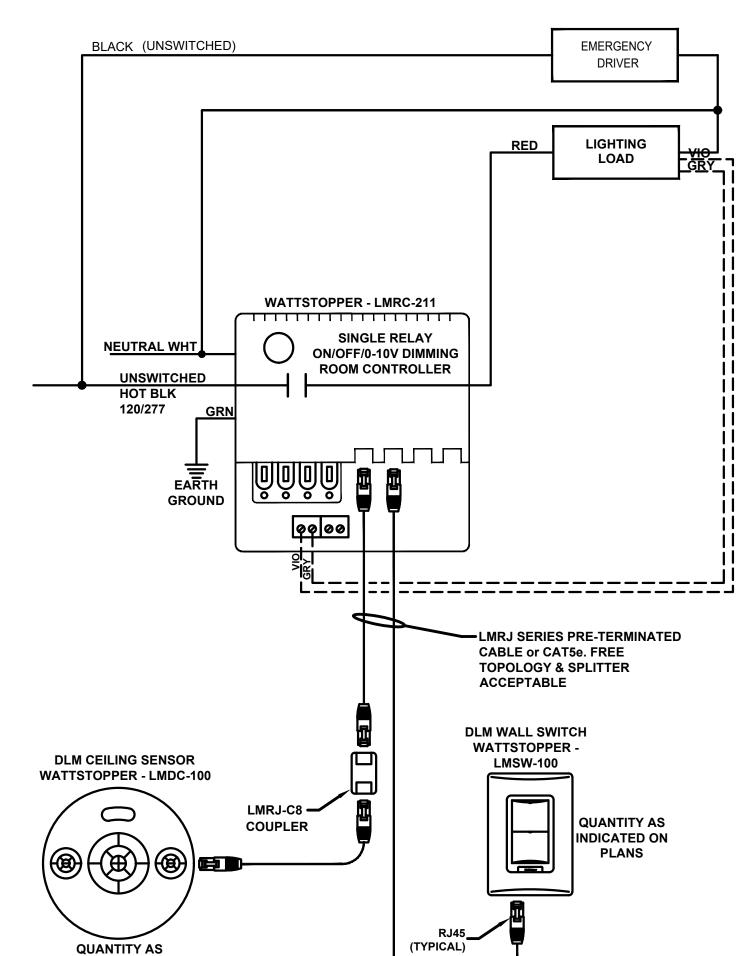
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SHEET INFORMATION


REV. #: DESCRIPTION:


PROJECT STATUS

JOB NUMBER: 16-1043 10 APRIL 2018 ISSUE DATE: **AS INDICATED** SHEET TITLE: LIGHTING SCHEDULE AND **CONTROL DIAGRAMS** SHEET NUMBER: E601 © COPYRIGHT 2018 NOELKER AND HULL ASSOCIATES, INC







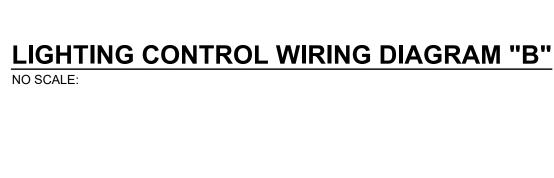

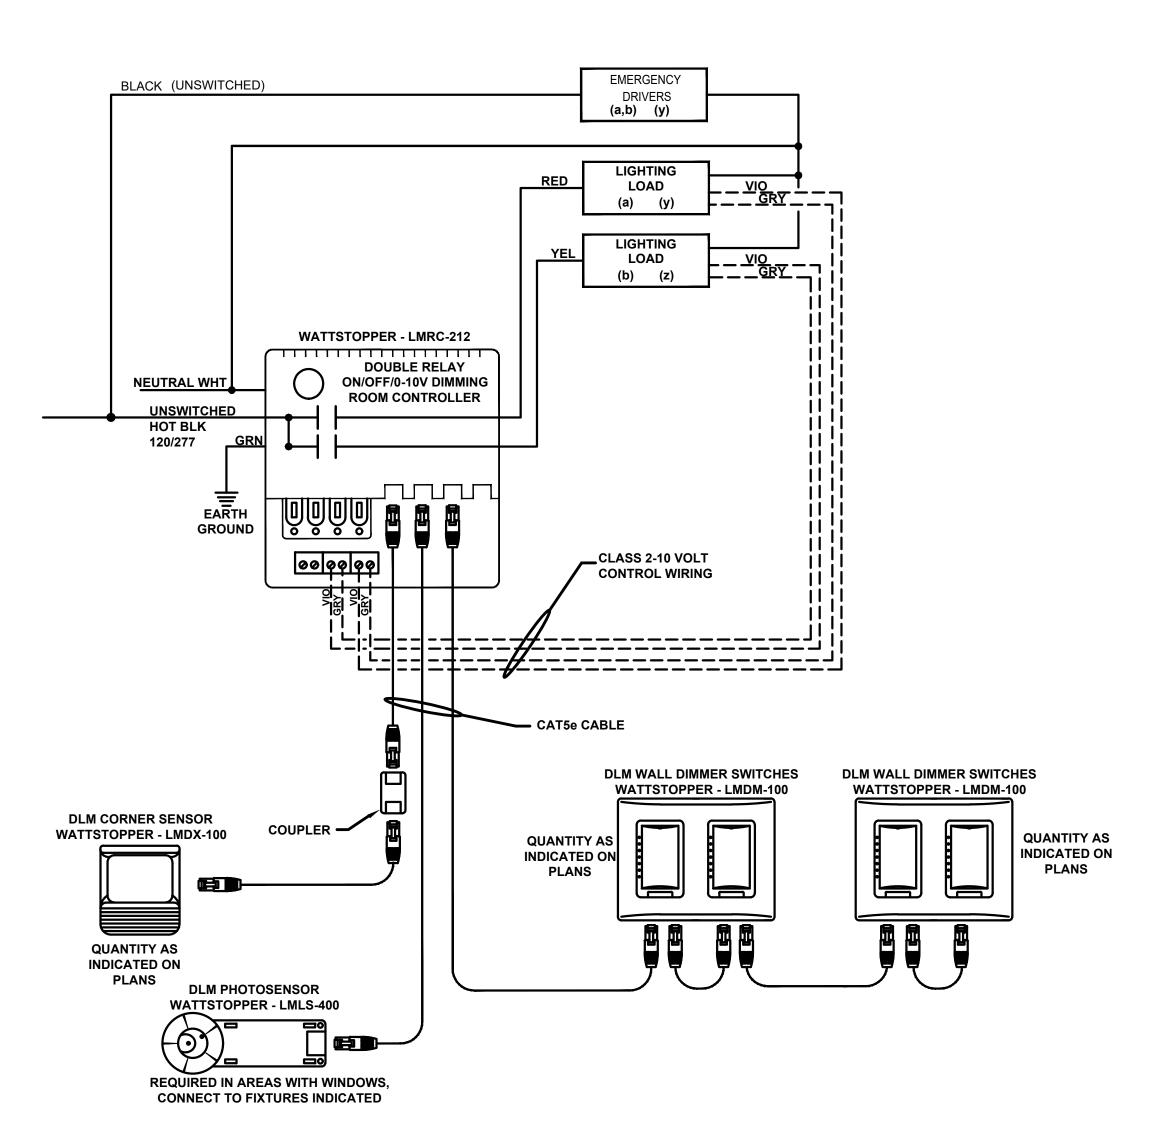

LIGHTING CONTROL WIRING DIAGRAM "G"

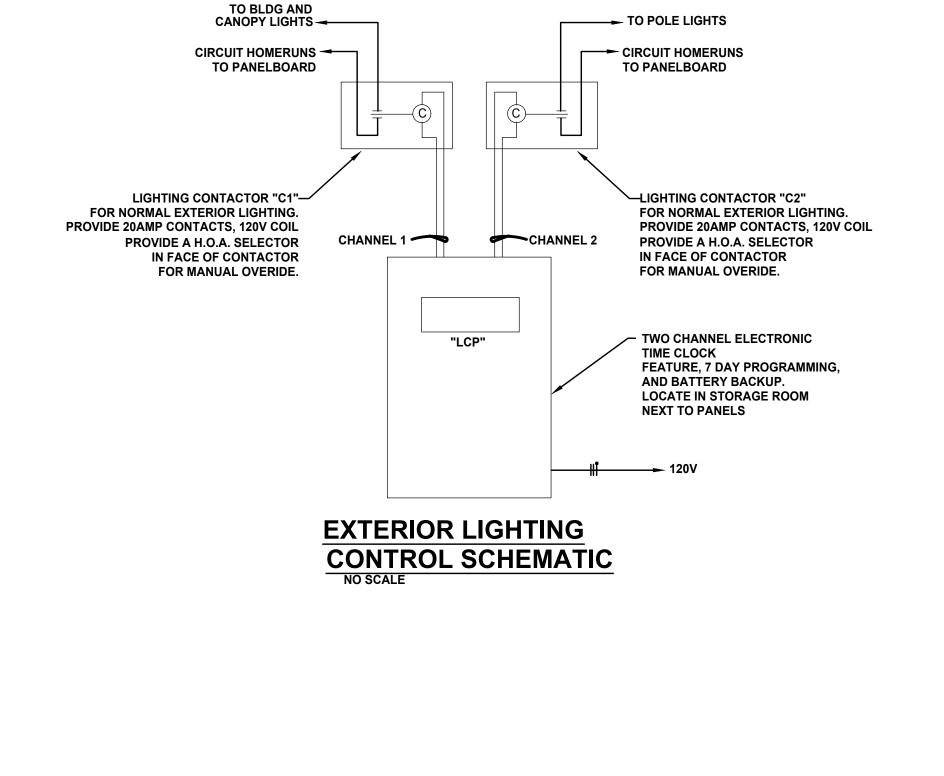

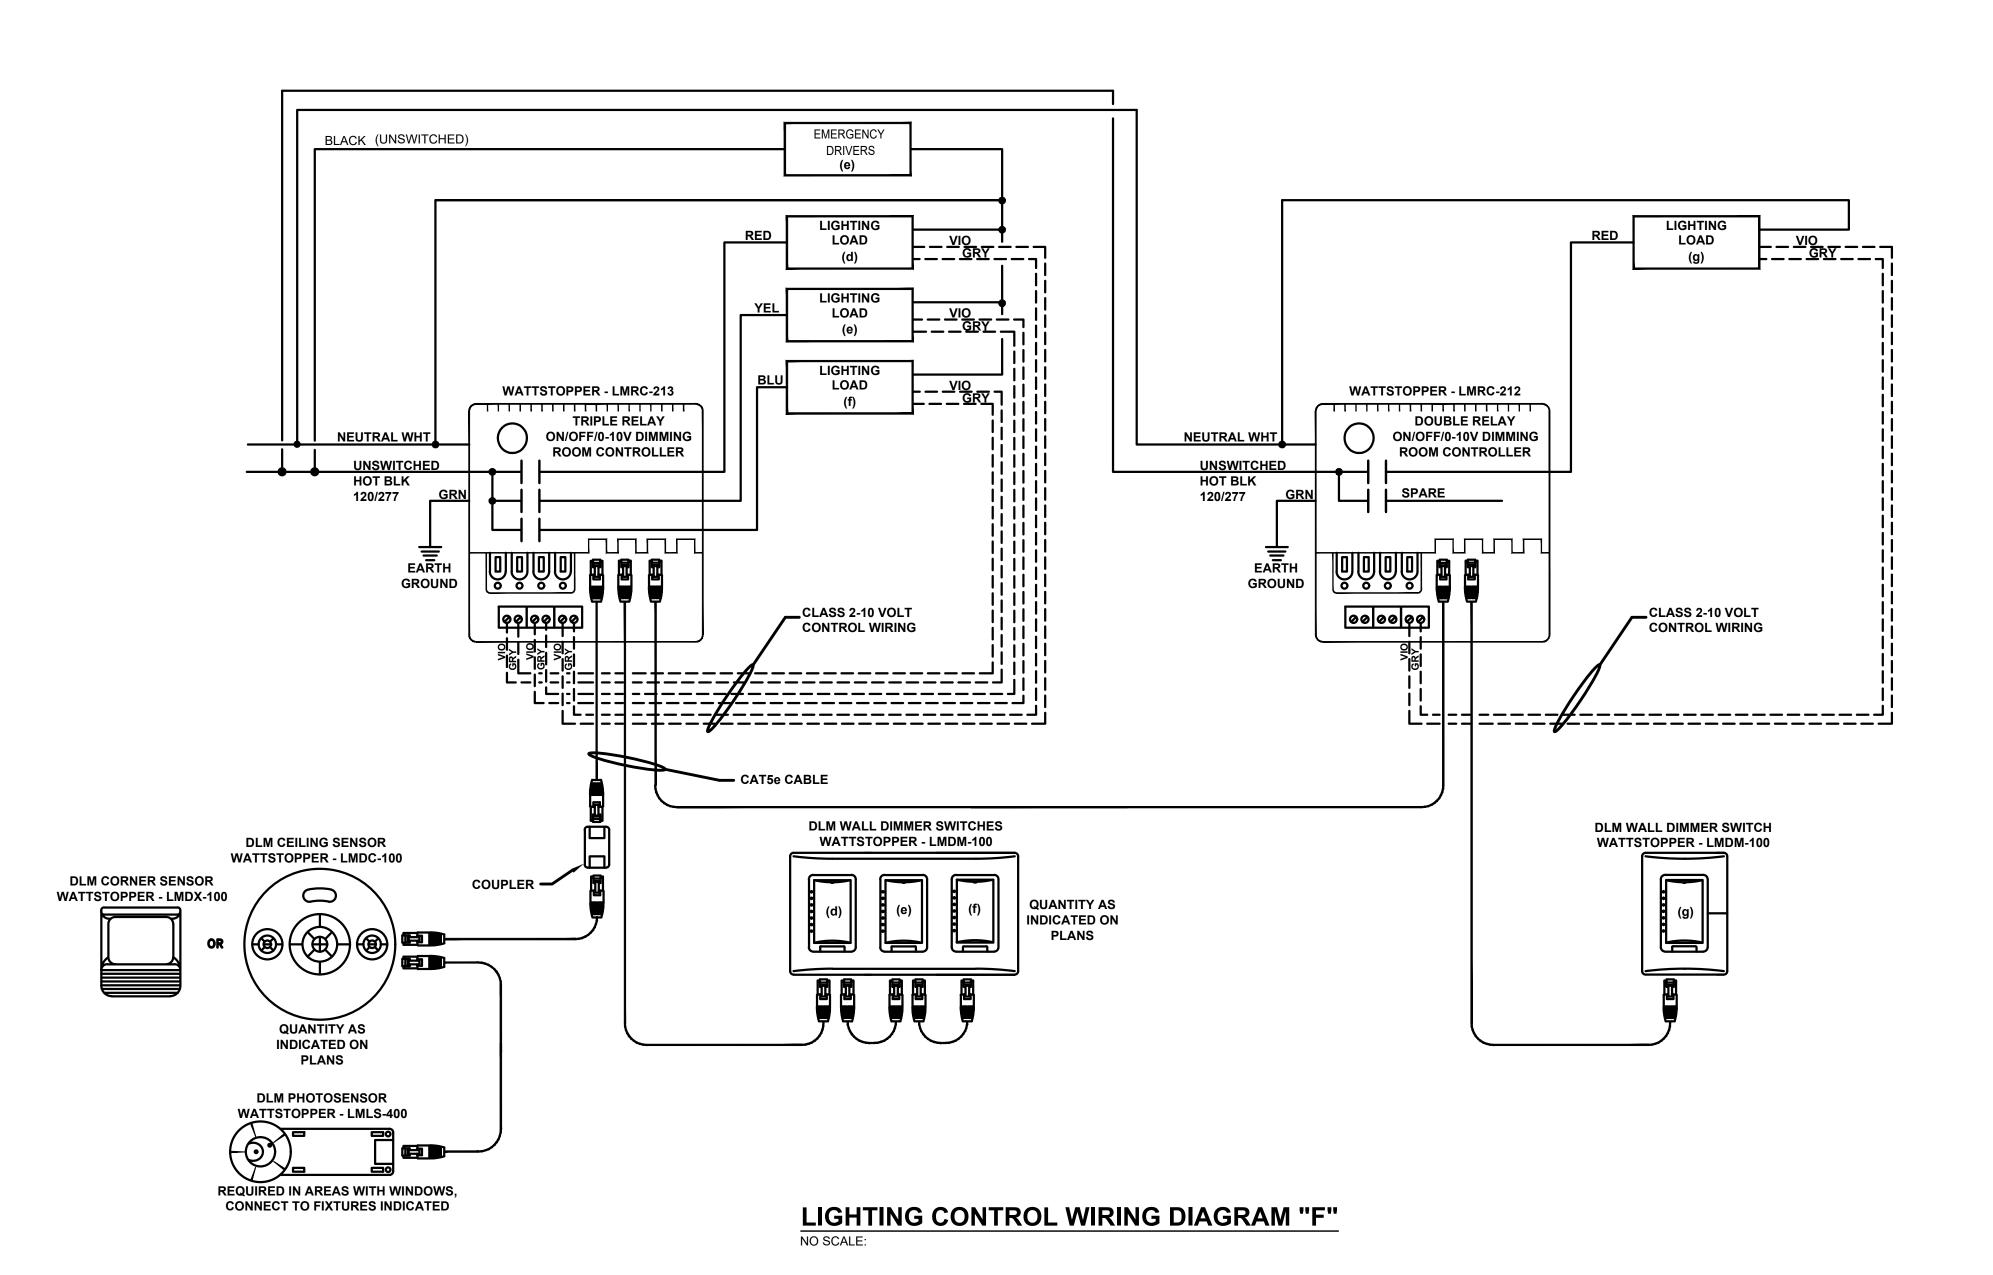

PROJECT TITLE

MYERSVILLE COMMUNITY LIBRARY

PROJECT ADDRESS

8 HARP PLACE

MYERSYILLE MD 21

MYERSVILLE, MD 21773

PROJECT OWNER

FREDERICK COUNTY,
MARYLAND
DEPARTMENT OF PUBLIC
WORKS

PROJECT TEAM



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ASSOCIATES, INC.

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SHEET INFORMATION

REV. #: DESCRIPTION: DATE:
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PROJECT STATUS

JOB NUMBER: 16-1043
ISSUE DATE: 10 APRIL 2018
SCALE:
SHEET TITLE: AS INDICATED


LIGHTING CONTROL DIAGRAMS

SHEET NUMBER:


E602

PANELBOARD DESIGNATION: MDP								INTERRUPTING : 22 KAIC			
LOC	ATION :	MEZZANINE	:	MAIN	NS : 40	OA MCE	3 100% RATED MOU	JNTING: S	SURFACE		
VOL	.TAGE :	120/240V-19	ð-3W	GRO	UND I	BUS : CO	OPPER PAN	EL TYPE :	SQUARE D	ı	
DWG.	LOAD kVA	TRIP POLE	CIRCUIT DESCRIPTION	PANELBOARD DIRECTORY CIRCUIT DESC				DN	TRIP POLE	LOAD kVA	DWG.
NO.		. •==		NO.		NO.			. 5		NO.
1	18.44	100/2	PANEL "PP1"	1		2	HP-1		125/2	21.77	2
3				3		4					4
5	1.3	15/2	ERV-1	5		6	HP-2		80/2	13.48	6
7				7		8					8
9	4.5	30/2	WH-1	9		10	HWCP-1		20/1	0.2	10
11				11		12	LTS: INDOOR		20/1	1.0	12
13	0.20	20/1	FACP	13		14	LTS: INDOOR		20/1	1.0	14
15	1.2	20/1	LTS: POLES	15		16	LTS: EXTERIOR		20/1	0.90	16
17	0.50	20/1	HAND DRYER	17		18	EXTERIOR LIGHT CONTROL F	PANEL	20/1	0.20	18
19	3.2	20/2	AHU'S	19		20	HAND DRYER		20/1	0.50	20
21				21		22	SPARE		20/1		22
23	0.56	20/2	BCC'S	23		24	SNOW SENSORS		20/1	0.20	24
25				25		26	DOAS-1		15/2	1.03	26
27	3.0	20/2	EUH-1	27		28					28
29				29		30	EBB-1		20/2	2.0	30
31	2.0	20/2	EBB-1	31		32					32
33				33		34	EBB-1, EBB-2		20/2	4.0	34
35		20/2	SPARE	35		36					36
37				37		38	ADA DOOR OPERATORS		20/1	0.5	38
39		20/1	SPARE	39		40	SPARE		20/1		40
41		20/1	SPARE	41		42	SPARE		20/1		42
	34.90	:TOTAL						:	TOTAL	46.96	

LOC	ATION :	MEZZANINE	<u>:</u>	MAIN	NS : 10	OA MLO		CAPACITY : 22 KAIC MOUNTING : SURFACE			
VOL	TAGE :	120/240V-19	Ø-3W	GRO	UND E	BUS : C	OPPER PANEL TYPE :	SQUARE I	0		
DWG. CCT. kVA POLE			CIRCUIT DESCRIPTION		ELBO/		CIRCUIT DESCRIPTION	TRIP POLE	LOAD kVA	DWG	
NO.				NO.		NO.				NO.	
1	1.08	20/1	RECEPS: RM 101	1		2	RECEPS: RM 101	20/1	0.54	2	
3	0.72	20/1	RECEPS: RM 109	3		4	RECEPS: RM 109	20/1	0.90	4	
5	0.72	20/1	RECEPS: RM 120	5		6	RECEPS: RM 119	20/1	0.72	(
7	0.90	20/1	RECEPS: RMS 110,118	7		8	RECEPS: RMS 110,116,117	20/1	1.08		
9	1.08	20/1	RECEPS: RM 108 DESK	9		10	RECEPS: 108 BACK WALL	20/1	0.72	1	
11	0.90	20/1	RECEPS: RMS 105,100, EXTERIOR	11		12	RECEPS: EWC (GFI BREAKER)	20/1	0.50	1	
13	0.72	20/1	RECEPS: RMS 107,106	13		14	RECEPS: REFRIGERATOR	20/1	0.50	1	
15	0.36	20/1	RECEPS: RM 111	15		16	RECEPS: RM 111	20/1	0.54	1	
17	0.50	20/1	MICROWAVE	17		18	RECEPS: HAND DRYER 107	20/1	0.50	1	
19	0.50	20/1	RECEPS: HAND DRYER RM 106	19		20	RECEPS: RM 115	20/1	0.90	2	
21	1.08	20/1	RECEPS: RM 111 WORK	21		22	RECEPS: COPIER	20/1	0.50	2	
23	0.18	20/1	RECEPS: RM 111	23		24	RECEPS: JUNCTION BOX	20/1	0.50	2	
25	0.36	20/1	RECEPS: IT RM 112	25		26	RECEPS: IT RM	20/1	0.36	2	
27	0.72	20/1	RECEPS: EXTERIOR RMS 111,121	27		28	RECEPS: OUTDOOR	20/1	0.54	2	
	0.36	20/1	RECEPS: MEZZANINE	29		30	SPARE	20/1		3	

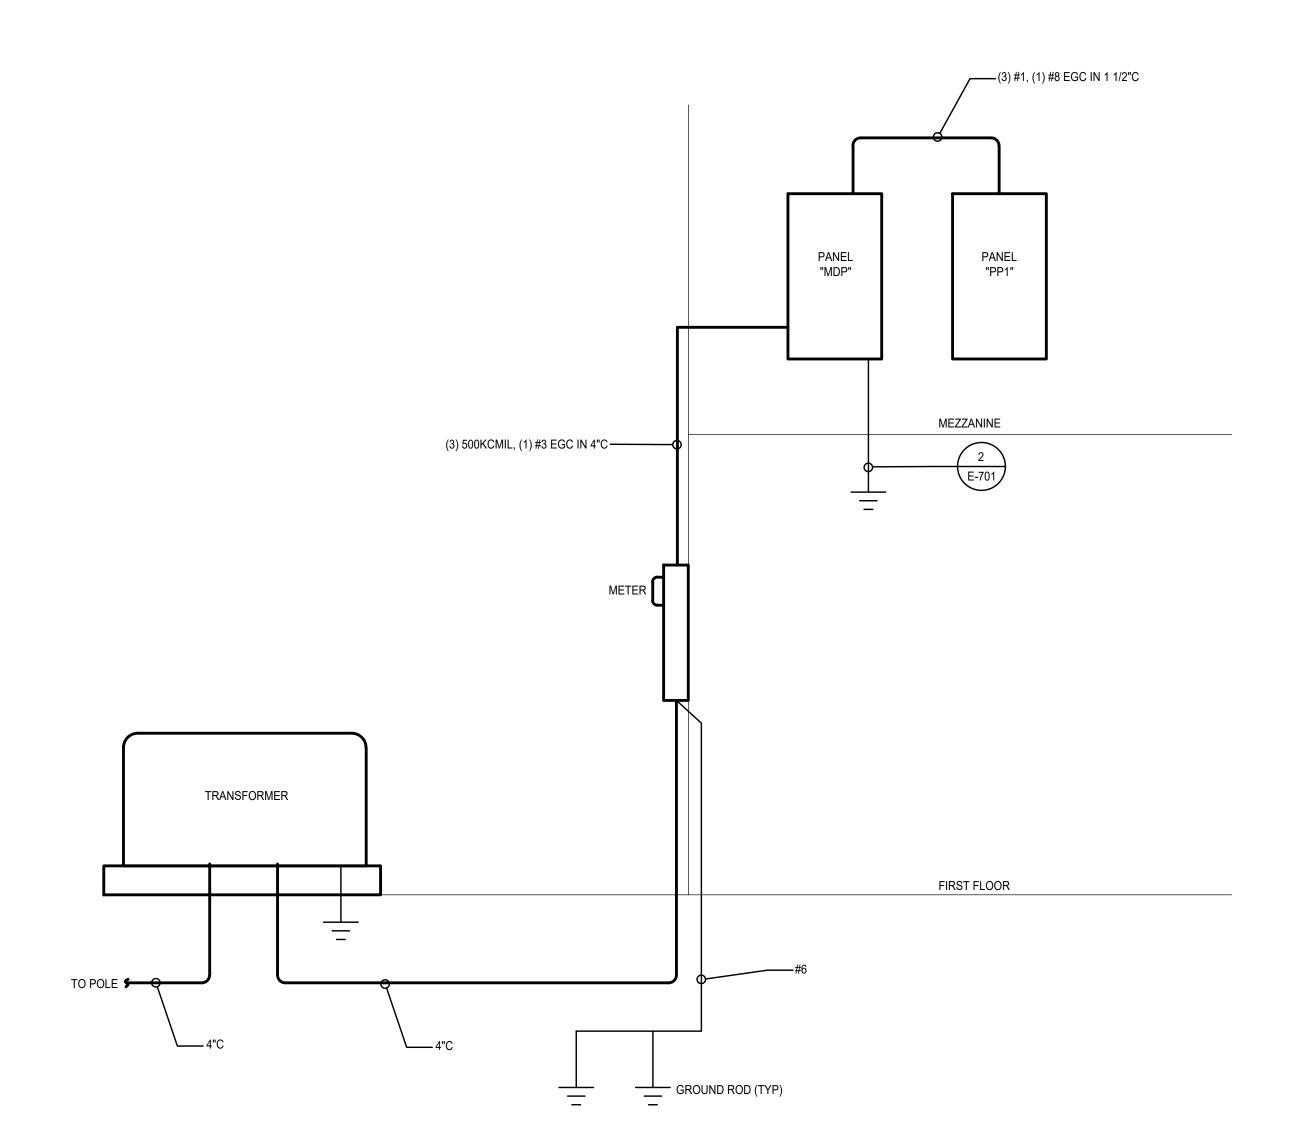



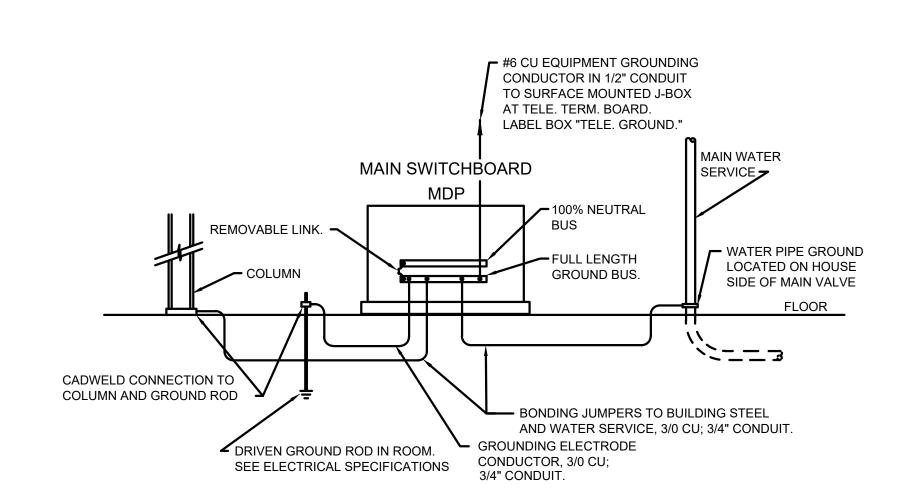

2 SYSTEM GROUNDING DETAIL
E-701 NO SCALE:

PROJECT INFORMATION

PROJECT TITLE

MYERSVILLE COMMUNITY LIBRARY

PROJECT ADDRESS

8 HARP PLACE
MYERSVILLE, MD 21773

PROJECT OWNER

FREDERICK COUNTY,

MARYLAND

DEPARTMENT OF PUBLIC

WORKS

PROJECT TEAM



NOELKER AND HULL ASSOCIATES, INC.

ARCHITECTS

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SHEET INFORMATION

REV. #: DESCRIPTION: DATE:
- - -

PROJECT STATUS

JOB NUMBER: 16-1043
ISSUE DATE: 10 APRIL 2018
SCALE:
SHEET TITLE: AS INDICATED

PANEL SCHEDULES, POWER RISER AND WIRING DIGRAMS

SHEET NUMBER:

E701